ABBREVIATIONS ABOVE FINISHED FLOOR CONCRETE MASONRY UNIT DW DISHWASHER FACE OF POST F.O.S. FACE OF STUD FINISHED FLOOR FLUORESCENT (LIGHT FIXTURE) FIELD VERIFY GSM **GALVANIZED SHEET METAL** GROUND FAULT CIRCUIT GYP. BRE I.B.C. INTERNATIONAL BUILDING CODI INTERNATIONAL CODE COUNCI INTERNATIONAL FIRE CODE INTERNATIONAL MECHANICAL CODE INTERNATIONAL PLUMBING CODE

I.R.C

MICRO

N.E.C.

N.T.S.

O.A.

P.E.N.

PTDF

REF

SPECS.

POOLS, SPA'S & HOT TUBS

SWIMMING POOL IS DEFINED AS ANY CONTAINED BODY OF WATER 18 INCHES (457 MM) AT ANY POINT. THIS INCLUDES IN-GROUND, ABOVE GROUND AND ON-GROUND SWIMMING POOLS AND HOT TUBS AND SPAS. BARRIER REQUIREMENTS

THE PROVISIONS OF THIS CHAPTER SHALL CONTROL THE DESIGN OF BARRIERS FOR RESIDENTIAL SWIMMING POOLS, SPAS AND HOT TUBS. THESE DESIGN CONTROLS ARE INTENDED TO PROVIDE PROTECTION AGAINST POTENTIAL DROWNINGS AND NEAR DROWNINGS BY RESTRICTING ACCESS TO SWIMMING POOLS, SPAS AND HOT TUBS.

AN OUTDOOR SWIMMING POOL, INCLUDING AN IN-GROUND, ABOVE-GROUND OR ON-GROUND POOL, HOT TUB OR SPA SHALL BE SURROUNDED BY A BARRIER WHICH SHALL COMPLY WITH THE FOLLOWING:

THE TOP OF THE BARRIER SHALL BE AT LEAST 60 INCHES (1524 MM) ABOVE GRADE MEASURED ON THE SIDE OF

- THE BARRIER WHICH FACES AWAY FROM THE SWIMMING POOL. THE TOP OF THE BARRIER THAT SEPARATES THE SWIMMING POOL ONLY FROM HABITABLE SPACES ON THE SAME PROPERTY SHALL BE AT LEAST 48 INCHES (1219 MM) ABOVE GRADE MEASURED ON THE SIDE OF THE BARRIER WHICH FACES AWAY FROM THE SWIMMING POOL. THE MAXIMUM VERTICAL CLEARANCE BETWEEN GRADE AND THE BOTTOM OF THE BARRIER SHALL BE 2 INCHES. (51 MM). THE MAXIMUM VERTICAL CLEARANCE AT THE BOTTOM OF THE BARRIER MAY BE INCREASED TO 4 INCHES (102 MM) WHEN GRADE IS A SOLID SURFACE SUCH AS CONCRETE. THE BARRIER SHALL BE AT LEAST 20 INCHES FROM THE WATER'S EDGE.
- OPENINGS IN THE BARRIER SHALL NOT ALLOW PASSAGE OF A 4 INCH DIAMETER (102 MM) SPHERE. ANY DECORATIVE DESIGN WORK SUCH AS PROTRUSIONS, INDENTATIONS OR CUTOUTS WHICH MAKE THE BARRIER
- FASILY CLIMBABLE IS PROHIBITED. SOLID BARRIERS WHICH DO NOT HAVE OPENINGS. SUCH AS MASONRY OR STONE WALL. SHALL NOT CONTAIN INDENTATIONS OR PROTRUSIONS EXCEPT FOR NORMAL CONSTRUCTION TOLERANCES AND TOOLED MASONRY

THERE SHALL BE AT LEAST 45" INCHES BETWEEN HORIZONTAL ELEMENTS

- MAXIMUM MESH SIZE FOR CHAIN LINK FENCES SHALL BE A 2 1/4 INCH (57 MM) SQUARE UNLESS THE FENCE HAS SLATS FASTENED AT THE TOP OR THE BOTTOM WHICH REDUCE THE OPENINGS TO NOT MORE THAN 1 3/4 INCHES WHERE THE BARRIER IS COMPOSED OF DIAGONAL MEMBERS, SUCH AS A LATTICE FENCE, THE MAXIMUM OPENING FORMED BY THE DIAGONAL MEMBERS SHALL NOT BE MORE THAN 1 3/4 INCHES (44MM).
- ACCESS GATES SHALL COMPLY WITH THE REQUIREMENTS OF THIS SECTION, ITEMS 1 THROUGH 6, AND SHALL BI EQUIPPED TO ACCOMMODATE A LOCKING DEVICE. PEDESTRIAN ACCESS GATES SHALL OPEN OUTWARD AWAY FROM THE POOL AND SHALL BE SELF-CLOSING AND HAVE A SELF-LATCHING DEVICE. GATES OTHER THAN PEDESTRIAN ACCESS GATES SHALL BE LOCKABLE. WHERE THE RELEASE MECHANISM OF THE SELF-LATCHING DEVICE IS LOCATED LESS THAN 54 INCHES (1372 MM) FROM THE BOTTOM OF THE GATE, THE RELEASE MECHANISM AND OPENINGS SHALL COMPLY WITH THE FOLLOWING
- 7.1. THE RELEASE MECHANISM SHALL BE LOCATED ON THE POOL SIDE OF THE GATE AT LEAST 3 INCHES (76 MM) BELOW THE TOP OF THE GATE; AND 7.2. THE GATE AND BARRIER SHALL HAVE NO OPENING LARGER THAN 1/2 INCH (13 MM) WITHIN 18 INCHES (457 MM) OF THE RELEASE MECHANISM
- WHERE A WALL OF A DWELLING SERVES AS PART OF THE BARRIER, ONE OF THE FOLLOWING CONDITIONS SHALI 8.1. IN LIEU OF THE BARRIER BETWEEN THE DWELLING AND THE SWIMMING POOL, THE SWIMMING POOL SHALL BE EQUIPPED WITH A POWERED SAFETY COVER IN COMPLIANCE WITH ASTM F1346; OR 8.2. DOORS WITH DIRECT ACCESS TO THE POOL THROUGH THAT WALL SHALL BE EQUIPPED WITH AN ALARM WHICH PRODUCES AN AUDIBLE WARNING WHEN THE DOOR AND/OR ITS SCREEN, IF PRESENT, ARE OPENED. THE ALARM SHALL BE LISTED IN ACCORDANCE WITH UL 2017. THE AUDIBLE ALARM SHALL ACTIVATE WITHIN 7 SECONDS AND SOUND CONTINUOUSLY FOR A MINIMUM OF 30 SECONDS AFTER THI DOOR AND/OR ITS SCREEN. IF PRESENT, ARE OPENED AND BE CAPABLE OF BEING HEARD THROUGHOUT
 - SWITCH, TO TEMPORARILY DEACTIVATE THE ALARM FOR A SINGLE OPENING. DEACTIVATION SHALL LAST FOR NOT MORE THAN 15 SECONDS. THE DEACTIVATION SWITCH(ES) SHALL BE LOCATED AT LEAST 54 INCHES (1372 MM) ABOVE THE THRESHOLD OF THE DOOR; OR 8.3. OTHER MEANS OF PROTECTION, SUCH AS SELF-CLOSING DOORS WITH SELF-LATCHING DEVICES, WHICH ARE APPROVED BY THE GOVERNING BODY. SHALL BE ACCEPTABLE SO LONG AS THE DEGREE OF PROTECTION AFFORDED IS NOT LESS THAN THE PROTECTION AFFORDED BY ITEM 8.1 OR 8.2 DESCRIBED

THE HOUSE DURING NORMAL HOUSEHOLD ACTIVITIES. THE ALARM SHALL AUTOMATICALLY RESET UNDER ALL CONDITIONS. THE ALARM SYSTEM SHALL BE EQUIPPED WITH A MANUAL MEANS, SUCH AS TOUCH PAD OR

- ABOVE. SELF-CLOSING AND SELF LATCHING DEVICES SHALL BE INSTALLED ON ALL DOORS WITH DIRECT ACCESS TO THE POOL AREA, WITH THE RELEASE MECHANISM LOCATED A MINIMUM OF FIFTY-FOUR INCHES
- WHERE AN ABOVE-GROUND POOL STRUCTURE IS USED AS A BARRIER OR WHERE THE BARRIER IS MOUNTED ON TOP OF THE POOL STRUCTURE, AND THE MEANS OF ACCESS IS A LADDER OR STEPS: 9.1. THE LADDER OR STEPS SHALL BE CAPABLE OF BEING SECURED, LOCKED OR REMOVED TO PREVENT ACCESS: OR
- 9.2. THE LADDER OR STEPS SHALL BE SURROUNDED BY A BARRIER WHICH MEETS THE REQUIREMENTS OF THIS SECTION, ITEMS 1 THROUGH 9. WHEN THE LADDER OR STEPS ARE SECURED, LOCKED OR REMOVED, ANY OPENING CREATED SHALL NOT ALLOW THE PASSAGE OF A 4 INCH DIAMETER (102 MM) SPHERE PET DOORS WHICH PROVIDE DIRECT ACCESS TO THE POOL AREA ARE PROHIBITED UNLESS THEY MEET THE REQUIREMENTS OF ITEM 2 OR ARE EQUIPPED WITH AN ALARM THAT MEETS ITEM 8.2.
- WINDOWS WITH ACCESS TO THE POOL AREAS WILL BE PROTECTED IN THE FOLLOWING WAYS: 11.1 EMERGENCY ESCAPE OR RESCUE WINDOWS FROM SLEEPING AREAS WITH ACCESS TO THE SWIMMING POOL WILL BE FOUIPPED WITH A LATCHING DEVICE NOT LESS THAN 54 INCHES (1372 MM) ABOVE THE FLOOR 11.2 ALL OTHER OPENABLE WINDOWS WITH SIMILAR ACCESS WILL ALSO BE FOLIPPED WITH A LATCHING DEVICE NOT LESS THAN 54 INCHES (1372 MM) ABOVE THE FLOOR OR SHALL BE EQUIPPED WITH KEY LOCK DEVICE THAT PREVENTS OPENING THE WINDOW MORE THAN 4 INCHES (102 MM).

WALLS SURROUNDING AN INDOOR SWIMMING POOL SHALL COMPLY WITH ITEM 8.

BARRIERS SHALL BE LOCATED TO PROHIBIT PERMANENT STRUCTURES, EQUIPMENT OR SIMILAR OBJECTS FROM

SPAS OR HOT TUBS WITH A SAFETY COVER WHICH COMPLIES WITH ASTM F 1346 SHALL BE EXEMPT FROM THE PROVISIONS OF THIS SECTION

FIRE SPRINKLERS

- 02. A WATER METER W/ DOMESTIC LINE AS REQUIRED FOR C.O.S. I'S & A'S, SECT 8.1.1.3 RESIDENTIAL FIRE
- 03. A SEPARATE PERMIT IS REQUIRED FROM THE FIRE DEPT. FOR FIRE SPRINKLER SYSTEM
- 04. MEET PROVISIONS OF 2015 IFC AMMENDMENTS ORD. 4045 AND SRC 36-18 AUTOMATIC FIRE SPRINKLEF

JACUZZI TYPE TUB

- 01. PROVIDE REMOVABLE PANEL OF SUFFICIENT SIZE TO ACCESS PUMP
- 02. CIRCULATION PUMP SHALL BE LOCATED ABOVE THE CROWN WEIR OF THE TRAP.
- 03. PUMP AND CIRCULATION PIPING SHALL BE SELF-DRAINING
- 04. SUCTION FITTINGS SHALL COMPLY WITH THE LISTED STANDARDS.
- 05. PROVIDE G.F.I. CIRCUIT (N.E.C. ARTICLE 680-70)

AG104 SPAS AND HOT TUBS

INTERNATIONAL RESIDENTIAL CODE

MANUFACTURER

NOT TO SCALE

PER LINEAR FOOT

SPECIFICATIONS

STAINLESS STEEL

TRASH COMPACTOR

WATER CLOSET

WATER PROOF

WROUGHT IRON

UNLESS OTHERWISE NOTED

MICROWAVE OVEN

NATIONAL ELECTRIC CODE

PERIMETER EDGE NAILING

RISER (ie 16R=16 RISERS

PRESSURE TREATED DOUGLAS FIF

FOR A NONSELF-CONTAINED AND SELF-CONTAINED SPA OR HOT TUB, PROTECTION SHALL COMPLY WITH THE

EXCEPTION: A SELF-CONTAINED SPA OR HOT TUB EQUIPPED WITH A LISTED SAFETY COVER SHALL BE EXEMP FROM THE REQUIREMENTS OF SECTION 103.1.

REQUIRED RESIDENTIAL NOTES

- 11. ALL PRODUCTS LISTED BY LC C /N F.R. NUMBER(S) SHALL BE INSTALLED PER THE REPORT AND MANUFACTURER'S WRITTEN INSTRUCTIONS. PRODUCTS SUBSTITUTIONS FOR PRODUCT(S) LISTED SHALL ALSO HAVE AN ICC APPROVED
- 02. EXTERIOR WALL, BOTTOM SILL PLATES, SHALL BE PRESSURE TREATED OR EQUAL, AND SHALL BEAR/EXTEND MINIMUM
- 03. MISCELLANEOUS SITE STRUCTURES, POOLS, SPAS, FENCES, SITE WALLS, RETAINING WALLS, AND GAS STORAGE TANKS
- $^{04.}\,$ ALL EXITS TO BE OPERABLE FROM THE INSIDE WITHOUT THE USE OF A KEY OR SPECIAL KNOWLEDGE
- 05. DOORS LEADING INTO HOUSE FROM GARAGE SHALL BE SELF-CLOSING, SELF-LATCHING
- D6. EXTERIOR WALL PENETRATIONS BY PIPES, DUCTS OR CONDUITS SHALL BE CAULKED. (2015 IRC R302.4.1
- 08. ENERGY CONSERVATION REQUIREMENTS: CEILING/ATTIC R-VALUE = R-38 (MIN.), FRAME WALL R-VALUE =R-19 (MIN.), MASONRY WALL R-VALUE = R-4 (MIN.), WINDOW U-VALUE = 0.40 (MAX.), SOLAR HEAT GAIN COEFFICIENT = 0.25 (MAX.),
- 09. LUMBER SHALL BEAR AN APPROVED GRADING STAMP. (R502.1

SUPPLY AND RETURN AIR DUCT INSULATION VALUE OF R-8(MIN.

- 2. WINDOWS LOCATED MORE THAN 72" ABOVE FINISHED GRADE SHALL HAVE THE LOWEST PART OF CLEAR OPENING OF THE WINDOW TO BE MINIMUM 24 INCHES ABOVE THE FLOOR IN WHICH IT SERVES (R613.2)
- SUM BOARD APPLIED TO A CEILING SHALL BE 1/2" WHEN FRAMING MEMBERS ARE 16" O.C. OR 5/8" WHEN FRAMING! MEMBERS 24" O.C. OR USE LABELED 1/2" SAG-RESISTANT GYPSUM CEILING BOARD. TABLE R702.3.5 (d)
- 15. SHOWER AREA WALLS SHALL BE FINISHED WITH A SMOOTH, HARD NON-ABSORBENT SURFACE, SUCH AS CERAMIC TILL TO A HEIGHT OF NOT LESS THAN 72 INCHES ABOVE THE DRAIN INLET. WATER-RESISTANT GYPSUM BOARD SHALL NOT RE INSTALLED OVER A VAPOR RETARDER IN A SHOWER OR THE COMPARTMENT. CEMENT, FIRER-CEMENT OR CLASS MAT GYPSUM BACKERS INSTALLED WITH MANUFACTURER'S RECOMMENDATIONS SHALL BE USED AS BACKERS FOR
- 16. PLUMBING FIXTURES SHALL COMPLY WITH THE FOLLOWING CONSERVATION REQUIREMENTS: TABLE P2903.2 WATER CLOSETS- TANK TYPE 1.6 GAL/FLUSH, SHOWER HEAD - 2.5 GAL/MINUTE, FAUCETS - 2.2 GAL/MINUTE PROVIDE
- 17. WATER TREATMENT SYSTEMS SHALL BE EQUIPPED WITH AND AUTOMATIC SHUTOFF TO PREVENT CONTINUOUS FLOW
- 18. DOMESTIC DISH WASHING MACHINES CONNECTED TO A DISPOSER SHALL HAVE THE DISCHARGE INSTALLED AS HIGH AS
- 19. HOT WATER RECIRCULATION PUMPS. PROVIDE A HOT WATER DEMAND CONTROLLED RECIRCULATION PUMP FOR WATER HEATERS LOCATED MORE THAN 20 FEET FROM FURTHEST FIXTURE SERVED. A MANUAL CONTROL OR OCCUPANT SENSOR SWITCH SHALL OPERATE THE PUMP WITH AN AUTOMATIC TEMPERATURE SENSOR SHUT-OFF
- 20. SUPPLY AND RETURN DUCTS SHALL BE INSULATED TO A MINIMUM R-8. DUCTS IN FLOOR TRUSSES SHALL BE INSULATED
- 21. REGISTERS, DIFFUSERS AND GRILLES SHALL BE MECHANICALLY FASTENED TO RIGID SUPPORTS OR STRUCTURAL
- 22. THE CLOTHES DRYER SHALL BE PROVIDED WITH A 4-INCH DIAMETER EXHAUST DUCT TO THE EXTERIOR AND SHALL NOT

MEMBERS ON AT LEAST TWO OPPOSITE SIDES IN ADDITION TO BEING CONNECTED TO THE DUCTWORK THEY SERVE

23. EXHAUST AIR FROM KITCHENS, BATHROOMS AND TOILET ROOMS SHALL NOT BE RE-CIRCULATED WITHIN A RESIDENCE OR TO ANOTHER DWELLING UNIT AND SHALL BE EXHAUSTED DIRECTLY TO THE OUTDOORS, EXHAUST AIR FROM KITCHENS, BATHROOMS AND TOILET ROOMS SHALL NOT DISCHARGE INTO AN ATTIC, CRAWL SPACE OR OTHER AREAS INSIDE THE BUILDING, M1506.2

EXCEED A TOTAL LENGTH OF 35 FEET, UNLESS AN ENGINEERED DUCT SYSTEM IS PROVIDED (M1501.3)

- 24. PROVIDE IC-RATED RECESSED LIGHT FIXTURES INSTALLED IN INSULATED CEILINGS (N1102.4.3)
- 25. FIXTURES LOCATED IN DAMP OR WET LOCATIONS SHALL BE "LISTED" TO BE SUITABLE FOR SUCH LOCATION. (E3903.8) 26. PROVIDE GFCI PROTECTION FOR RECEPTACLES WITHIN 6' OF ALL LAVATORIES. SINKS AND BASINS. (E3802.7)
- 27. PROVIDE GFCI PROTECTED RECEPTACLES AT AL EXTERIOR, BATHROOM AND GARAGE LOCATIONS. (E3802.1, .2) 28. PROVIDE A WALL MOUNTED GFCI PROTECTED RECEPTACLE OUTLET WITHIN 36" OF A BATHROOM OR POWDER ROOM
- 29. ALL 120-VOLT BRANCH CIRCUITS IN FAMILY ROOMS, DINING ROOMS, LIVING ROOMS, PARLORS, LIBRARIES, DENS, BEDROOMS, SUN ROOMS, RECREATION ROOMS, CLOSETS, HALLWAYS AND SIMILAR ROOMS OR AREAS SHALL BE PROTECTED BY A COMBINATION TYPE AFCI (E3802.11)
- 30. RECEPTACLE OUTLETS SHALL BE INSTALLED SO THAT NO POINT ALONG THE FLOOR LINE IN ANY WALL SPACE IS MORE THAN 6 FEET, MEASURED HORIZONTALLY, FROM AN OUTLET IN THAT SPACE, INCLUDING ANY WALL SPACE 2 FEET OR
- 31. PROVIDE A MINIMUM OF TWO 20-AMP SMALL APPLIANCE BRANCH CIRCUITS FOR THE KITCHEN/DINING/BREAKFAST.
- 32. THE TWO OR MORE 20-AMPERE SMALL APPLIANCE BRANCH CIRCUITS SHALL HAVE NO OTHER OUTLETS, EXCEPT THE RECEPTACLE INSTALLED SOLELY FOR ELECTRIC SUPPLY TO AN ELECTRICAL CLOCK IN THE KITCHEN/DINING/BREAKFAST AREAS OR RECEPTACLES FOR SUPPLEMENTAL EQUIPMENT AND LIGHTING FOR GAS-FIRED RANGES, OVENS OR COUNTER MOUNTED UNITS. (E3603.2)
- 33. RECEPTACLE OUTLETS FOR RANGES AND CLOTHES DRYERS SHALL BE 3-POLE WITH GROUND TYPE. FOUR-WIRE, GROUNDING -TYPE FLEXIBLE CORDS WILL BE REQUIRED FOR CONNECTION OF RANGES AND CLOTHES DRYERS. THE BONDING JUMPER SHALL NOT BE CONNECTED BETWEEN THE NEUTRAL TERMINAL AND THE FRAME OF THE APPLIANCE. FLEXIBLE CORDS SHALL BE USED ONLY WHERE THE FLEXIBLE CORD SUPPLYING AN APPLIANCE SHALL TERMINATE IN A GROUNDING-TYPE ATTACHMENT PLUG. (E4001.3)
- 34. PROVIDE A CONCRETE ENCASED GROUNDING ELECTRODE OF NOT LESS THAN 20 FEET OF #4 BARE COPPER (200
- 35. PROVIDE BONDING TO THE WATER PIPING, GAS AND METAL BUILDING SYSTEMS. (MINIMUM #4 FOR 200-AMP SERVICE
- 36. ALL METAL PIPING SYSTEMS, METAL PARTS OF ELECTRICAL EQUIPMENT, AND PUMP MOTORS ASSOCIATED WITH THE HYDRO MASSAGE TUB SHALL BE BONDED TOGETHER USING A COPPER BONDING JUMPER, INSULATED, COVERED, OR BARE, NOT SMALLER THAN NO. 8 SOLID. METAL PARTS OF LISTED EQUIPMENT INCORPORATING AN APPROVED SYSTEM OF DOUBLE INSULATION AND PROVIDING A MEANS FOR GROUNDING INTERNAL NON-ACCESSIBLE. NON-CURRENT-CARRYING METAL PARTS SHALL NOT BE BONDED (E4104.2, .4)
- 37. R607.2.1 MASONRY BED AND HEAD JOINTS...SHALL BE 3/8" THICK, THE THICKNESS OF THE BED JOINT OF THE STARTING COURSE PLACED OVER FOUNDATIONS SHALL NOT BE LESS THAN 1/4" INCH AND NOT MORE THAN 3/4 INCH. MORTAR JOINT THICKNESS SHALL BE WITHIN THE FOLLOWING TOLERANCES FROM THE SPECIFIED DIMENSIONS: 1. BED JOINT + 1/8 INCH 2. HEAD JOINT: 1/4 INCH + 3/8 INCH
- 38. PROVIDE COMBUSTION AIR TO ALL FIREPLACES IN ALL LOCATIONS WITH AIR INTAKE LOCATED AT AN ELEVATION NO HIGHER THAN THE FIREBOX. (R1006.1)

PERSPECTIVE VIEW



GENERAL NOTES

- BUILDING CODE DESIGN DATA ALL CONSTRUCTION WITHIN PARADISE VALLEY SHALL COMPLY WITH THE FOLLOWING CODES AND AMMENDMENTS PER THEIR ADOPTING ORDINANCES:
 - 2015 INTERNATIONAL BUILDING CODE 2015 INTERNATIONAL RESIDENTIAL CODE

 - 2015 INTERNATIONAL MECHANICAL CODE 2014 NATIONAL ELECTRICAL CODE
 - 2015 INTERNATIONAL PROPERTY MAINTENANCE CODE 2015 INTERNATIONAL ENERGY CONSERVATION CODE 2015 INTERNATIONAL FUEL GAS CODE
- D2. CLIMATIC AND GEOGRAPHIC DESIGN CRITERIA TABLE R301.2 (1) AMENDED

١.									
	ROOF SNOW LOAD	WIND	SEISMIC DESIGN CATEGORY f,g	SUBJECT TO DAMAGE FROM				WINTER DESIGN TEMP.f	FLOOD HAZARDS ^h
		SPEED (MPH)		WEATHERING®	FROST LINE DEPTH ^b	TERMITE	DECAYd		
	0	115 EXPOSURE B			12" BELOW FINAL GRADE		NONE TO SLIGHT	-	NFIP 040049

- DRAWINGS MAY NOT BE SCALED, ALL DIMENSIONS RELATED TO DETAILS NOT SPECIFICALLY SHOWN, SHALL BE O THE SAME NATURE AS OTHER SIMILAR CONDITIONS, VERIFY ALL DIMENSIONS PRIOR TO STARTING WORK
- THE CONTRACTOR SHALL NOTIFY BOWMAN DESIGN GROUP OF ANY DISCREPANCIES ON DRAWINGS. REQUIRING CLARIFICATION OR REVISIONS PRIOR TO COMMENCING WITH WORK
- ALL CHIMNEYS SHALL HAVE APPROVED SPARK ARRESTORS.
- ANY ENGINEERING DESIGN PROVIDED BY OTHERS AND SUBMITTED FOR REVIEW, SHALL BEAR THE SEAL AND SIGNATURE OF AN ENGINEER REGISTERED IN ARIZONA
- FINISH FLOOR ELEVATION (AS BUILT) SHALL BE CERTIFIED BY THE CITY FOR THE FEDERAL EMERGENCY
- 08. OPTIONS ARE FOR THE CONTRACTORS CONVENIENCE. THEY SHALL BE RESPONSIBLE FOR ALL CHANGES NECESSARY IF THEY CHOOSE AN OPTION AND SHALL COORDINATE ALL DETAILS. THE COST OF ADDITIONAL DESIGN WORK NECESSITATED BY SELECTION OF AN OPTION SHALL BE BORNE BY THE CONTRACTOR.
- 09. THE COST OF ADDITIONAL DESIGN WORK DUE TO ERRORS OR OMISSIONS IN CONSTRUCTION SHALL BE INCURRED
- DETAILS ON THE STRUCTURAL DRAWINGS ARE TYPICAL. VERIFY ALL DIMENSIONS WITH THE DESIGNER'S DRAWINGS. NO STRUCTURAL CHANGES FROM THE APPROVED PLANS SHALL BE MADE IN THE FIELD. UNLESS PRIOR TO MAKING CHANGES, WRITTEN APPROVAL IS OBTAINED FROM THE ENGINEER. IF CHANGES ARE MADE WITHOUT APPROVAL. SUCH CHANGES SHALL BE THE LEGAL AND FINANCIAL RESPONSIBILITY OF THE CONTRACTOR OR SUBCONTRACTOR INVOLVED AND IT SHALL BE THEIR RESPONSIBILITY TO REPLACE OR REPAIR

SCOPE OF WORK

THIS PROJECT IS AN EXISTING SINGLE STORY 4 BEDROOM PLUS STUDY, 2 AND A HALF BATHROOM, 2 CAR GARAGE RESIDENTIAL BUILDING THAT IS TO BE REMODELED WITH AN ADDITION TO BE A 3 BEDROOM PLUS STUDY, 3 BATHROOM, 4 CAR GARAGE RESIDENTIAL BUILDING

VICINITY MAP



SQUARE FOOTAGES

LIVABLE:	4,278 SF
GUEST HOUSE LIVABLE:	836 SF
TOTAL LIVABLE:	5,114 SF
GARAGE/MECH/STORAGE:	1,075 SF
GUEST HOUSE STORAGE:	180 SF
TOTAL GARAGE/MECH/STORA	AGE: 1,255 SF
COVERED PATIOS (FRONT/BA	ACK): 1,044 SF
GUEST HOUSE COVERED PAT	TIO: 535 SF
TOTAL COVERED PATIOS:	1,579 SF
TOTAL UNCOVERED PATIO:	280 SF
OVERHANGS:	260 SF
NET LOT AREA:	1.01 ACRES = 43,573 SF

SHEET INDEX

A0.1 COVER SHEET

GD100 GRADING AND DRAINAGE PLAN

L2 LANDSCAPE PLAN

ALLOWABLE F.A.R. (25%)

PROPOSED LOT COVERAGE:

TOTAL FLOOR AREA RATIO

A0.2 LAND SURVEY

A0.3 PROPERTY PHOTOS

A0.5 SITE CROSS SECTIONS

A1.1 ARCH. SITE PLAN

A1.1c LIGHTING PLAN

A1.1d HILLSIDE APPROVAL - EXHIBIT

A1.2 OPEN SPACE DIAGRAM

A1.3 OPEN SPACE SECTIONS

A2.2 GUEST HOUSE

A3.1 REFLECTED CEILING PLAN

A4.1 ROOF PLAN

A5.1 BUILDING SECTIONS

A9.1 DOOR & WINDOW DETAILS

BOWMAN

ARCHITECTURE | PLANNING | DESIGN

JOHN MITCHELL 5001 E MCDONALD DR

ARCH<u>ITECTURE</u>

BOWMAN DESIGN GROUP 7150 E CAMELBACK RD, SUITE 444 SCOTTSDALE, AZ 85251

CIVIL ENGINEER WERK URBAN DESIGN 455 N 3RD ST, SUITE 1010

MPE ENGINEER

P.O. BOX 718 GILBERT, AZ 85299 480.497.5178 GREG@EFFMECH.COM

TONY@AVOMOS.COM

L1 LANDSCAPE PLAN

A0.4 PROPERTY RENDERINGS

A0.6 MATERIAL BOARD

A1.1a ARCH. SITE PLAN A1.1b ARCH. SITE PLAN

A2.1 FLOOR PLAN

A6.1 EXTERIOR ELEVATIONS

A8.1 DOOR & WINDOW SCHEDULE

E2.1 ELECTRIC PLAN

PARADISE VALLEY, AZ 85253 480.760.5727 IUMITCHELL02@YAHOO.COM

480.702.3900 INFO@BOWMANDESIGN.CO

PHOENIX, AZ 85004 602.429.9922 EXT: 700 NEIL@WERKURBANDESIGN.COM

EFFICIENCY MECHANICAL

CONTRACTOR RAINMAKER CONSTRUCTION/AVOMOS 2802 E WASHINGTON ST PHOENIX, AZ 85034 480.265.7434

10 893 SF

8,488 SF

10,033 0

172-04-009

SITE AREA: 43,573 (1.01 AC.) **LEGAL ADDRESS: 5001 E MCDONALD DR.**

PARADISE VALLEY, AZ 85253

DATE

CAMELBACK ESTATE

COVER SHEET

Project number 19-12 11/12/2020 Drawn by Checked by

12" = 1'-0" Scale

6.ALL EXTERIOR SITE LIGHTING SHALL COMPLY WITH THE APPLICABLE REQUIREMENTS FOR TYPE. LOCATION.

TOWN OF PARADISE VALLEY ZONING ORDINANCE FOR NON-HILLSIDE PROPERTIES, SECTION 2208 OF THE TOWN OF

7.A DUST CONTROL PLAN AND PERMIT MEETING THE REQUIREMENTS OF RULE 310 OF THE MARICOPA COUNTY AIR POLLUTION CONTROL REGULATIONS, AS AMENDED, IS REQUIRED.

8.A SEPARATE RIGHT-OF-WAY PERMIT IS NECESSARY FOR ANY OFF-SITE CONSTRUCTION.

9.AN APPROVED GRADING AND DRAINAGE PLAN SHALL BE ON THE JOB SITE AT ALL TIMES. DEVIATIONS FROM THE PLAN MUST BE PRECEDED BY AN APPROVED PLAN REVISION.

10.EAVE PROJECTIONS INTO REQUIRED SETBACKS ARE LIMITED TO A MAXIMUM OF 24" PURSUANT TO SECTION 1008 OF THE TOWN OF PARADISE VALLEY ZONING ORDINANCES. 11.ALL STRUCTURES AND LANDSCAPING WITHIN THE SIGHT VISIBILITY TRIANGLE SHALL HAVE A 2 FOOT MAXIMUM

12.ALL NEW AND EXISTING ELECTRICAL SERVICE LINES SHALL BE BURIED PER THE TOWN OF PARADISE VALLEY

COSTS OF ALL UTILITIES. AND TO SUBMIT A UTILITY RELOCATION SCHEDULE PRIOR TO THE ISSUANCE OF AN

14.EXISTING AND/OR NEW UTILITY CABINETS AND PEDESTALS SHALL BE LOCATED A MINIMUM OF 4' BEHIND

ULTIMATE BACK OF CURB LOCATION

16.POOLS SHALL BE CONSTRUCTED BY SEPARATE PERMIT AND SECURED FROM UNWANTED ACCESS PER TOWN

17.ALL FILL MATERIAL UNDER SLABS AND WALKS SHALL BE COMPACTED TO NOT LESS THAN 95%.

18.SETBACK CERTIFICATION IS REQUIRED AND SHALL BE PROVIDED TO TOWN INSPECTOR PRIOR TO STEM WALL 19.FOR BUILDING PADS THAT HAVE 1' OR MORE OF FILL MATERIAL, SOILS COMPACTION TEST RESULTS ARE

REQUIRED AND SHALL BE PROVIDED TO TOWN INSPECTOR PRIOR TO PRE-SLAB INSPECTION. 20.FINISHED FLOOR ELEVATION CERTIFICATION IS REQUIRED AND SHALL BE PROVIDED TO TOWN INSPECTOR

PRIOR TO FRAMING INSPECTION. 21.MAIL BOXES SHALL COMPLY WITH THE TOWN OF PARADISE VALLEY STANDARDS FOR MAIL BOXES IN THE

RIGHTOF-WAY FOR HEIGHT, WIDTH AND BREAK AWAY FEATURES. 22.ALL PATIOS, WALKS, AND DRIVES TO SLOPE AWAY FROM BUILDING AND GARAGES AT A MINIMUM SLOPE OF 1/4"

PER FOOT UNLESS SPECIFIED OTHERWISE

MAXIMUM OF 6 FEET IN HEIGHT FROM GRADE TO TOP OF THE SIGN. THE SIGN MUST INCLUDE THE PERMITTEE OR COMPANY NAME, PHONE NUMBER. TYPE OF WORK, ADDRESS OF PROJECT AND TOWN CONTACT NUMBER

30.WHEN DEEMED NECESSARY, A 6-FOOT HIGH CHAIN LINK FENCE MUST BE INSTALLED AROUND THE CONSTRUCTION AREA TO PREVENT ANY POTENTIAL SAFETY HAZARD FOR THE PUBLIC. THE FENCE SHALL BE SETBACK AT LEAST 10 FEET FROM ALL RIGHTS-OF-WAY AND HAVE A 50-FOOT STREET CORNER SITE TRIANGLE

WHERE APPLICABLE. 31.CLEAR ACCESS FOR NEIGHBORING PROPERTIES AND EMERGENCY VEHICLES MUST BE MAINTAINED AT ALL TIMES. CONSTRUCTION RELATED VEHICLES MUST BE LEGALLY PARKED ONLY ON ONE SIDE OF THE STREET OR

32.ALL CONSTRUCTION DEBRIS AND EQUIPMENT MUST BE CONTAINED ON SITE AT ALL TIMES. CONTRACTOR AND PROPERTY OWNER MUST MAINTAIN THE JOB SITE FREE OF LITTER AND UNSIGHTLY MATERIALS AT ALL TIMES.

CONSTRUCTION MATERIALS ARE PROHIBITED IN THE TOWN'S RIGHT-OF-WAY. 33.CONSTRUCTION ACTIVITIES ARE PERMITTED BETWEEN THE HOURS OF 7 AM AND 5 PM MONDAY THROUGH CONSTRUCTION ACTIVITIES MAY START ONE (1) HOUR EARLIER DURING THE SUMMER (MAY 1ST THROUGH

34.THE USE AND OPERATION OF FUEL-FIRED GENERATORS IS PROHIBITED UNLESS DUE TO A HARDSHIP. TOWN APPROVAL SHALL BE REQUIRED.

35.THE CONTRACTOR AND PROPERTY OWNER SHALL BE LIABLE FOR ANY DAMAGE DONE TO ANY PUBLIC PROPERTY AS A RESULT OF ANY CONSTRUCTION OR CONSTRUCTION RELATED ACTIVITIES. NO CERTIFICATE OF OCCUPANCY WILL BE ISSUED UNTIL ALL AFFECTED RIGHTS-OF-WAY ARE CLEANED AND/OR REPAIRED TO THEIR

CONDITION AND UNTIL ANY AND ALL DAMAGES TO AFFECTED PROPERTIES ARE RESTORED TO ORIGINAL

36.A KEYED SWITCH SHALL BE REQUIRED ON ALL NEW AND EXISTING ELECTRIC ENTRY GATES. THE KEYED SWITCH SHALL BE INSTALLED IN A LOCATION THAT IS READILY VISIBLE AND ACCESSIBLE. KNOX BOX ORDER FORMS ARE AVAILABLE AT THE TOWN'S BUILDING SAFETY DEPARTMENT

37.PROPERTY OWNER, BUILDER, OR GENERAL CONTRACTOR WILL BE RESPONSIBLE FOR CONTROLLING DUST FROM THE SITE AT ALL TIMES. ALL MEANS NECESSARY SHALL BE USED BY THE BUILDER OR GENERAL CONTRACTOR TO CONTROL THE EXISTENCE OF DUST CAUSED BY ANY EARTHWORK, SPRAY APPLICATION OF MATERIALS, OR OTHER

DUST-CAUSING PRACTICES REQUIRED BY THE CONSTRUCTION PROCESS

38.APPROVAL OF THESE PLANS ARE FOR PERMIT PURPOSES ONLY AND SHALL NOT PREVENT THE TOWN FROM REQUIRING CORRECTION OF ERRORS IN THE PLANS WHERE SUCH ERRORS ARE SUBSEQUENTLY FOUND TO BE IN VIOLATION OF ANY LAW, ORDINANCE, HEALTH, SAFETY, OR OTHER DESIGN ISSUES.

39.ALL DRAINAGE PROTECTIVE DEVICES SUCH AS SWALES, INTERCEPTION DITCHES, PIPES PROTECTIVE BERMS CONCRETE CHANNELS OR OTHER MEASURES DESIGNED TO PROTECT PROPOSED AND EXISTING IMPROVEMENTS FROM RUNOFF OR DAMAGE FROM STORM WATER, MUST BE CONSTRUCTED PRIOR TO THE CONSTRUCTION OF ANY

SITE PLAN INFORMATION - PROPOSED BUILDING:

NET AREA OF LOT: 43,573 SQ. FT. 1.01 AC TOTAL UNDER ROOF 8,488 SF FLOOR AREA RATIO 19.4% (TOTAL FLOOR AREA/NET AREA OF LOT) BUILDING SITE SLOPE: 13.74%

B. HORIZONTAL 291 FT ALLOWABLE DISTURBED PERCENTAGE: 38.21% ALLOWABLE DISTURBED AREA: 16,649 SF

A. VERTICAL 40 FT

GROSS DISTURBED AREA: 37,596 SF TOTAL LIVABLE FOOTPRINT MAIN HOUSE: 5,485 SF - CREDIT AREA: 3,669 SF

TOTAL LIVABLE FOOTPRINT GUEST HOUSE: 1,015 SF ATTACHED GARAGE FOOTPRINT: 1,062 SF - CREDIT AREA: 1,062 SF


RETENTION BASIN CREDIT @ 50%: 1,336 SF - CREDIT AREA: 668 SF RESTORED AREAS: 8,756 SF - CREDIT AREA: 8,756 SF NET PROPOSED DISTURBED AREA: 23,441 SF (53.8%)

PERCENT OF LOT STEEPER THAN NATURAL GRADE (5% MAX) 3% VOLUME OF CUT 863 C.Y. VOLUME OF FILL 863 C.Y. HILLSIDE ASSURANCE @ \$35/CUBIC YARD OF CUT + FILL \$60,410

DRIVEWAY: AREA: 4,258 SF MATERIAL: PAVERS

HILLSIDE GRADING AND DRAINAGE PLAN

5001 E MCDONALD DRIVE PARADISE VALLEY, ARIZONA, 85253

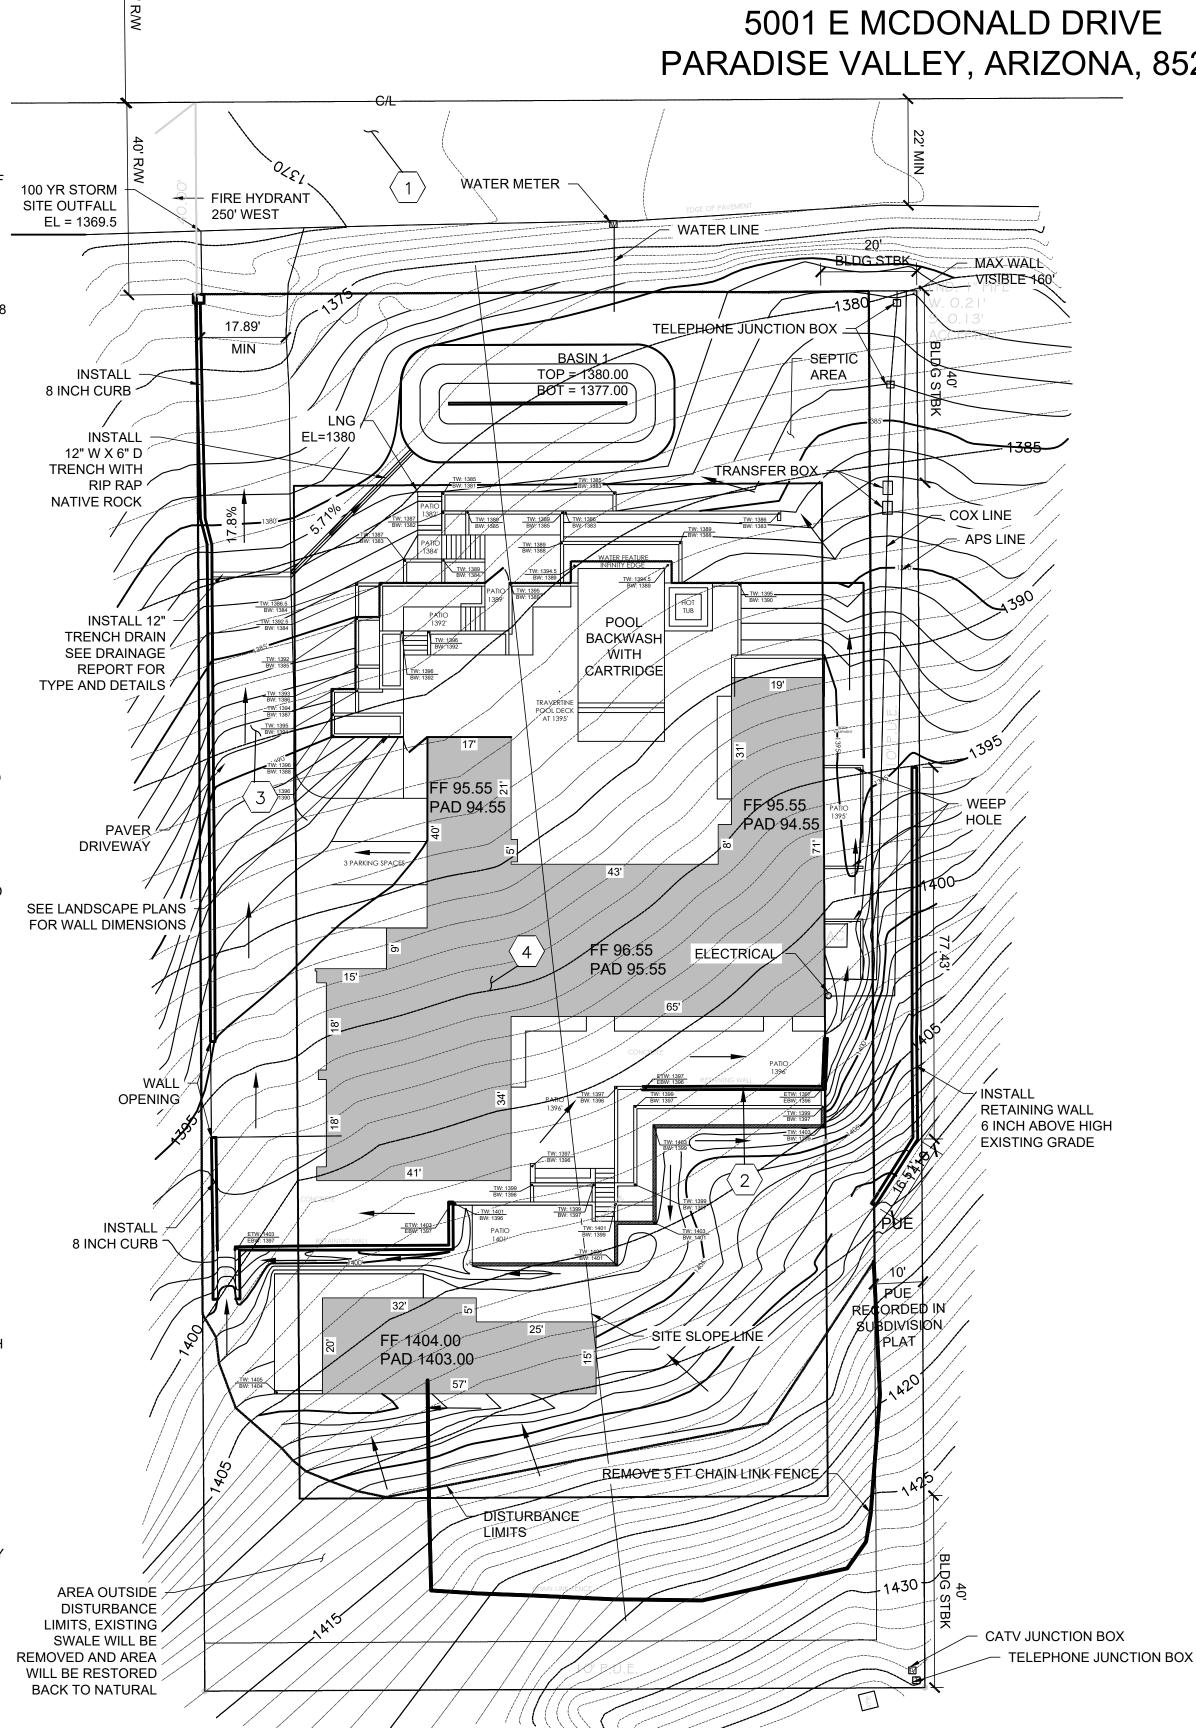



AS BUILT CERTIFICATION

REVISED: REVISED:

BY MY DATED SIGNATURE BELOW, I REAFFIRM MY DECLARATION ON THE FIRST SHEET (COVER SHEET) OF THESE AS BUILT DRAWINGS, AS RELATES SPECIFICALLY TO THE CONTENTS OF THIS SHEET. MY RESPONSIBILIT FOR THE ACCURACY OF THE INFORMATION HEREON IS LIMITED AS SET FORTH IN THOSE DECLARATIONS.

SIGNATURE AND DATE:

OWNER

JOHN MITCHELL 5001 E MCDONALD DRIVE PARADISE VALLEY, AZ 85253 480.760.5727 IUMITCHELL02@YAHOO.COM CONTACT: JOHN MITCHELL

CIVIL ENGINEER:

WERK URBAN DESIGN 51 W 3RD ST, SUITE 450 TEMPE, AZ 85281 480.200.7187 NEIL@WERKURBANDESIGN.COM CONTACT: NEIL HUCKLA

PARCEL DATA: ADDRESS: 5001 E MCDONALD DR

APN 172-04-009 ZONING R-43 AREA 43,573 SF (1.00 ACRES) CONSTRUCTION YEAR: 1963

CUT/FILL QUANTITIES:

NOTE: FOR ESTIMATING PURPOSES ONLY; ENGINEER MAKES NO WARRANTY OF ACCURACY. IT IS THE CONTRACTOR'S RESPONSIBILITY TO DETERMINE **EXACT QUANTITIES BASED ON THE PLANS.** QUANTITIES DO NOT INCLUDE ANY TOPSOIL REMOVAL ANY SHRINKAGE OR EXPANSION/SWELLING OF THE SOIL; OR WETHER SOIL CAN BE REUSED ON-SITE. ASSUMED 4" CONCRETE SLAB AND 4" ABC ARE NOT INCLUDED IN VOLUME QUANTITIES.

713 CY 0 CY FILL

LEGAL DESCRIPTION:

LOT 6, OF MIRADOR, ACCORDING TO THE PLAT RECORD IN THE OFFICE OF THE COUNTY RECORDER OF MARICOPA COUNTY, ARIZONA, RECORDED IN BOOK 67 OF MAPS, PAGE 15.

BUILDING SETBACKS:

40 FT

BASIS OF BEARING:

THE MONUMENT LINE OF MCDONALD DRIVE, USING A BEARING OF SOUTH 89 DEGREES 43 MINUTES 30 SECONDS WEST, PER THE PLAT OF MIRADOR, RECORDED IN BOOK 67, PAGE 15, M.C.R.

BENCHMARK:

BRASS CAP IN HANDHOLE FOUND AT THE NORTHWEST CORNER OF SECTION 17, TOWNSHIP 2N, RANGE 4E. ELEVATION = 1337.90 (NAV 88 DATUM)

SURVEY:

FIELD SURVEY CONDUCTED BY KDM SURVEYING, LLC ON 07-18-19

DRAINAGE CALCULATIONS:

PRE V POST V=C*(P/12)*A

Vpre = 0.85*(2.21/12)*43,573 = 6,821 CUBIC FT Vpost = 0.95*(2.21/12)*17,435+0.85*(2.21/12)*26,138 = 7,142 CUBIC FT

FIRST FLUSH Vff = (P/12)*A

RETENTION PROVIDED:

Vff = (0.5/12)*43,573 = 1,816 CUBIC FT

Vp = (1,336+15)/2*3 = 2,026 CUBIC FT

ENGINEER'S CERTIFICATION:

THE FINISHED FLOOR ELEVATIONS OF 1395.55 and 1396.55 ON THIS PLAN ARE CERTIFIED TO BE 12" ABOVE THE 100-YEAR STORM OUTFALL ELEVATION OF 1369.50, ACCORDING TO SECTION 1024, PARAGRAPH V OF THE TOWN OF PARADISE VALLEY ZONING ORDINANCE.




NUMBER

DATE 57431

REGISTRATION NUMBER FLOOD INSURANCE RATE MAP (FIRM) INFORMATION COMMUNITY PANEL DATED ZONE NUMBER 1765L 10-16-13 X

REQUIREMENTS PRIOR TO ISSUANCE OF PERMIT. THE TOWN NEITHER ACCEPTS NOR ASSUMES ANY LIABILITY FOR ERRORS OR OMISSIONS. THIS COMPLIANCE APPROVAL SHALL NOT PREVENT THE TOWN ENGINEER FROM REQUIRING CORRECTIONS OF ERRORS OR OMISSIONS IN THE PLANS TO BE FOUND IN VIOLATION OF LAWS AND ORDINANCES.

1-5-2021

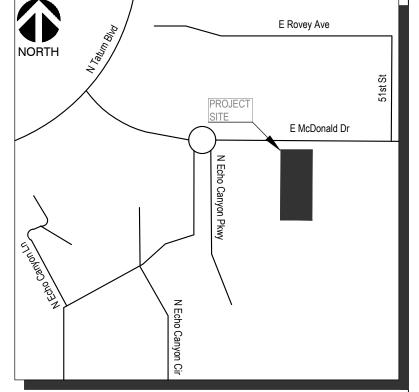

VICINITY MAP CITY OF PARADISE VALLEY

SITE KEY NOTES:

1 EXISTING PAVED ROAD

 $\langle\; 2\;
angle$ EXISTING RETAINING WAL

 $\langle 3 \rangle$ EXISTING ASPHALT PAVEMENT TO BE REMOVED

 \langle 4 \rangle NEW RESIDENCE

LEGEND:

ETW - EXISTING TOP OF WALL EBW - EXISTING BOTTOM OF WALL TW - TOP OF WALL **BW - BOTTOM OF WALL**

UTILITY PROVIDERS: 1.WATER - EPCOR

2.SANITARY SEWER - SEPTIC 3.ELECTRIC - APS 4.TELEPHONE - COX COMMUNICATIONS 5.NATURAL GAS - SOUTHWEST GAS 6.CABLE TV - COX COMMUNICATIONS

DRAINAGE STATEMENT:

1.ULTIMATE STORM WATER OUTFALL LOCATIONS AND **ELEVATIONS SHOWN ON DRAWING** 2.PROPOSED DEVELOPMENT DOES NOT IMPACT DRAINAGE CONDITIONS OF ADJOINING LOTS 3.RETENTION IS PROVIDED FOR THE 100-YEAR, 2-HOUR STORM EVENT PER THE STORM WATER DRAINAGE DESIGN

4.THE LOWEST FINISH FLOOR ELEVATION OF 1395.55 IS SAFE FROM INUNDATION DURING A 100-YEAR PEAK RUN-OFF EVENT IF CONSTRUCTED IN ACCORDANCE WITH THE APPROVED PLANS.

HILLSIDE NOTES:


1. NO CERTIFICATE OF OCCUPANCY SHALL BE ISSUED UNTIL ALL HILLSIDE STIPULATIONS AND ALL TOWN CODE REQUIREMENTS ARE COMPLIED INCLUDING, BUT NOT LIMITED TO LANDSCAPING, GROUND RESTORATION, FIRE FLOW, FIRE SAFETY AND ALL ONSITE AND OFFSITE IMPROVEMENTS.

2. ALL OUTDOOR LIGHTING SHALL BE IN CONFORMANCE WITH ARTICLE XXII OF THE TOWN ZONING ORDINANCE. 3. ALL EXCESS FILL MATERIAL SHALL BE REMOVED FROM THE SITE WITH NO NEW SPILL SLOPES.

4. THE USE OF HYDRAULIC RAM HAMMERS AND HEAVY EQUIPMENT USED TO CUT THROUGH ROCK, INCLUDING MACHINERY WITH AUDIBLE BACK UP WARNING DEVICES SHALL BE LIMITED TO USE BETWEEN THE HOURS OF 7:00 AM OR SUNRISE, WHICHEVER IS LATER, AND 6:00 PM OR SUNSET, WHICHEVER IS EARLIER, MONDAY THROUGH FRIDAY, WITH LIMITED WORK ON SATURDAY AND NO WORK ON SUNDAY OR LEGAL HOLIDAYS. 5. CONSTRUCTIONS STAKING AND/OR FENCING SHALL BE PLACED AROUND THE CONSTRUCTION SITE SO AS TO PROTECT THE UNDISTURBED NATURAL AREAS. 6.REQUIRE LIMITED AND EFFICIENT USE OF EXTERIOR LIGHTING TO MAINTAIN MINIMAL NIGHT-TIME LIGHTING LEVELS AND PRESERVATION OF THE DARK SKY.

NATIVE PLANTS STATEMENT: ALL NATIVE PLANTS IMPACTED BY CONSTRUCTION SHALL BE

RELOCATED ON SITE.

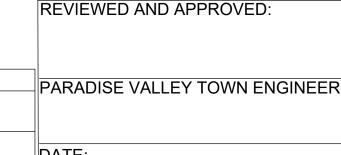



THIS SET OF PLANS HAS BEEN REVIEWED FOR COMPLIANCE WITH TOWN OF PARADISE VALLEY







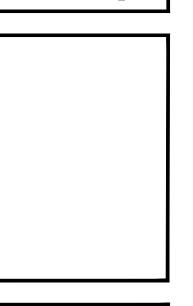

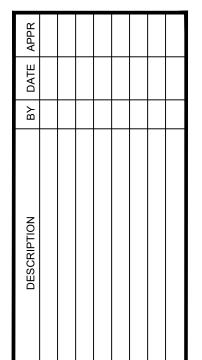

RADING AGE PLAN

H


 \Box ∞ 5001 RADI

CALE (V): DESIGN BY: CHECK BY 10/22/2020 57431 HUCKLA

PROJECT No.

19020

GD100 1 OF 1 SHEETS

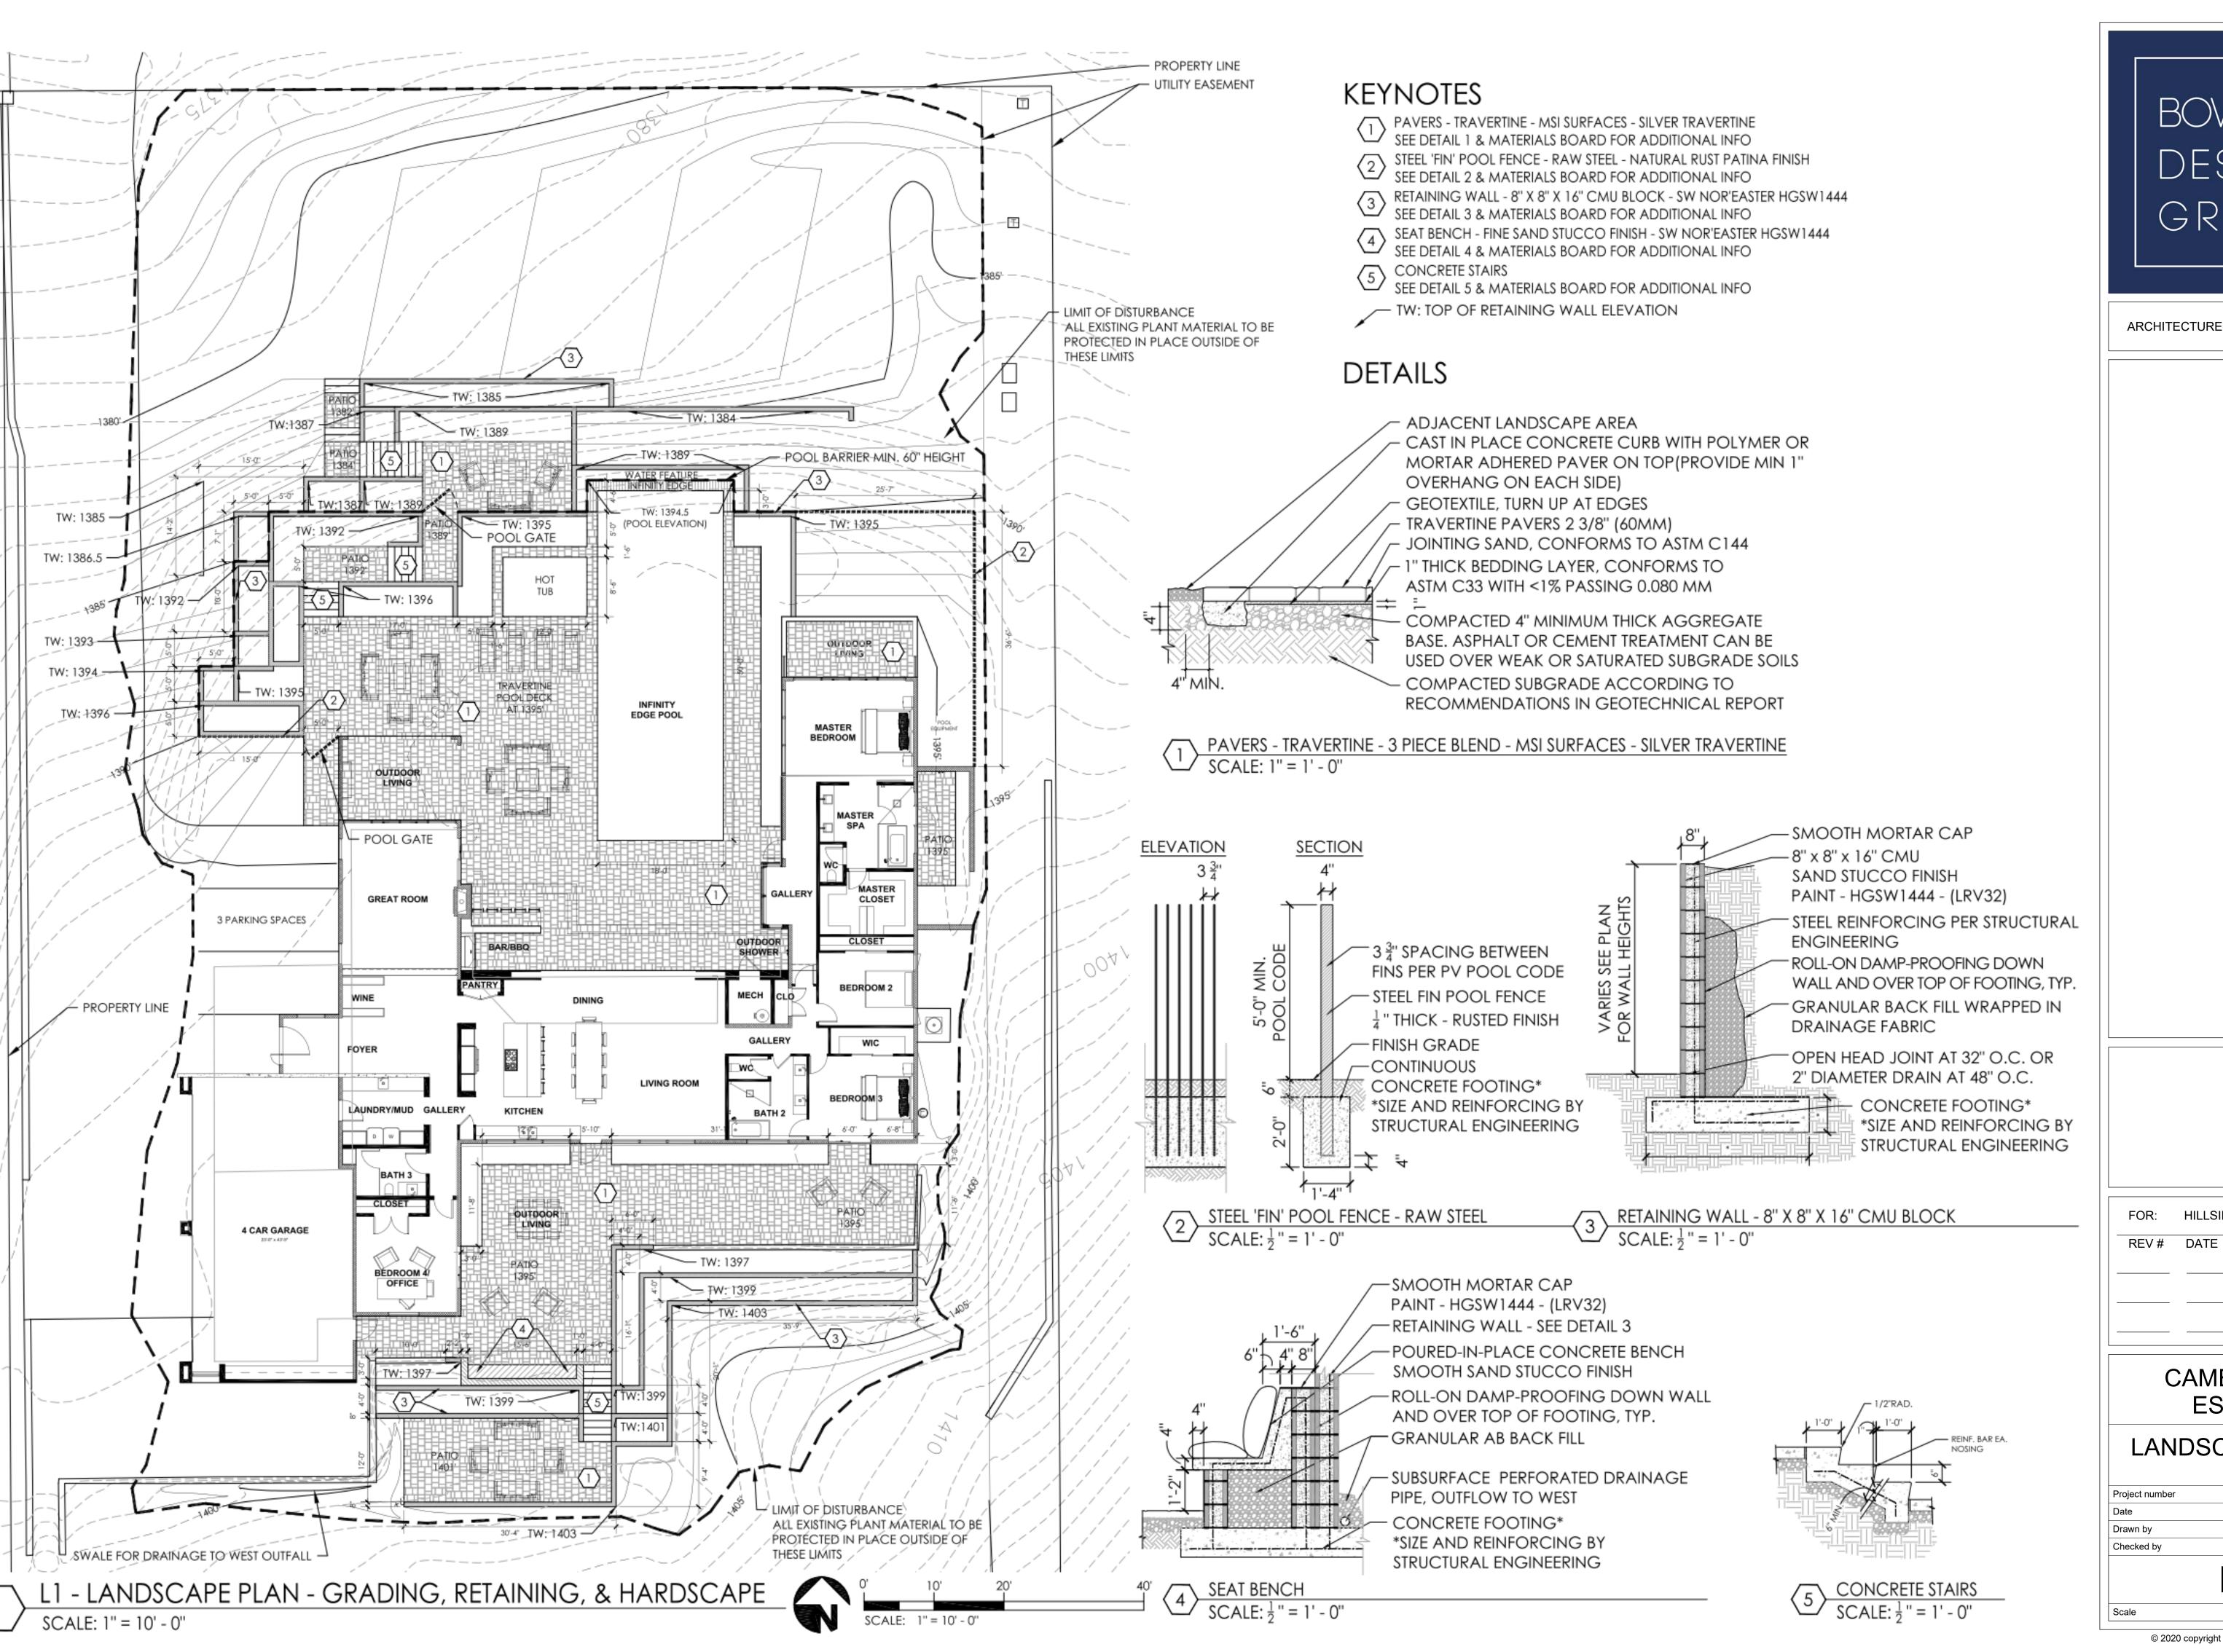

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ARCHITECTURE | PLANNING | DESIGN


FOR: HILLSIDE REVIEW

ESTATE LANDSCAPE PLAN

CAMELBACK

Project number	19-12
Date	11/12/2020
Drawn by	JN
Checked by	JN

1" = 10'-0"

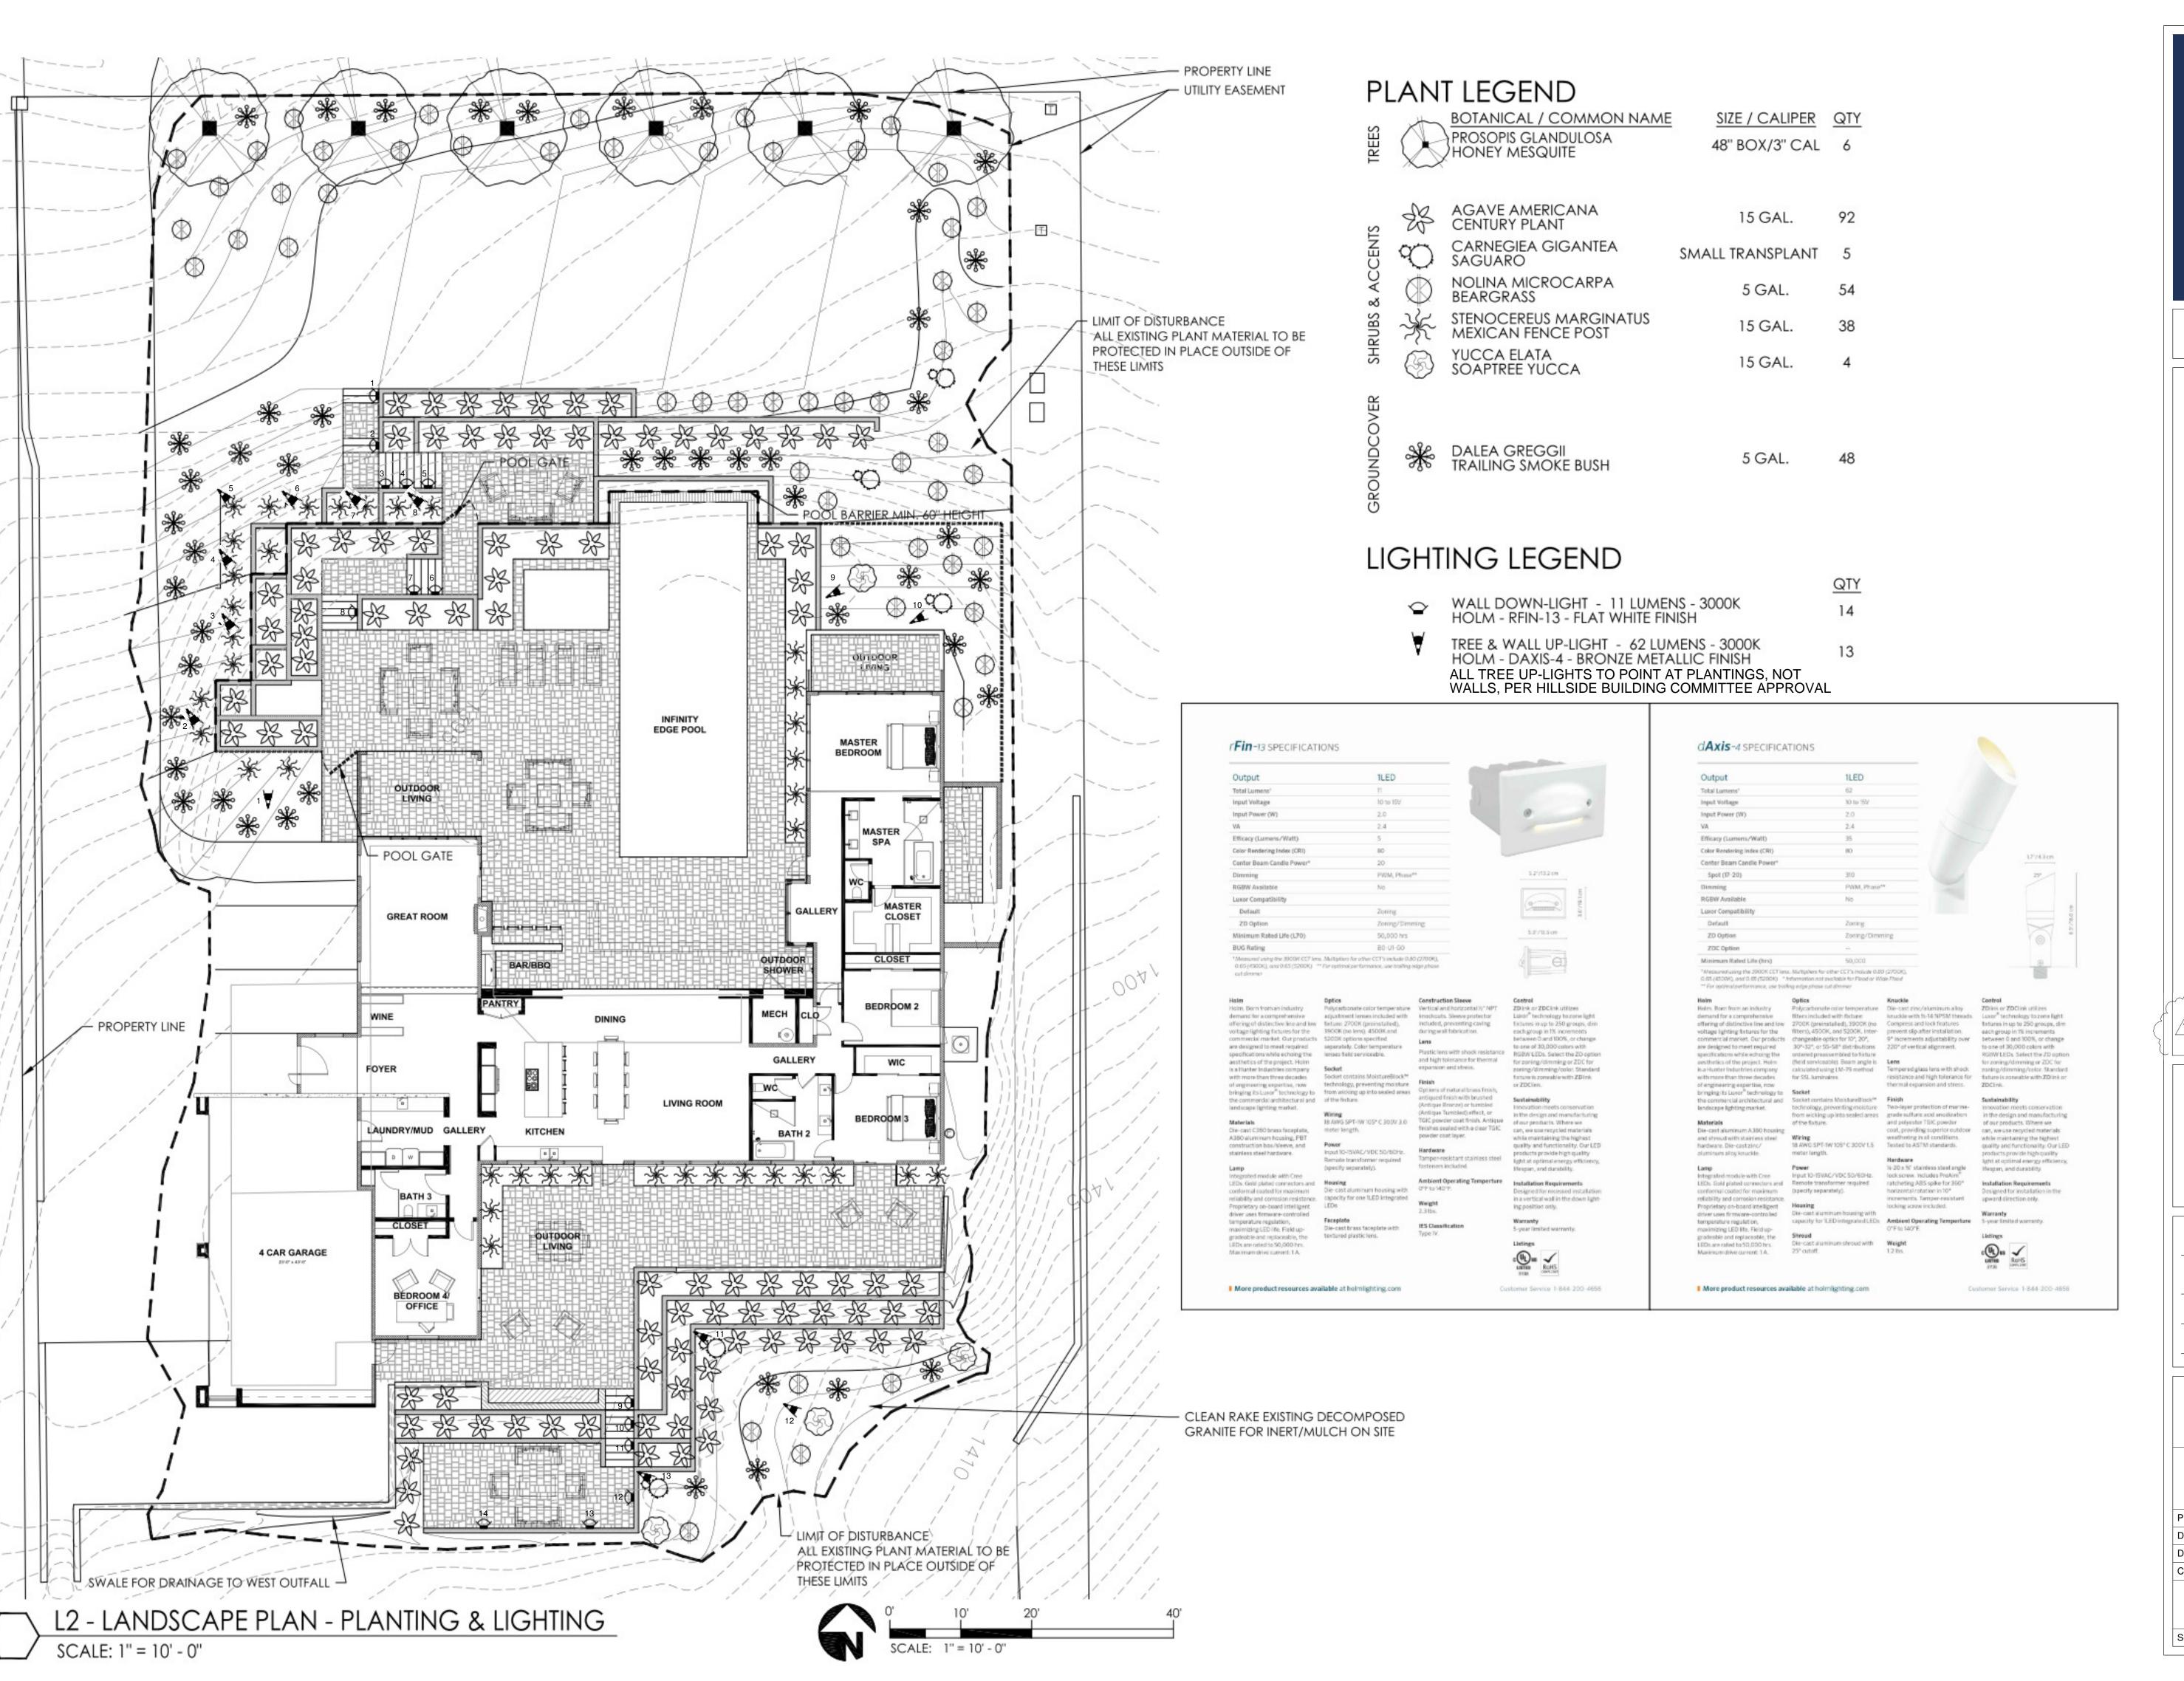



DRAWING APPROVED PER HILLSIDE BUILDING COMMITTEE ON 6/10/2020

FOR: HILLSIDE REVIEW

REV # DATE

CAMELBACK ESTATE

LANDSCAPE PLAN

Project number 19-12

Date 4/08/2020

Drawn by JM


Checked by JM

L2


1" = 10'-0"
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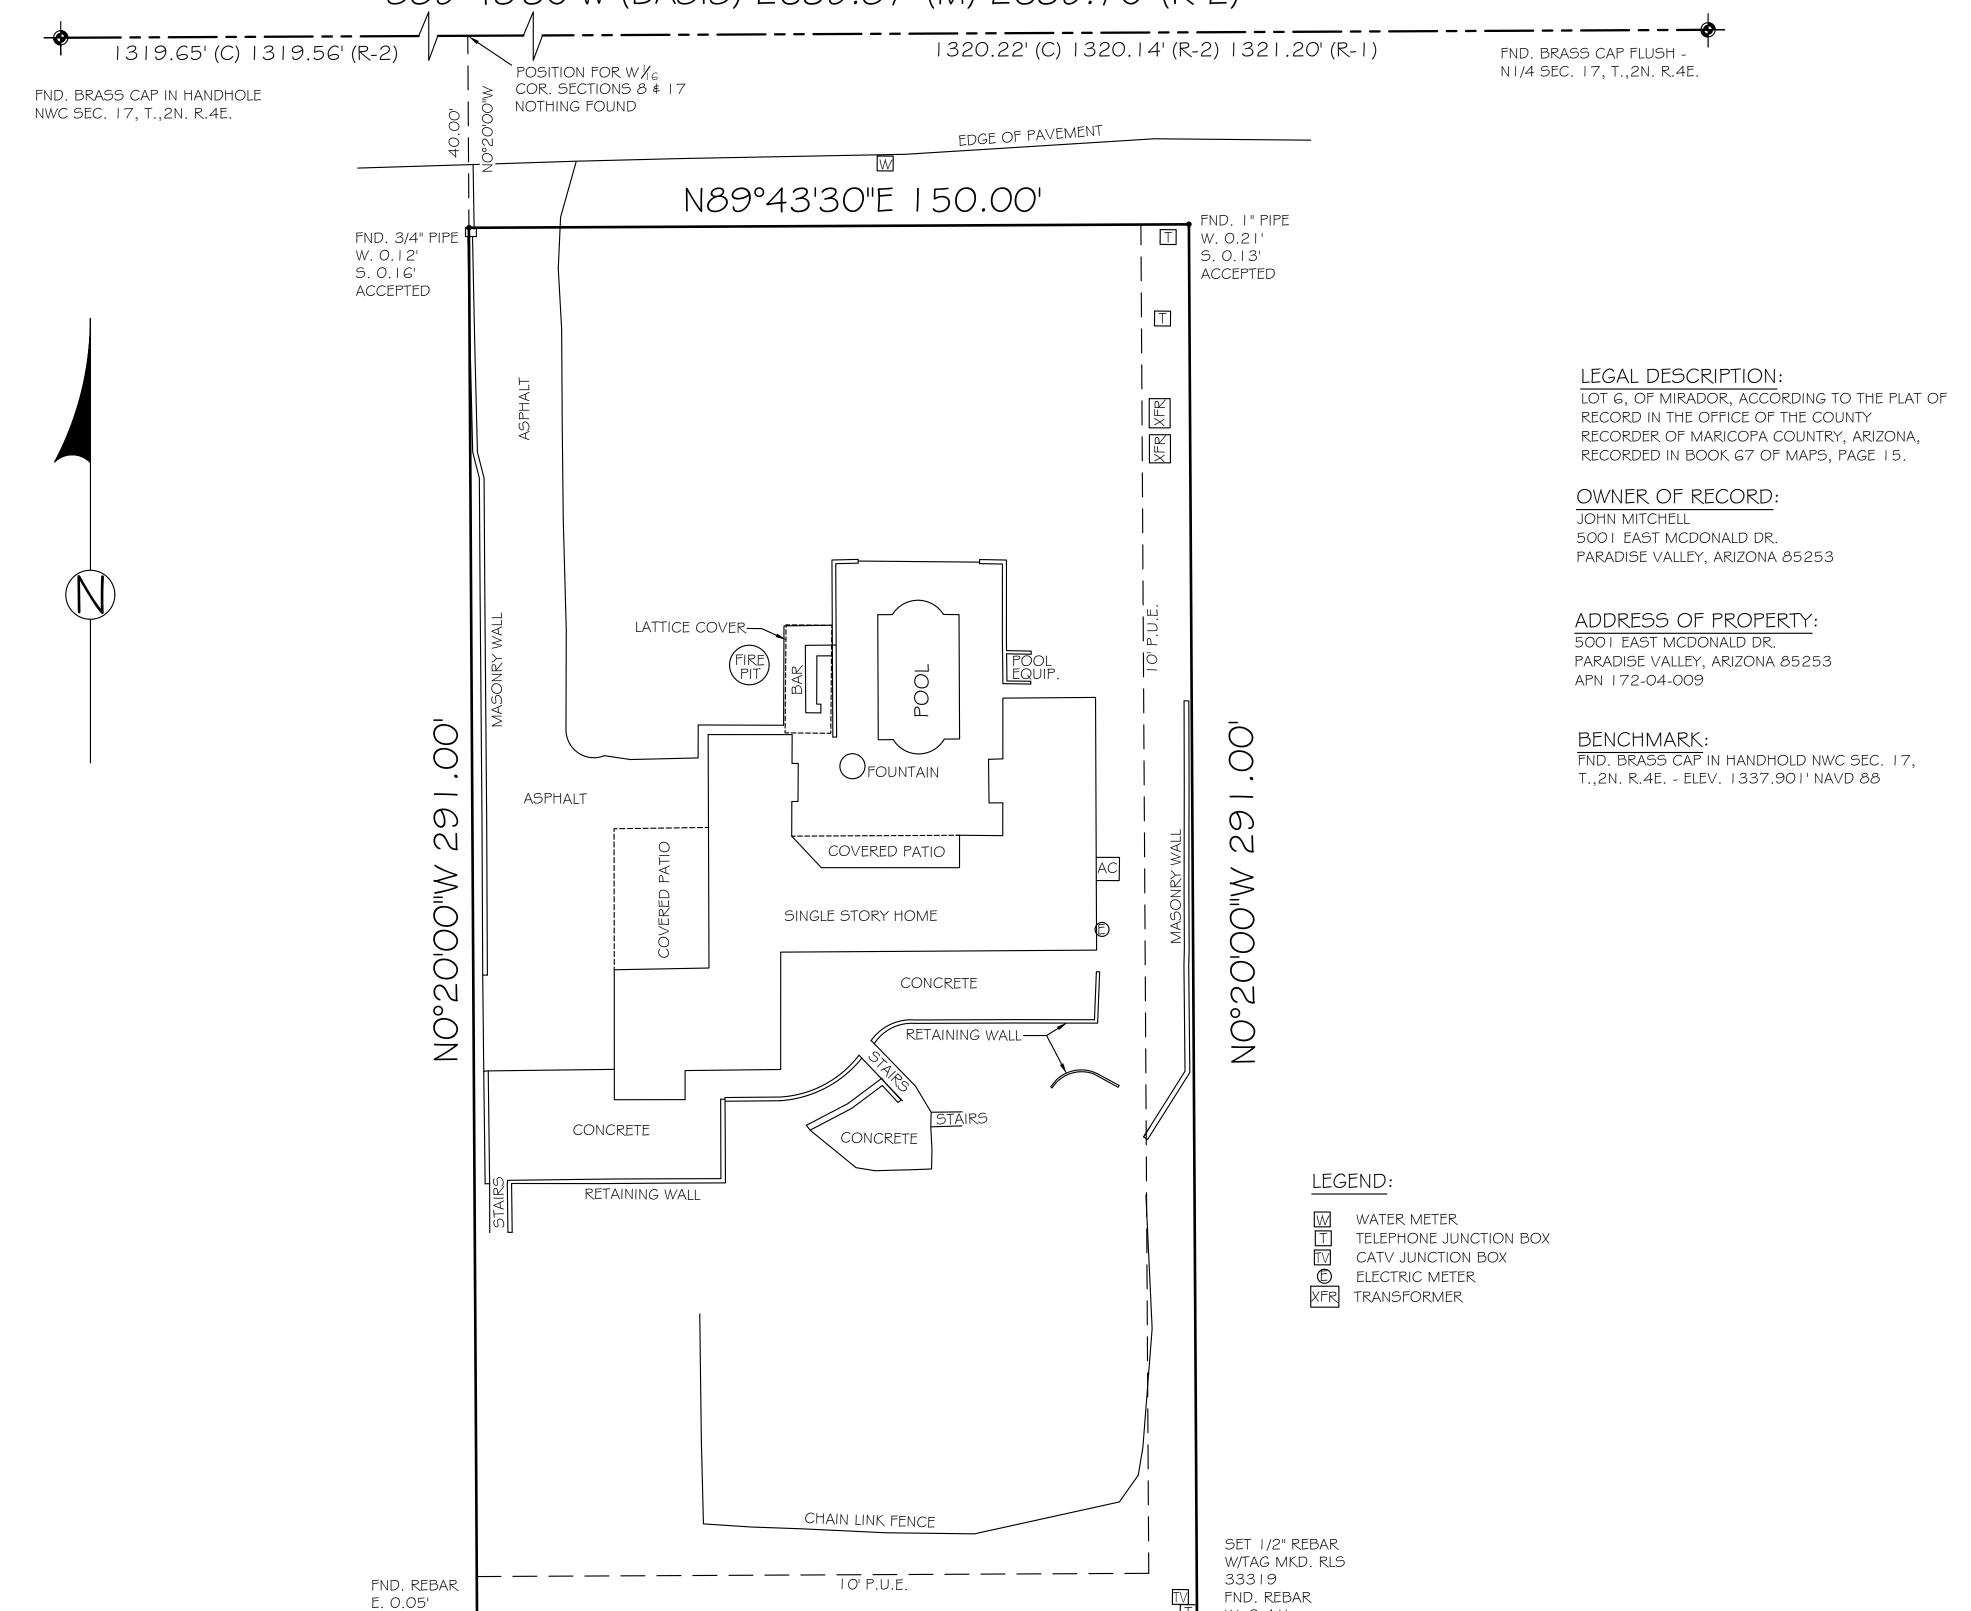
RESULTS OF SURVEY

A PORTION OF THE NW/4 OF SECTION 17, T.2N., R.4E., G. \$ S. R. M., MARICOPA COUNTY, ARIZONA

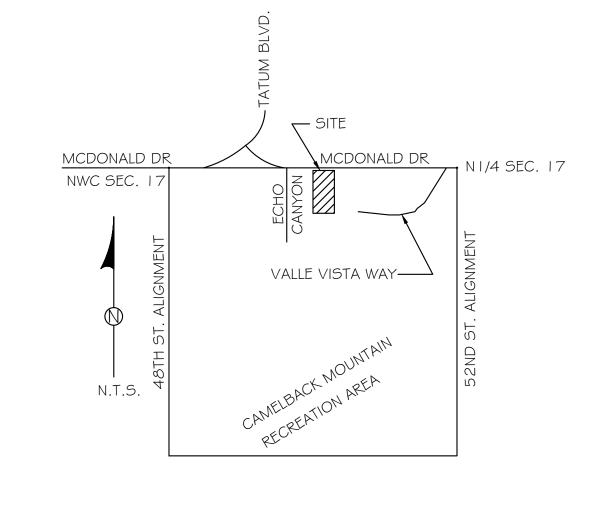

MCDONALD DRIVE



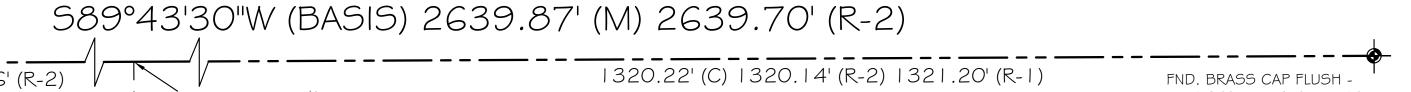

N89°43'30"E 150.00'

S. 0.22[']

ACCEPTED

W. 0.41'

S. 0.69¹


NOT ACCEPTED

NOTES

- I. THIS SURVEY WAS PERFORMED IN THE FIELD DURING THE MONTH OF JULY, 2019.
- 3. ALL VISIBLE SURFACE UTILITIES WERE LOCATED, NO UNDERGROUND UTILITIES ARE SHOWN.
- 4. SURVEY PLATTED HEREON DOES NOT PURPORT TO VERIFY OWNERSHIP.
- 5. EXCEPT AS NOTED, SURVEYOR HAS MADE NO INVESTIGATION OR INDEPENDENT SEARCH FOR EASEMENTS OF RECORD, ENCUMBRANCES, RESTRICTIVE COVENANTS. OWNERSHIP TITLE EVIDENCE, OR ANY OTHER FACTS THAT AN ACCURATE AND CURRENT TITLE REPORT MAY DISCLOSE
- 6. DECLARATION IS MADE TO ORIGINAL PURCHASER ONLY. SURVEY IS NOT TRANSFERABLE TO SUBSEQUENT OWNERS OR ADDITIONAL INSTITUTIONS WITHOUT WRITTEN PERMISSION OF THE SURVEYOR.
- 7. SURVEY IS VALID ONLY IF PRINT BEARS ORIGINAL SEAL AND SIGNATURE OF SURVEYOR.
- 8. CONDITIONS SHOWN ARE THOSE THAT EXISTED AT THE TIME OF SURVEY.
- 9. RECORD BOUNDARY AND EASEMENT INFORMATION TAKEN FROM THE FOLLOWING:
 - R-I "MIRADOR", BOOK 67 OF MAPS, PAGE II.
 - R-2 "FINAL PLAT FOR HF SURPRISE ESTATES", BOOK 1251 OF MAPS, PAGE 48.

SURVEYORS STATEMENT

I, KENT DAVID MILLER, A PROFESSIONAL LAND SURVEYOR, REGISTERED IN THE STATE OF ARIZONA, STATE THAT THIS PLAT AND THE SURVEY UPON WHICH IT IS BASED, WAS COMPLETED UNDER MY DIRECT SUPERVISION DURING THE MONTH OF JULY, 2019, AND THAT ALL MONUMENTS FOUND OR SET ARE CORRECT TO THE BEST OF MY KNOWLEDGE AND ARE SUFFICIENT TO ALLOW THE SURVEY TO BE RETRACED.

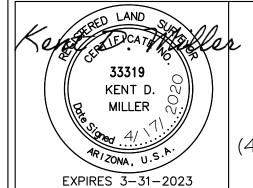


KENT D. MILLER, R.L.S.


1243 | NORTH 65TH STREET SCOTTSDALE, ARIZONA 85254 (480) 231-4492 FAX (480) 998-0138

kdmsurveying@cox.net

echocanyon ros Ol

KDM APRIL 17,2020

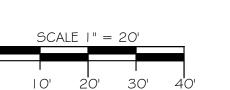


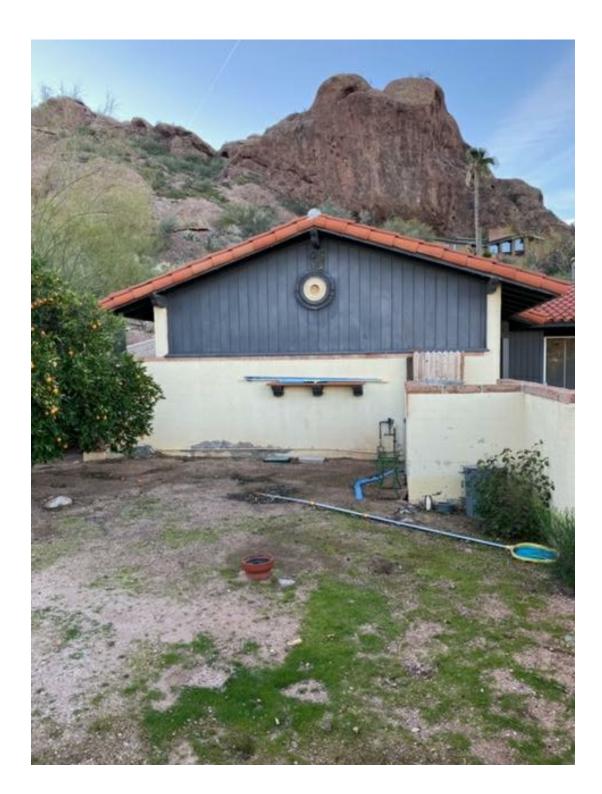

(1) EXISTING NORTHEAST CORNER OF HOUSE




(4) EXISTING WEST SIDE OF THE HOUSE GARAGE AND COVERED ENTRY

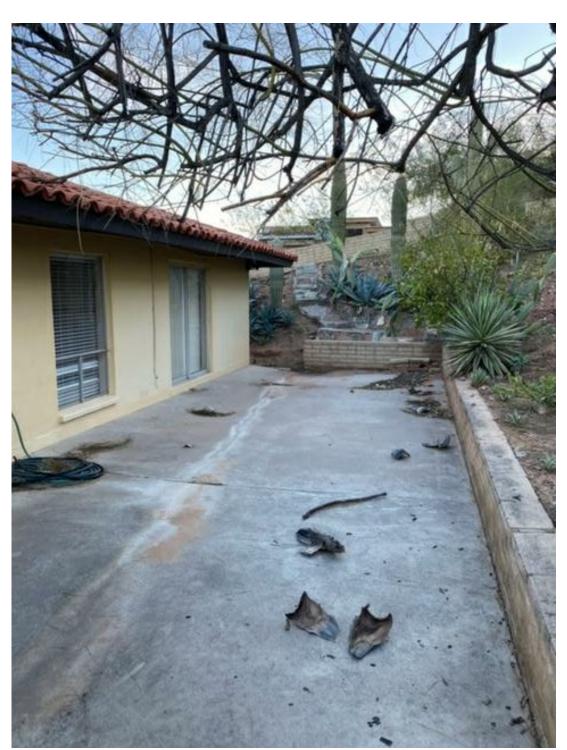


(7) EXISTING BACK SIDE OF THE HOUSE SHOWING 2' RETAINING SITE WALLS



(2) EXISTING NORTH SIDE OF HOUSE WITH POOL

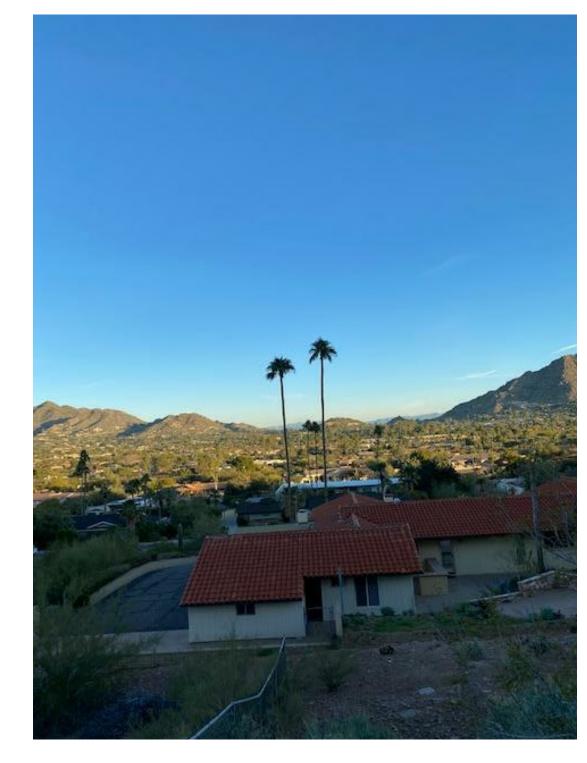

(5) EXISTING SOUTH SIDE OF THE HOUSE GARAGE AND OFFICE

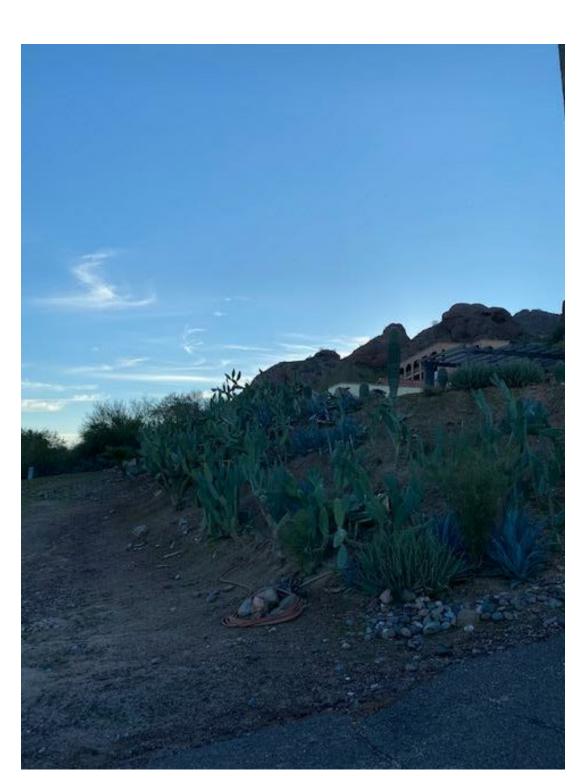

(8) EXISTING NORTHWEST CORNER OF THE LOT SHOWING LANDSCAPE



(3) EXISTING NORTHWEST CORNER OF HOUSE




(6) EXISTING SOUTHEAST CORNER THE HOUSE UP THE HILL ON CORNER LOT



(9) EXISTING NORTHEAST CORNER OF THE LOT SHOWING LANDSCAPE



MCDONALD DRIVE

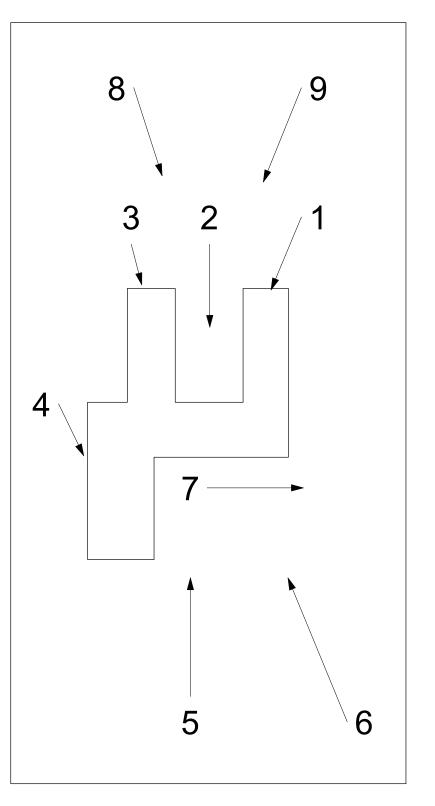

KEY PLAN

- 1		
	FOR:	HILLSIDE REVIEW
	REV#	DATE

CAMELBACK ESTATE

PROPERTY PHOTOS

Project number 19-12

Date 11/12/2020

Drawn by Author

Checked by Checker

A0.3


Scale 1" = 1'-0"

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/13/2020 3:14:2



NORTHWEST CORNER OF HOUSE



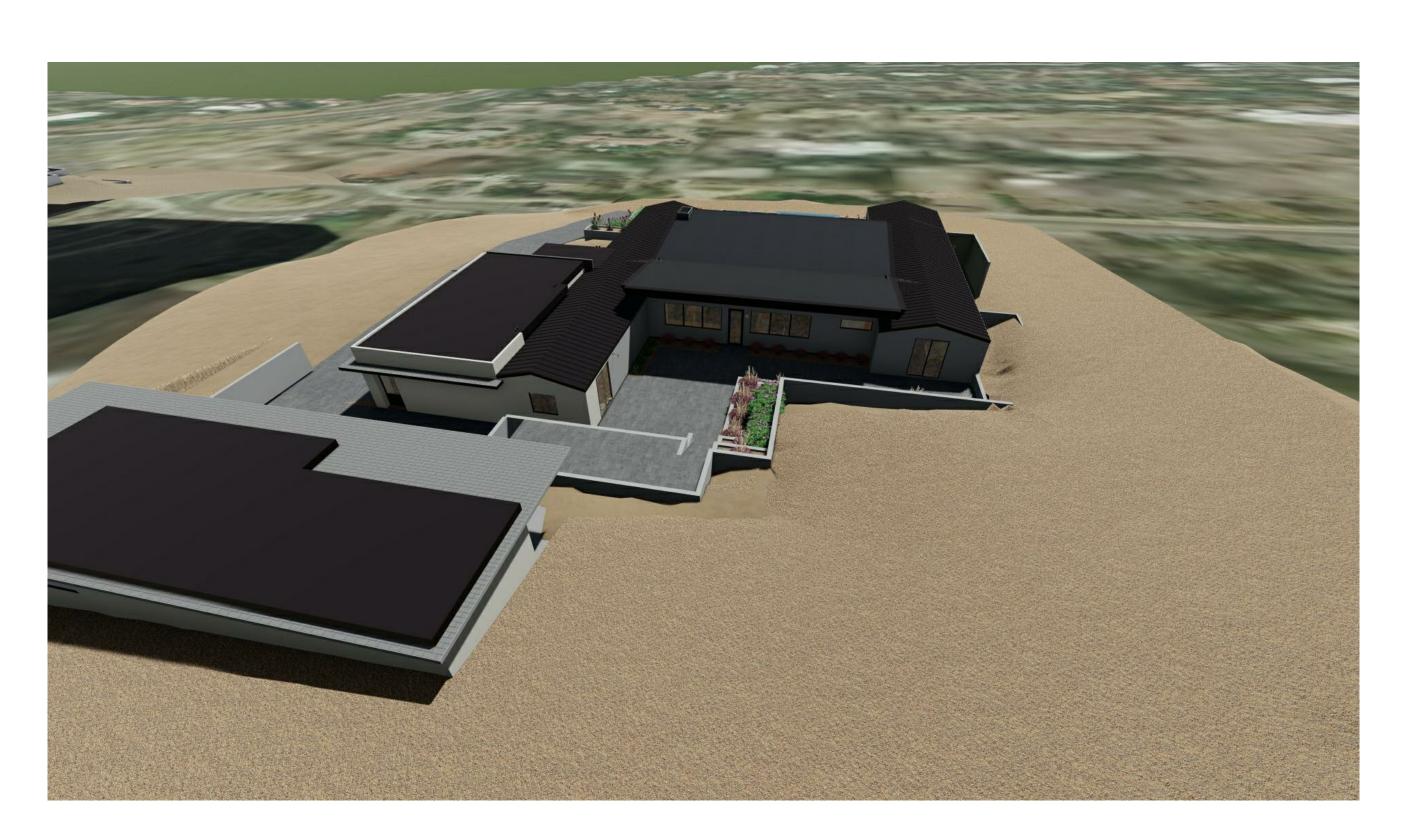



BOWMAN DESIGN GROUP

FOR: HILLSIDE REVIEW

REV# DATE

CAMELBACK ESTATE

PROPERTY RENDERINGS

 Project number
 19-12

 Date
 11/12/2020


 Drawn by
 DJB

 Checked by
 DJB

A0.4


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11/13/2020 3:14:2



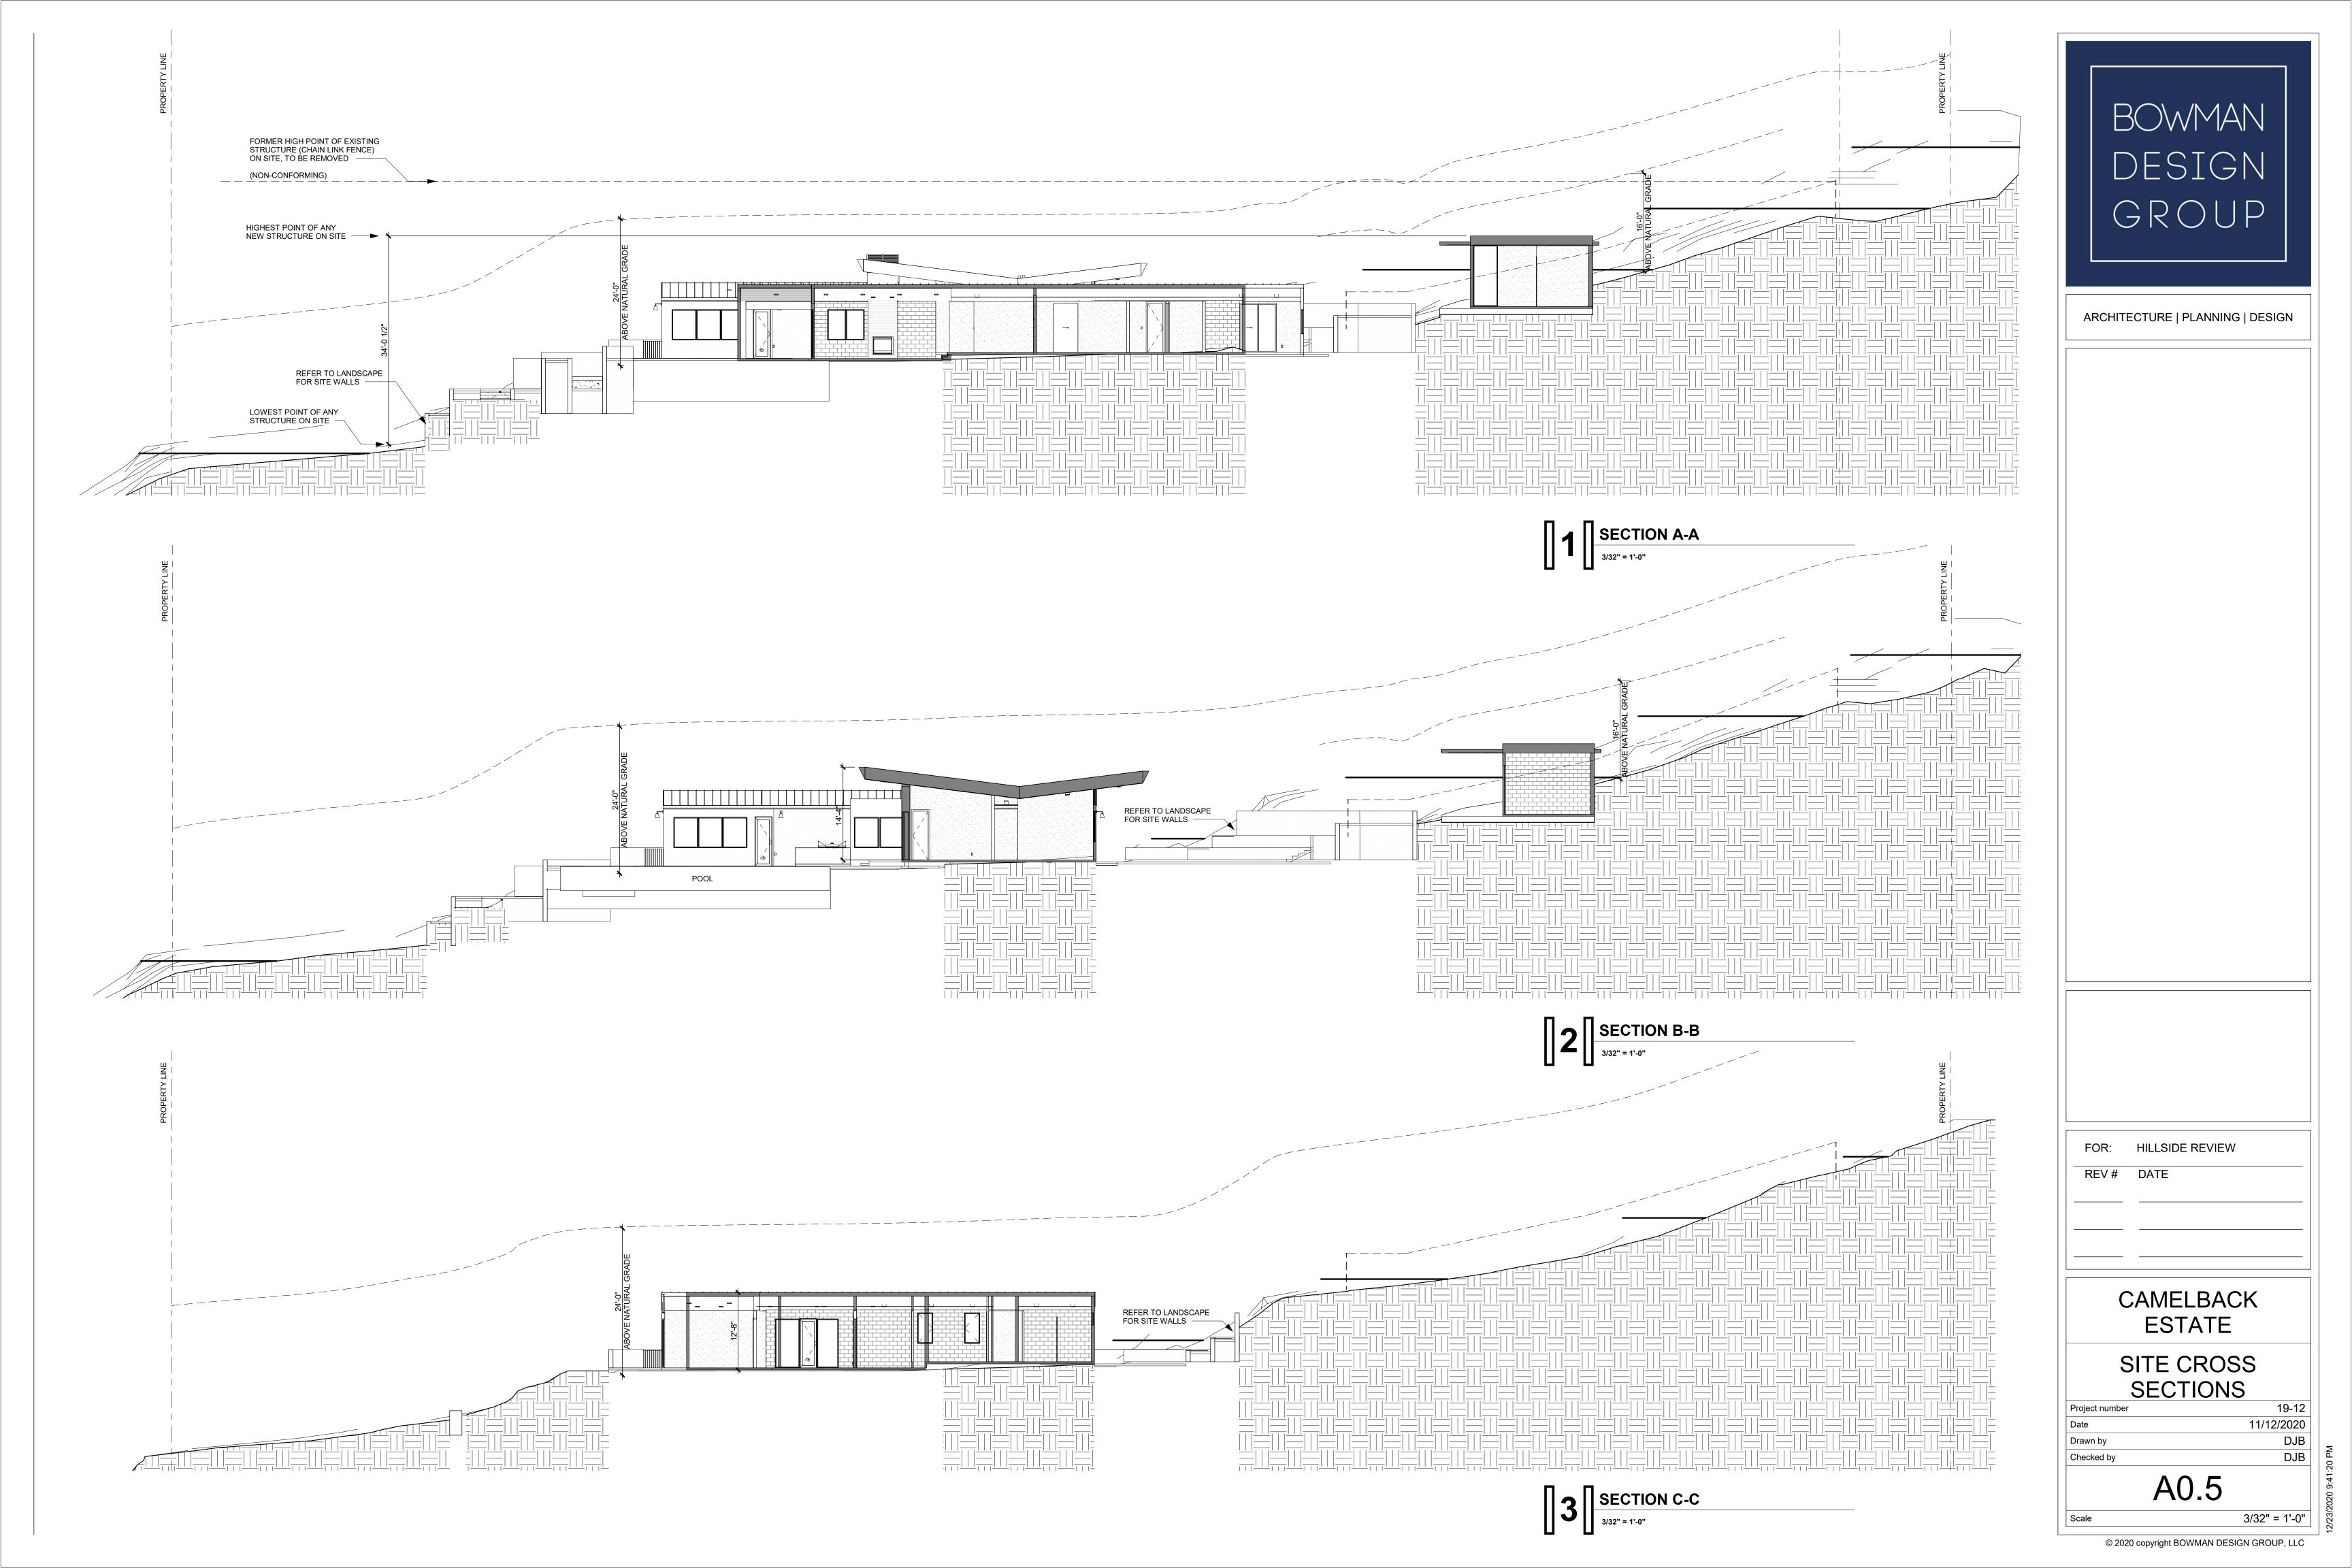

STACK BOND CMU WALL - GUEST HOUSE EXTERIOR WALLS
-STANDARD EXPOSED GRAY BLOCK - LRV = 25
(OR EQUIVALENT)

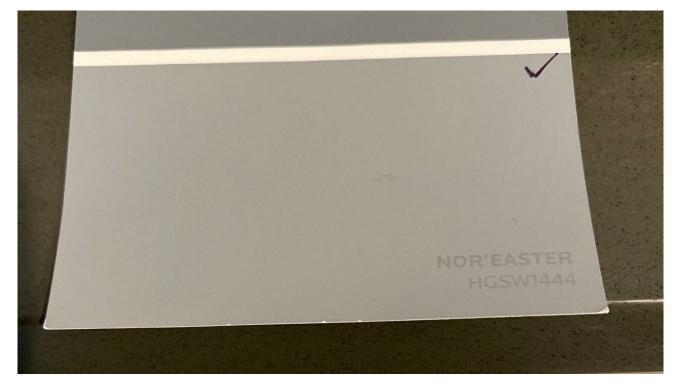

STUCCO PAINT, STUCCO SOFFITS, GYP BOARD SOFFITS, AND TRIM
-SHERWIN WILLIAMS
-NOR'EASTER - HGSW1444 - LRV = 32
(OR EQUIVALENT)



POOL DECK PAVERS
MSI SURFACES
-SILVER TRAVERTINE
APPROX. LRV = 30
(OR EQUIVALENT)



Midnight Blue

POOL FINISH
-PEBBLETEC
MIDNIGHT BLUE - APPROX LRV = 15
(OR EQUIVALENT)





STANDING SEAM METAL ROOF AND METAL FASCIA
-MBCI METAL ROOFING
-MIDNIGHT BRONZE - LRV = 7
(OR EQUIVALENT)

SITE VIEW FENCE

-RUSTED METAL REBAR OR FLAT BAR APPROX. LRV = 12 (OR EQUIVALENT)

EXTERIOR TONGUE & GROOVE WOOD SOFFIT

-SHERWIN WILLIAMS HAWTHORNE - SW3518 - APPROX LRV = 20

(OR EQUIVALENT)

SW 3518

Hawthorne




BALLASTED ROOFING SYSTEM
-STANDARD GRAY GRAVEL/ROCK - LRV = 25
(OR EQUIVALENT)
*IF REQUIRED BY HILLSIDE COMMITTEE,
CLIENT PREFERS TO PAINT TPO ROOFING



DOOR AND WINDOW FRAMES
-WESTERN WINDOWS
-DARK BRONZE ANODIZED - LRV = 7
(OR EQUIVALENT)



DRIVEWAY/PARKING PAVERS
-BELGARD
-LUEDERS GRAY
APPROX. LRV = 30
(OR EQUIVALENT)

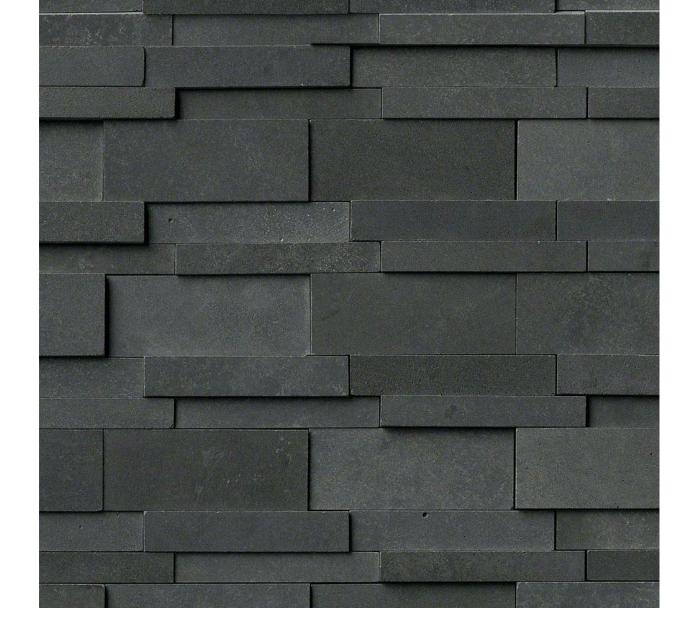

"In minimalist and modern design, we are always trying to get more glazing and less frame. With the newer Western

Window Systems units, we are starting to see even smaller frame profiles and bigger allowed areas of glazing."

- Dan Weber, Principal, ANACAPA Architecture

STONE VENEER
-MS INTERNATIONAL
-NEPTUNE - LRV = 5
(OR EQUIVALENT)



EXTERIOR SOFFIT CAN LIGHT
-PROGRESS LIGHTING
-BLACK FINISH - 3000 KELVIN - 725 LUMENS
LRV = 5 (OR EQUIVALENT)



EXTERIOR WALL SCONCE
-ZUR 24 OUTDOOR WALL " DARK SKY OPTION"
-BLACK FINISH - 3000 KELVIN - 750 LUMENS MAX.
LRV = 5



ARCHITECTURE | PLANNING | DESIGN

GENERAL MATERIAL NOTES

- ALL EXTERIOR MATERIAL PALETTE SHALL BE IN ACCORDANCE WITH SECTION 2207.II.D.
- ALL EXTERIOR LIGHTING SHALL COMPLY WITH SECTION 2208.

FOR: HILLSIDE REVIEW

REV# DATE

CAMELBACK ESTATE

MATERIAL BOARD

Project number 19-12

Date 11/12/2020

Drawn by DJB


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A0.6

3/16" = 1'-0"

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Scale



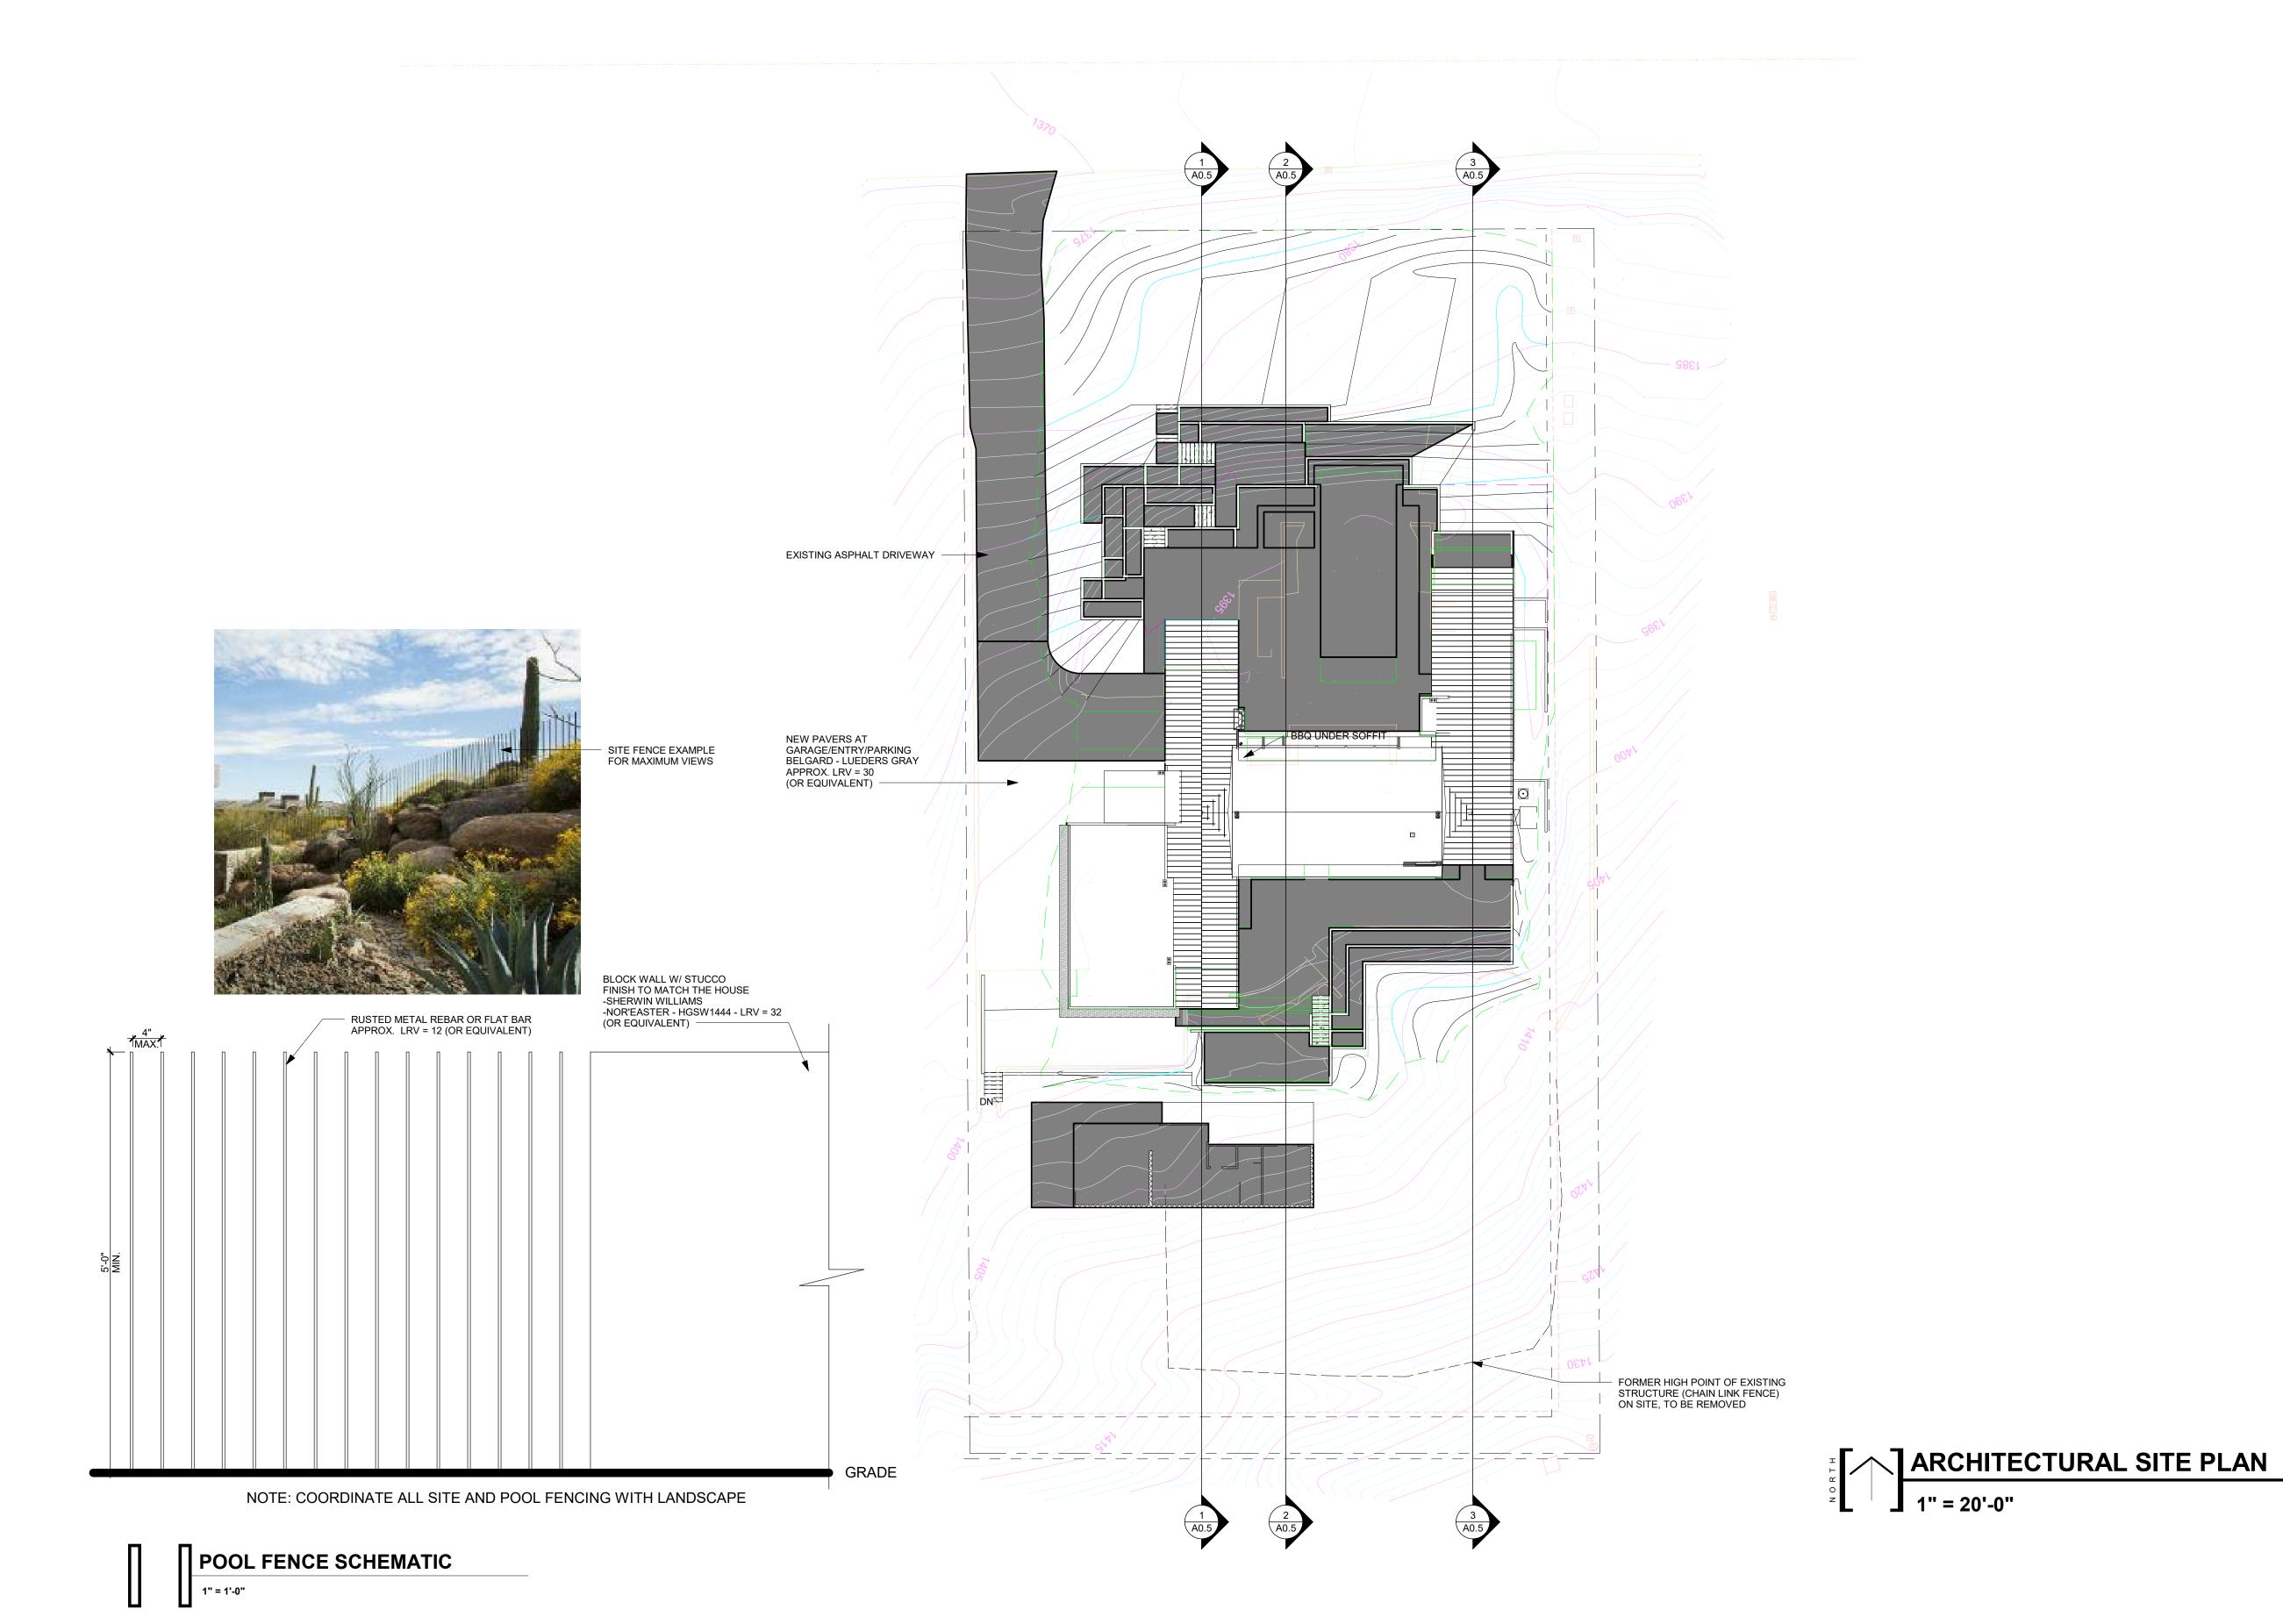

MATERIAL NOTES

NOTE:

SEE MATERIAL BOARD A0.6 FOR EXTERIOR SITE MATERIALS, COLOR, FINISH, AND LIGHT REFLECTIVE VALUE.

FOR: HILLSIDE REVIEW

REV # DATE

Checked by

CAMELBACK ESTATE

ARCH. SITE PLAN


 Project number
 19-12

 Date
 11/12/2020

 Drawn by
 DJB

A1.1

As indicated

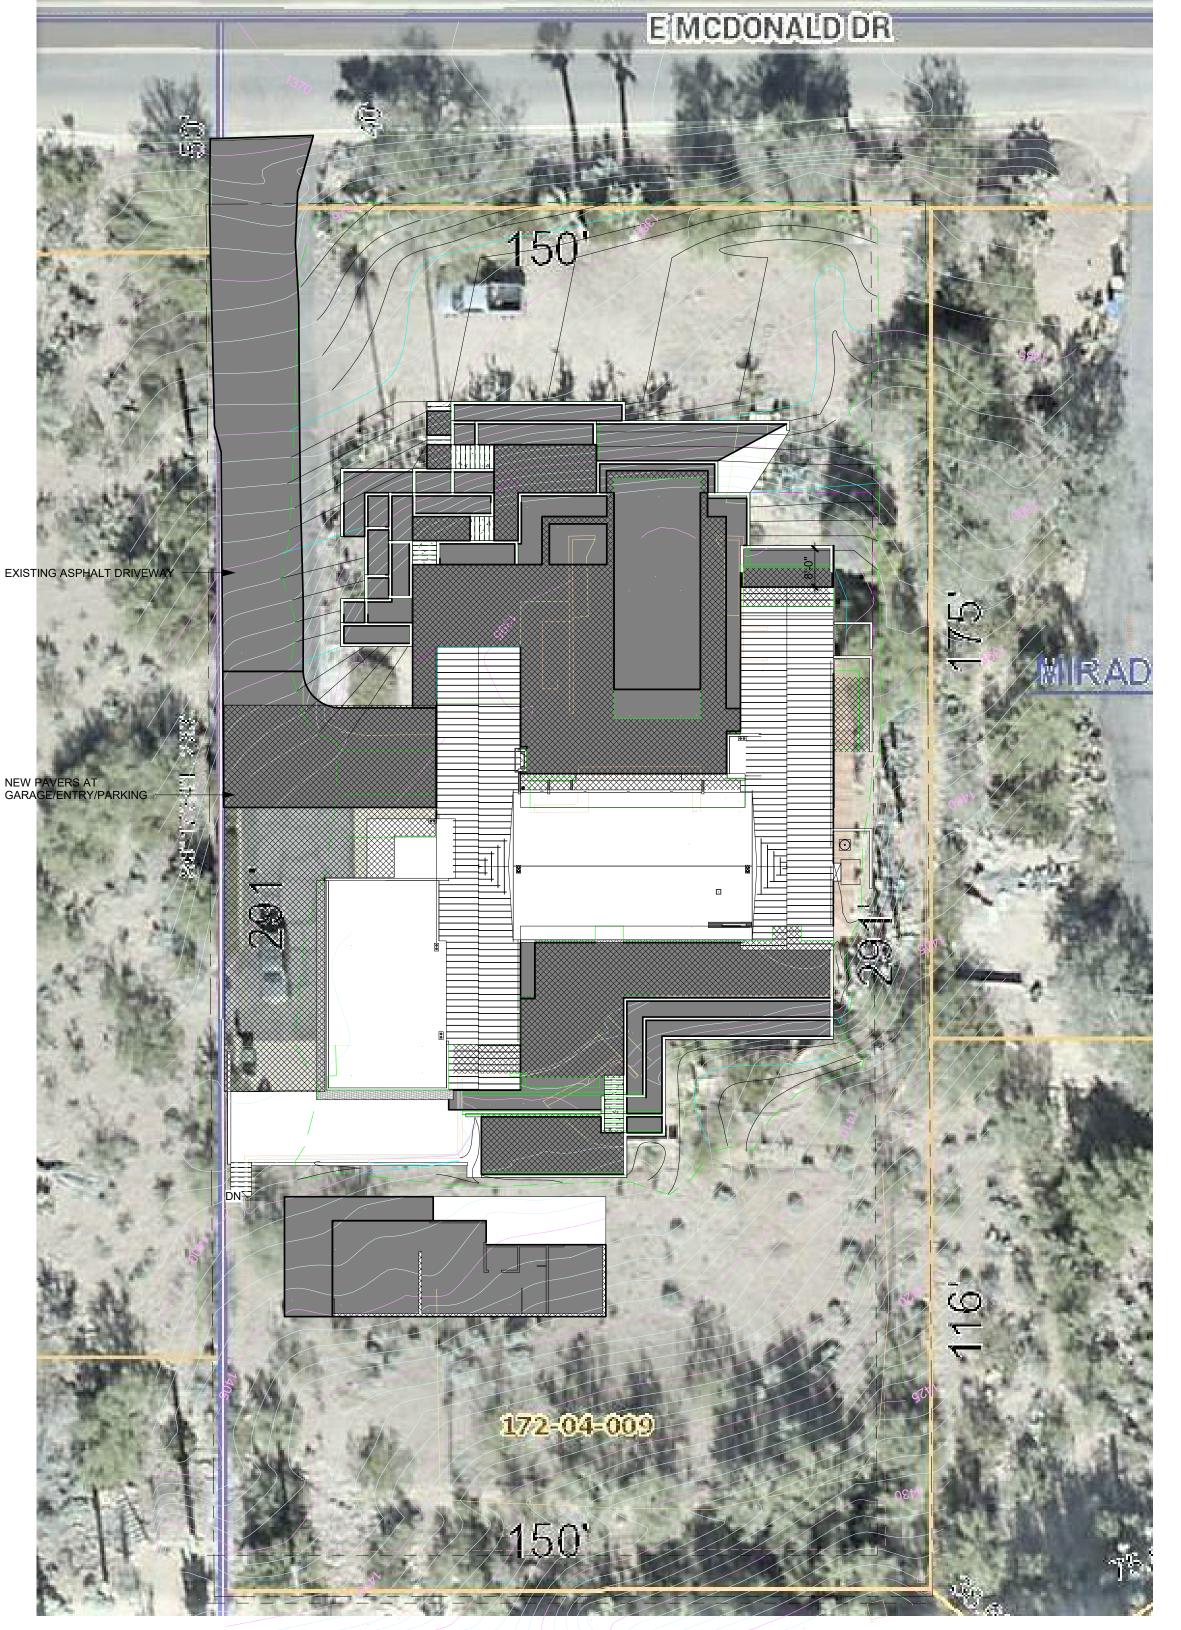



FOR: HILLSIDE REVIEW

REV # DATE


CAMELBACK **ESTATE**

ARCH. SITE PLAN

19-12 Project number 11/12/2020 Drawn by

A1.1a

1" = 20'-0"

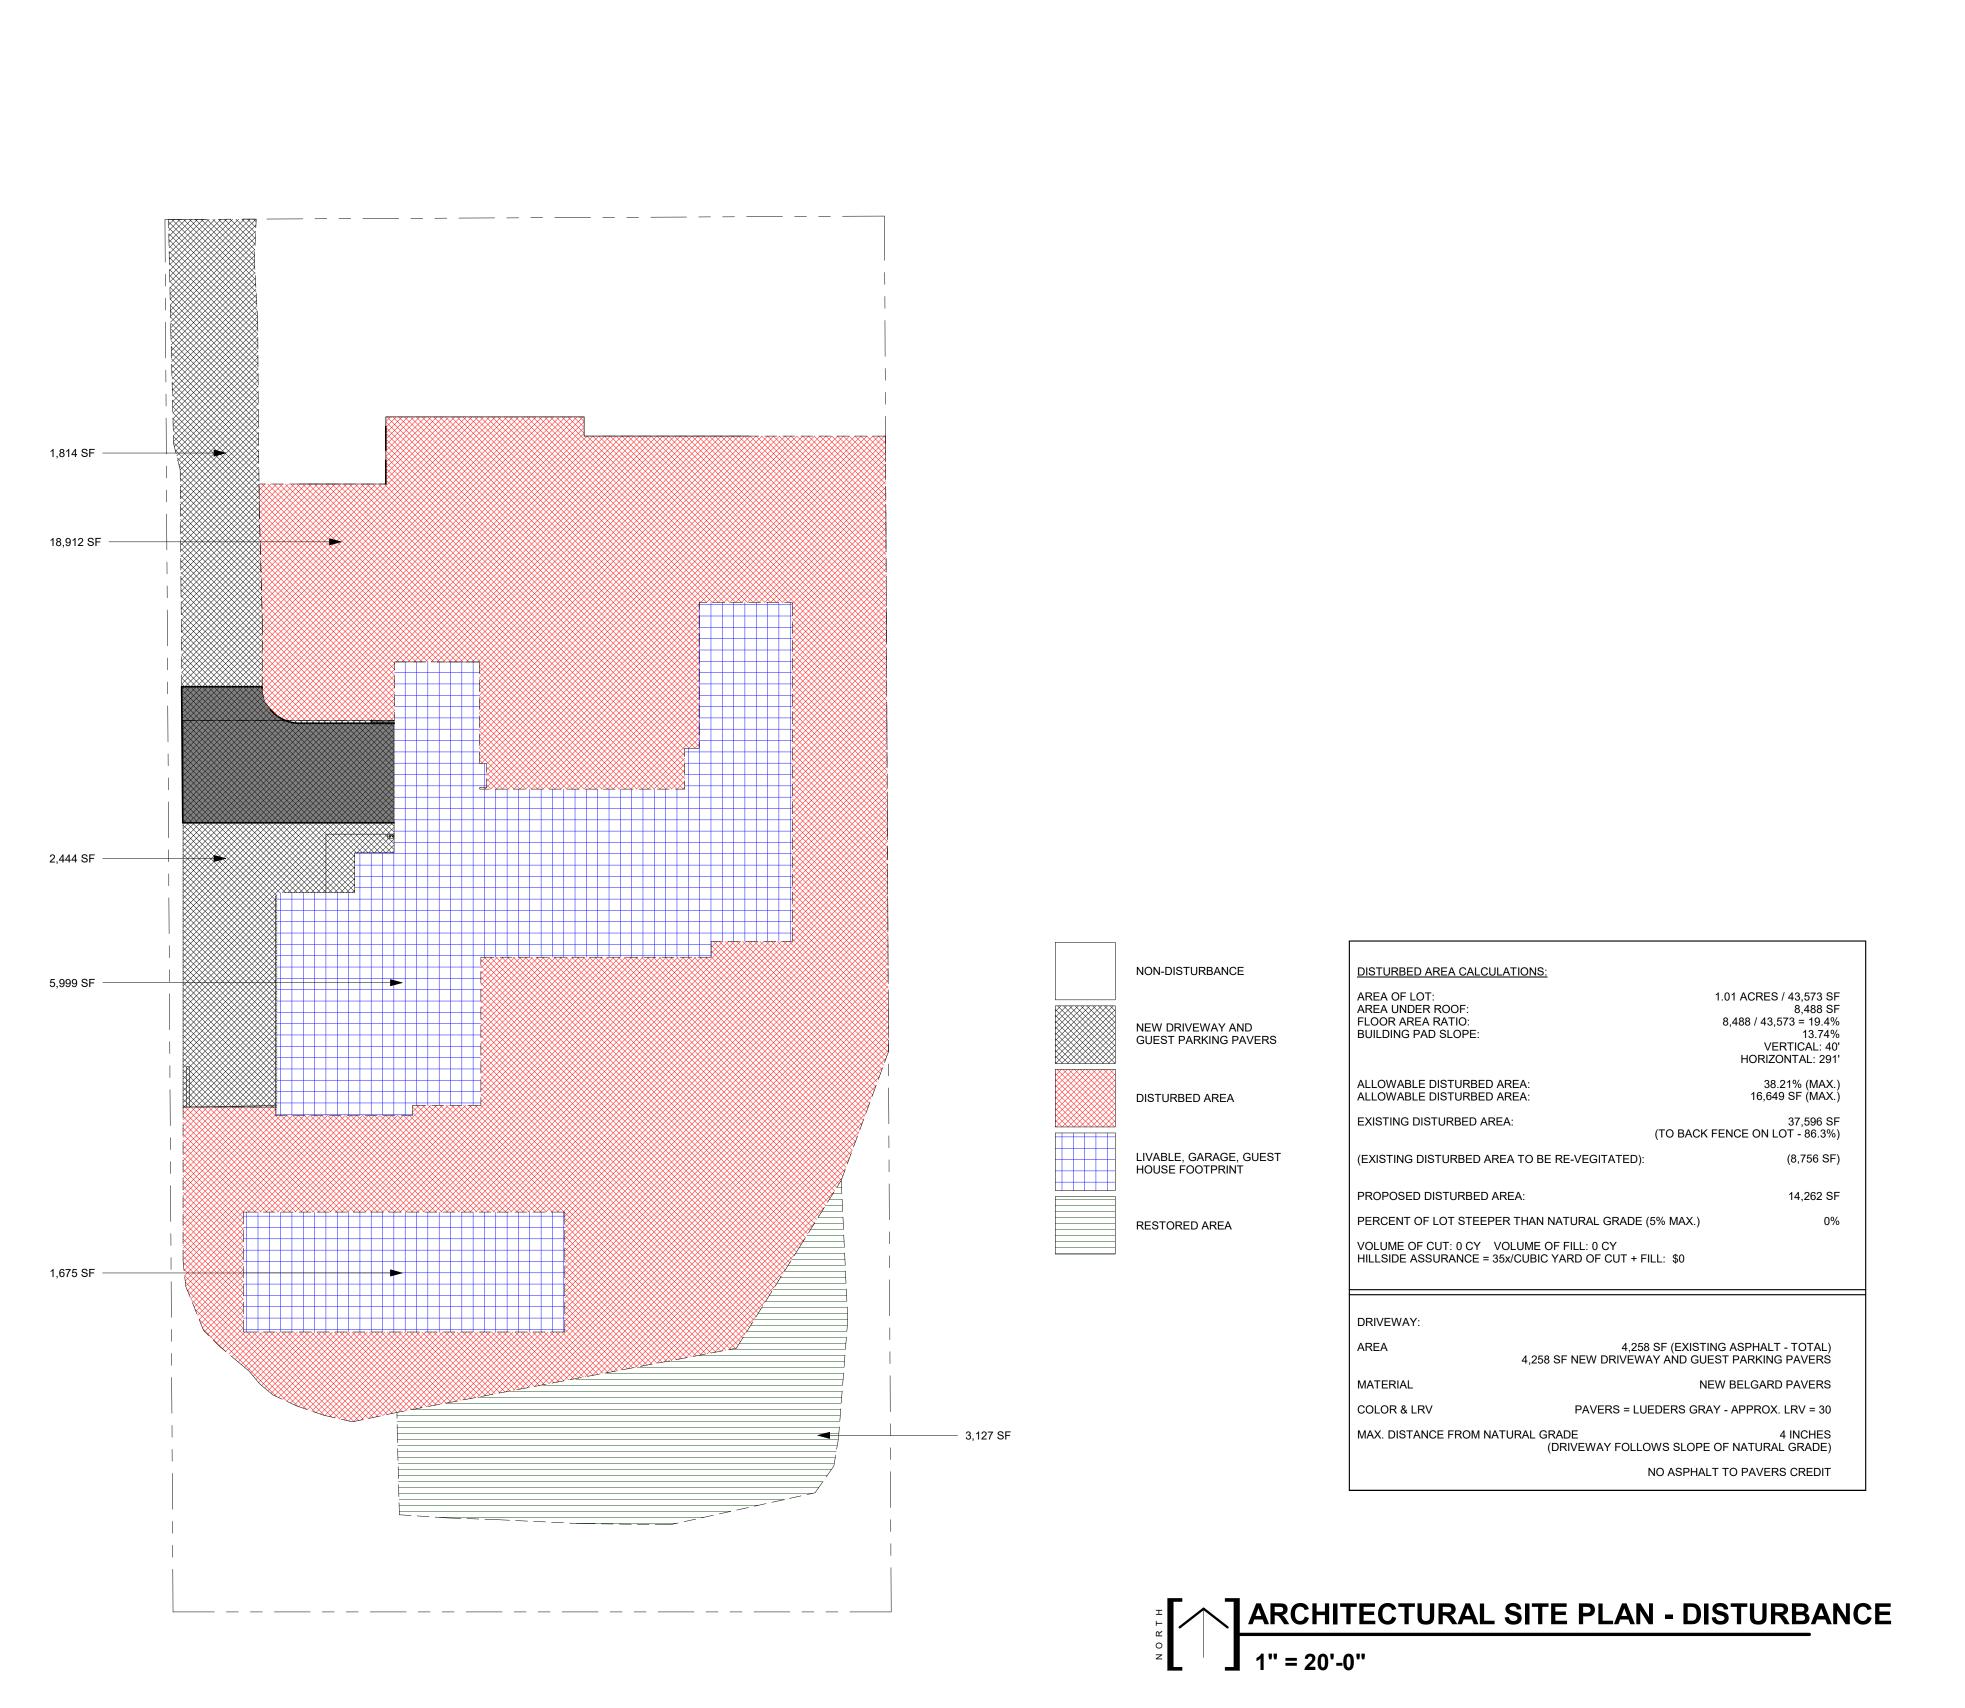

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FOR: HILLSIDE REVIEW

REV # DATE

CAMELBACK **ESTATE**

ARCH. SITE PLAN

Project number


Drawn by Checked by

A1.1b

19-12

11/12/2020

As indicated

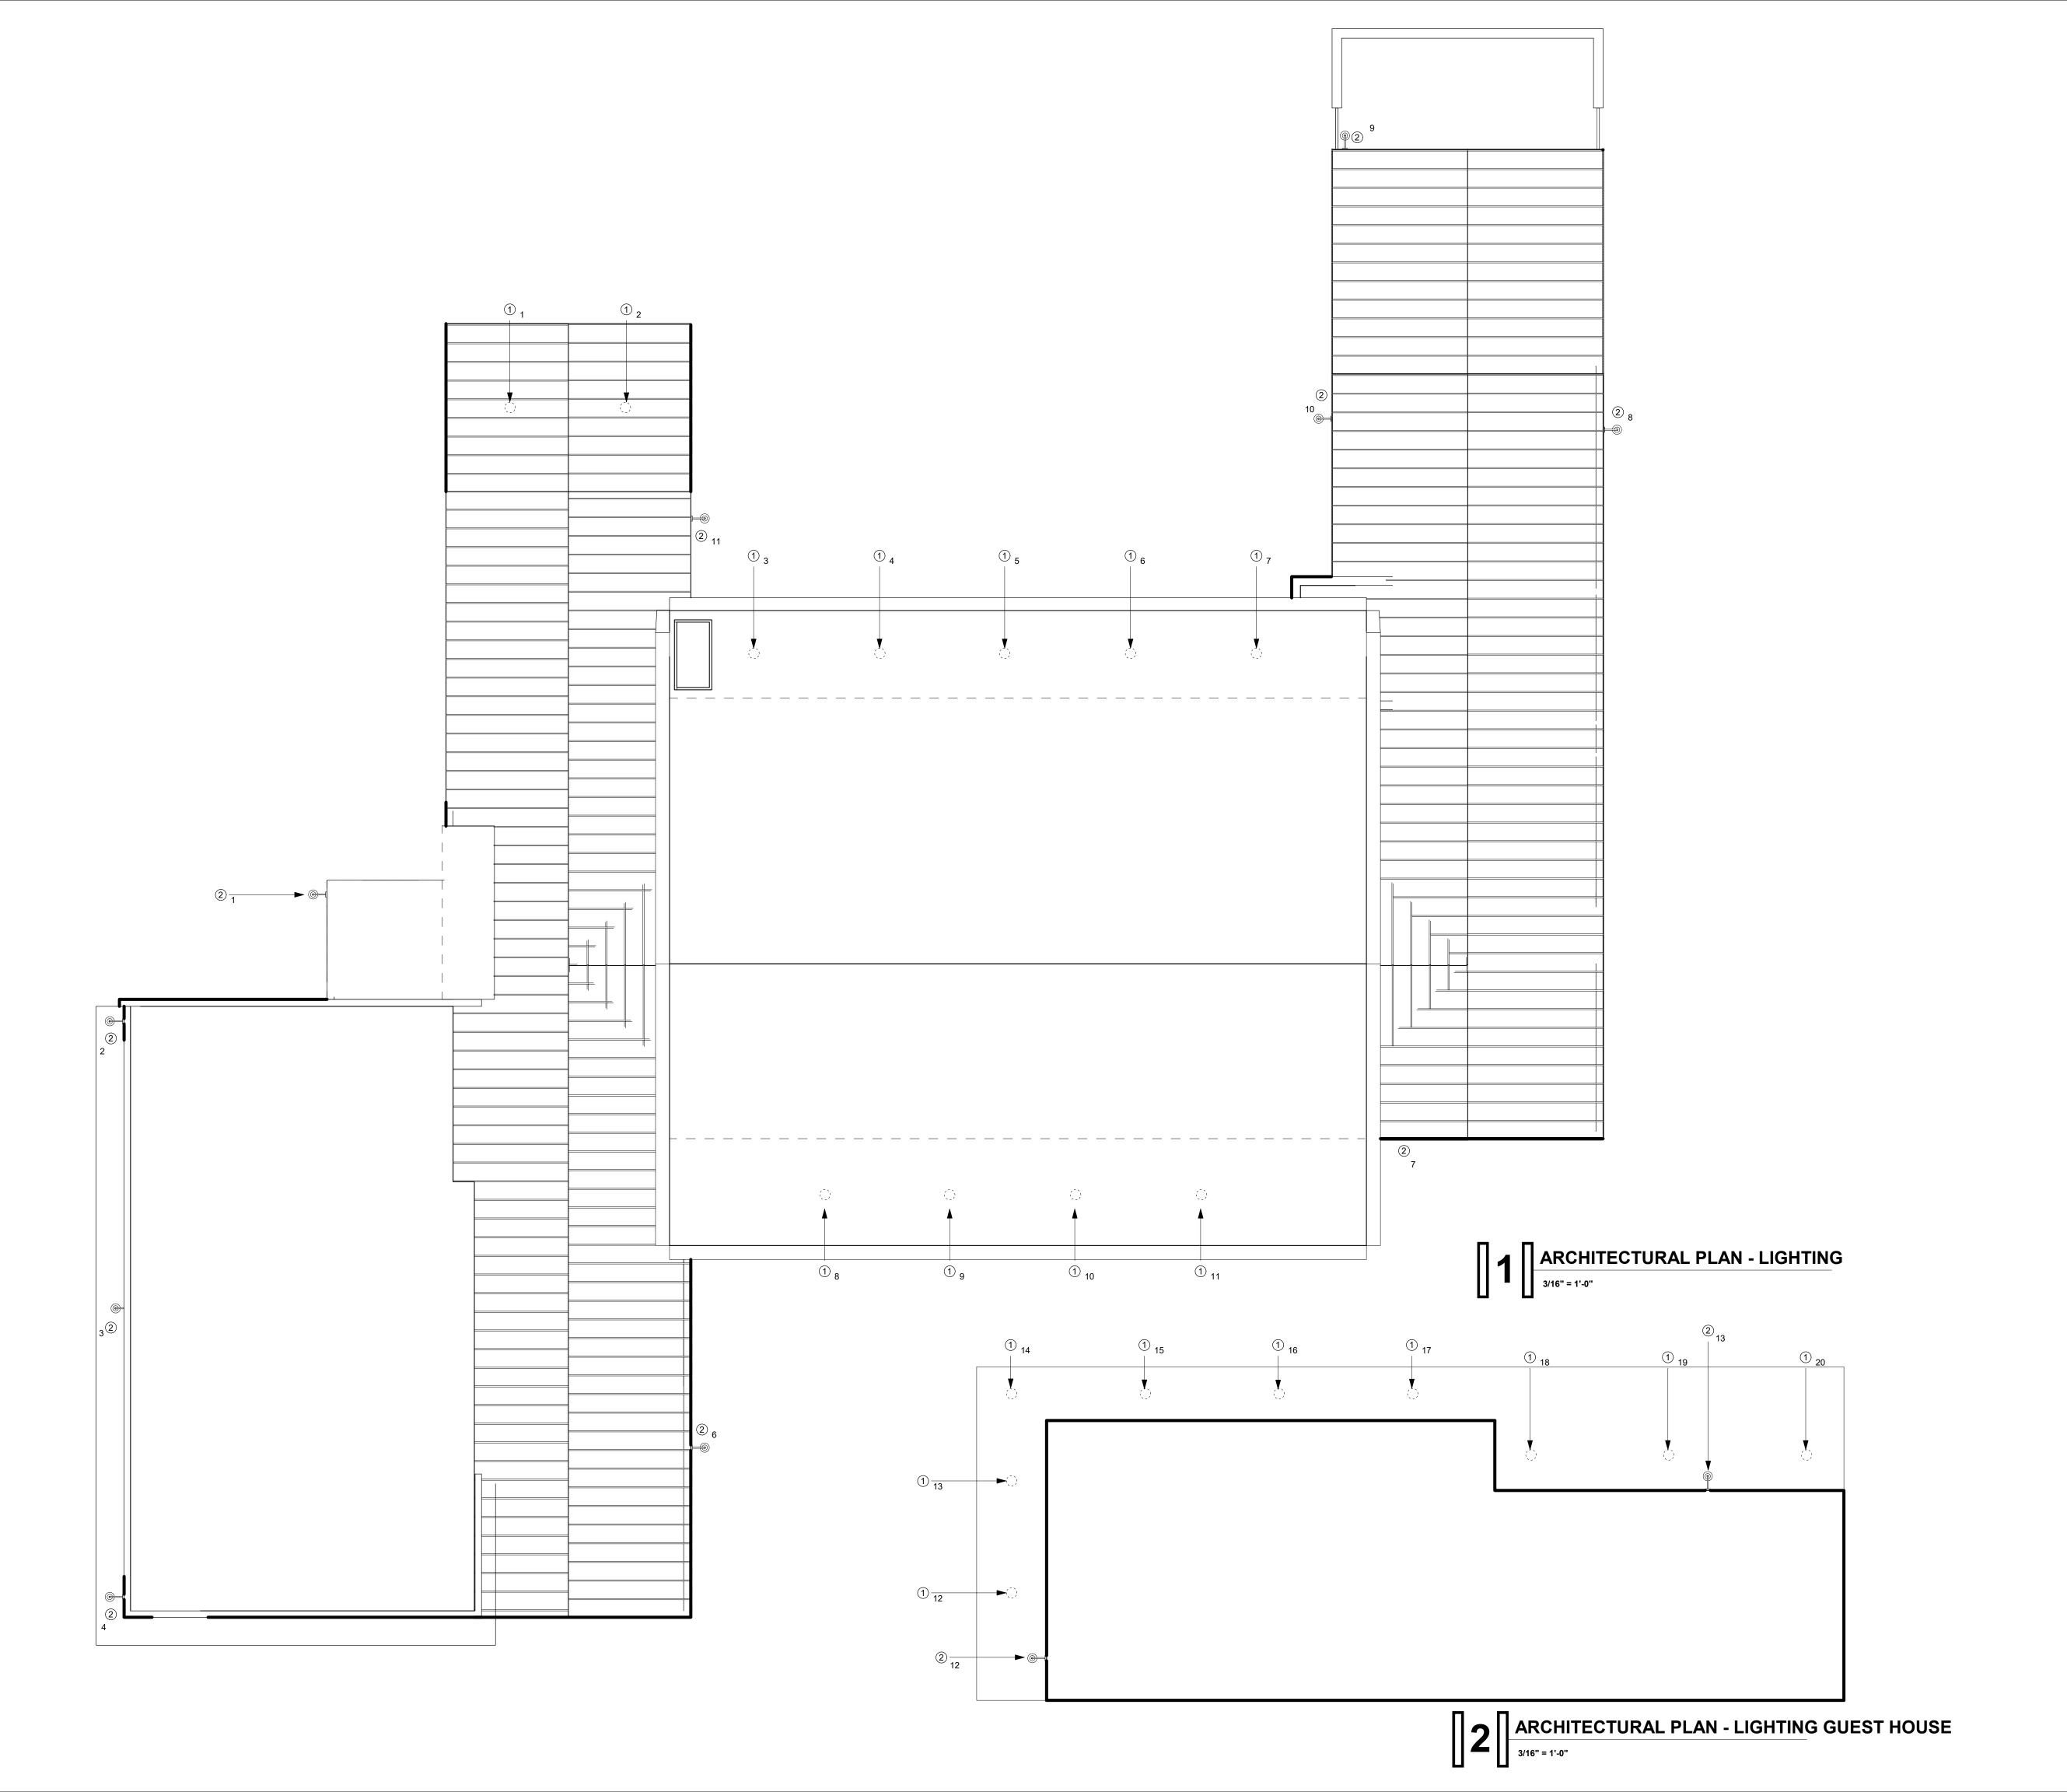



SYMBOL LEGEND

1 - (20) CAN LIGHT (TYP)

- (SYMBOL)

- EXTERIOR UNDERMOUNT CAN LIGHT AT EXTERIOR COVERED PATIO LOCATIONS

- PROGRESS LIGHTING - BLACK FINISH - LRV = 5 (OR EQUIVALENT)

- 725 LUMENS

- 3000 KELVIN

2 - (13) SCONCE LIGHT
- (SYMBOL)

- EXTERIOR WALL MOUNTED SCONCE LIGHT AT DOOR LOCATIONS

- ZUR 24 OUTDOOR WALL " DARK SKY OPTION", BLACK FINISH - LRV = 5 (OR EQUIVALENT)

- 750 LUMENS MAX.

- 3000 KELVIN

NOTE:

SEE MATERIAL BOARD SHEET A0.6 FOR EXTERIOR WALL LIGHT BRAND, COLOR, AND FINISH. LRV = 5.

FOR: HILLSIDE REVIEW

REV # DATE

CAMELBACK ESTATE

LIGHTING PLAN

Project number 19-12


Date 11/12/2020

Drawn by DJB

Checked by DJB

A1.1c

3/16" = 1'-0"

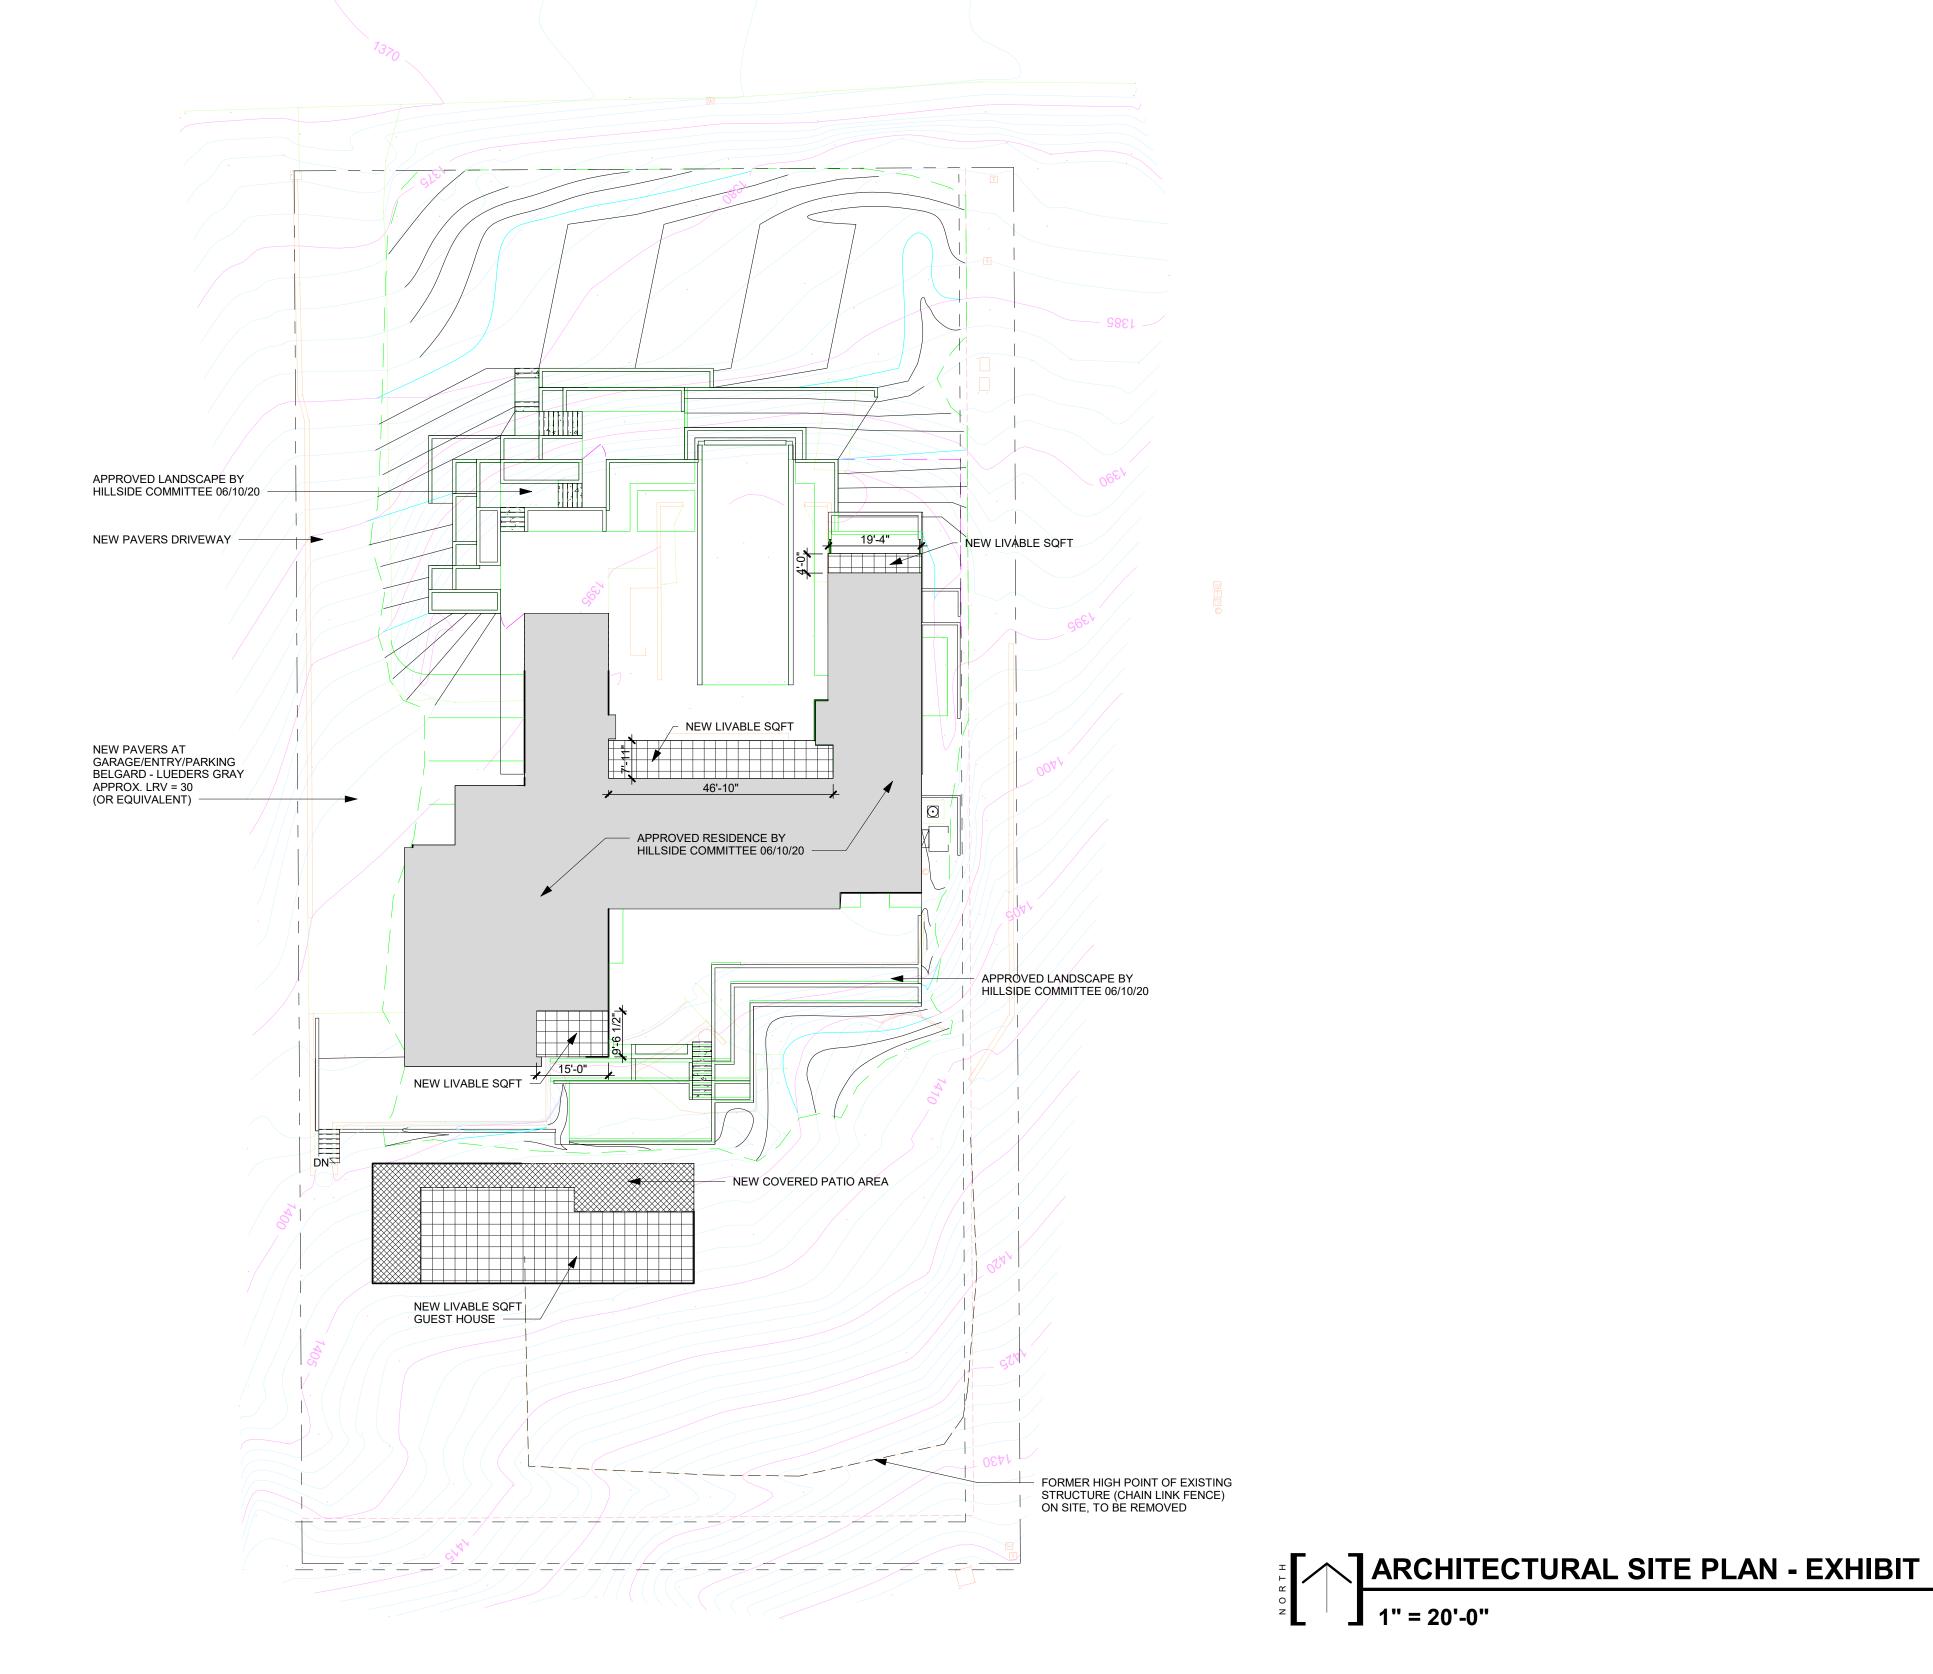

BOWMAN DESIGN GROUP

FOR: HILLSIDE REVIEW

REV# DATE

CAMELBACK ESTATE

HILLSIDE APPROVAL


- EXHIBIT
Project number

Date 11/12/2020
Drawn by DJB
Checked by DJB

A1.1d

19-12



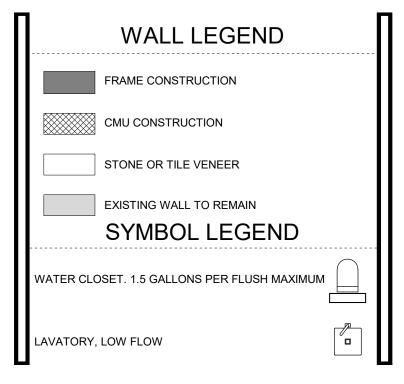

WINDOW NOTES

W-1 EACH SLEEPING ROOM SHALL HAVE AT LEAST ONE OPENABLE OR EXTERIOR WINDOW OR DOOR FOR EMERGENCY ESCAPE OR RESCUE. THE OPENING SHALL PROVIDE A MIN. OF 5.7 S.F. OF NET CLEAR OPENING. THE OPENING SHALL PROVIDE A MIN. OF 24" CLEAR OPENING HEIGHT AND 20" CLEAR OPENING WIDTH. WHERE WINDOWS ARE PROVIDED AS A MEANS OF ESCAPE OR RESCUE, THE FINISH SILL HEIGHT SHALL NOT EXCEED 44" ABOVE FINISH FLOOR.
W-2 PRIMARY WINDOWS (BEDROOMS, LIVING, ETC.) SHALL BE

W-2 PRIMARY WINDOWS (BEDROOMS, LIVING, ETC.) SHALL BE RECESSED MIN 6" TO FACE OF GLASS W-3 SECONDARY WINDOWS (BATHROOMS, CLOSETS, ETC.) SHALL BE RECESSED MIN. 4".

W-4 DIVIDED LIGHTS SHALL BE TRUE DIVIDED OR SIMULATED LIGHT W/ EXTERNAL MUNTINS ON EACH SIDE OF GLASS WITH SHADOW BAR BETWEEN PANES. GLAZING SHALL BE LOW-E COATED CLEAR GLASS.



DIMENSIONS

ADDITIONAL SQUARE FOOTAGE SHOWN WITH

ARCHITECTURE | PLANNING | DESIGN

GENERAL NOTES

BOWMAN

DESIGN

- G-1 WHERE THE HIGHEST POINT OF A CEILING IN A ROOM
 THAT OPENS TO THE HALLWAY SERVING THE BEDROOMS
 EXCEEDS THAT OF THE OPENING INTO THE HALLWAY BY
 24" OR MORE, SMOKE DETECTORS SHALL BE INSTALLED
 IN THE HALLWAY AND IN THE ADJACENT ROOM. PROVIDE
 ADD'L S.D.'S AS APPLICABLE.
- G-2 ALL EXITS SHALL BE OPENABLE FROM THE INSIDE WITHOUT A KEY OR SPECIAL KNOWLEDGE.
- G-3 MANUALLY OPERATED EDGE OR SURFACE MOUNTED FLUSH BOLTS AND SURFACE BOLTS ARE PROHIBITED.
 G-4 PERP. DISTANCE FROM THE FIREPLACE OPENING TO COMBUSTIBLE WALLS SHALL CONFORM TO THE
- I.C.C./N.E.R. REPORT.
 G-5 HEARTH EXTENSIONS: DECORATIVE NONCOMBUSTIBLE
 COMBUSTIBLE MATERIAL SHALL BE INSTALLED OVER A
 THERMAL RESISTIVE BARRIER WHICH COMPLIES WITH
 THE EVALUATION REPORT AND MFR'S WRITTEN
- INSTALLATION MANUAL.

 G-6 ALL PRODUCTS LISTED BY I.C.C. NUMBERS SHALL BE INSTALLED PER THE REPORT AND MFR'S WRITTEN WRITTEN INSTRUCTIONS. PRODUCT SUBSTITUTION(S) FOR ITEM(S) LISTED SHALL ALSO HAVE I.C.C. APPROVED EVALUATION REPORT(S) OR BE APPROVED AND LISTED
- G-7 ALL GLASS IN HAZARDOUS LOCATIONS AND ALL GLASS WITHIN 18" OF FLOOR (EXCEPT SINGLE PANES WITH 9 S.F. OR LESS AREA SHALL BE SAFETY GLASS (SECT. 5406)
- G-8 GAS LINES:
 A. NOT ALLOWED UNDER STRUCT(S).
 B. NOT ALLOWED UNDER SLAB(S).
 C. SHALL CONFORM TO ALL CURRENT CODES

BY OTHER NAT. TESTÈD AGENCIES.

- G-9 PROVIDE 5/8" TYPE "X" GYPSUM BOARD AT ALL WALLS
 AND CEILING OF GARAGE UNLESS SPECIFICALLY
 OTHERWISE PERMITTED BY LOCAL BUILDING OFFICIAL.
 G-10 PROVIDE WATERPROOF COUNTERTOPS AT KITCHEN,
 LAUNDRY, AND ALL BATHROOMS.
 G-11 AT OUT-SWINGING DOORS, PROVIDE LANDING NOT
- LOWER THAN 4 INCHES BELOW TOP OF DOOR
 THRESHOLD, PER R311.4.3 AMENDED. THE WIDTH OF
 EACH LANDING SHALL NOT BE LESS THAN THE DOOR
 SERVED. EVERY LANDING SHALL HAVE A MIN. DIMENSION
 OF 36" MEASURED IN THE DIRECTION OF TRAVEL.
- OF 36" MEASURED IN THE DIRECTION OF TRAVEL.

 G-12 ATTIC ACCESS OPENINGS SHALL NOT BE LESS THAN
 22"x30" AND SHALL PROVIDE A MIN. OF 30" HEADROOM
 AND SHALL BE LOCATED IN A HALLWAY OR READILY
 ACCESSIBLE SPACE PER IRC R807.

 G-13 ALL MECH. EQUIPMENT (AIR COND., POOL EQUIP., ETC.
- SHALL BE SCREENED A MIN. OF 1'-0" ABOVE THE HIGHEST PORTION OF THE EQUIP. FROM ALL SIDES AND SHALL BE COMPATIBLE WITH THE ADJACENT BUILDING. SEE FLOOR PLAN AND SITE PLAN FOR LOCATION OF EQUIP.

 G-14 UNLESS SHOWN OTHERWISE, POSITION DOOR JAMBS 6" OFF THE WALL CONSTRUCTION AND/OR DESIGNATED
- DETAIL.

 G-15 WATER RESISTANT GYPSUM BOARD SHALL NOT BE INSTALLED OVER A VAPOR RETARDER IN A SHOWER OR TUB COMPARTMENT. ALSO INCLUDES AREA SUBJECT TO CONT. HIGH HUMIDITY. CEMENT, FIBER-CEMENT OR GLASS MAT GYPSUM BACKERS INSTALLED IN ACCORDANCE WITH MFR'S RECOMMENDATIONS SHALL BE USED AS BACKERS FOR WALL TILE IN TUB AND SHOWER AREAS AND WALL PANELS IN SHOWER AREAS.

FOR: HILLSIDE REVIEW

REV# DATE

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FLOOR PLAN

 Project number
 19-12


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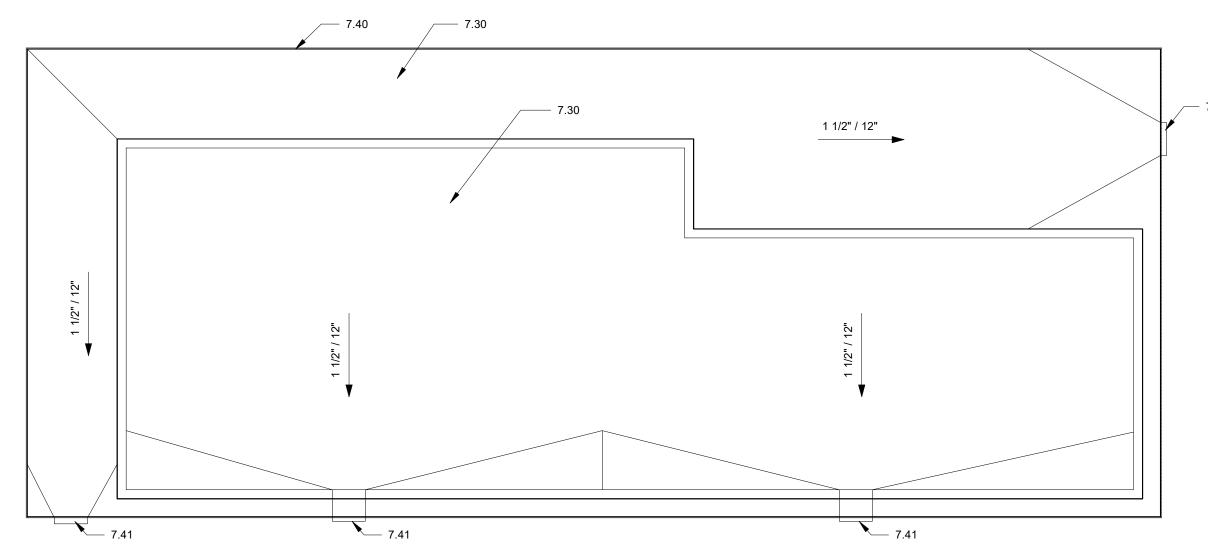
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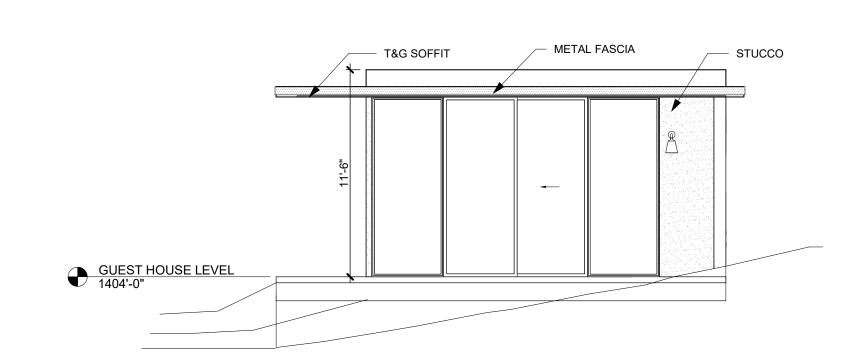


REFLECTED CEILING PLAN GUEST HOUSE

3/16" = 1'-0"




ROOF PLAN GUEST HOUSE
3/16" = 1'-0"

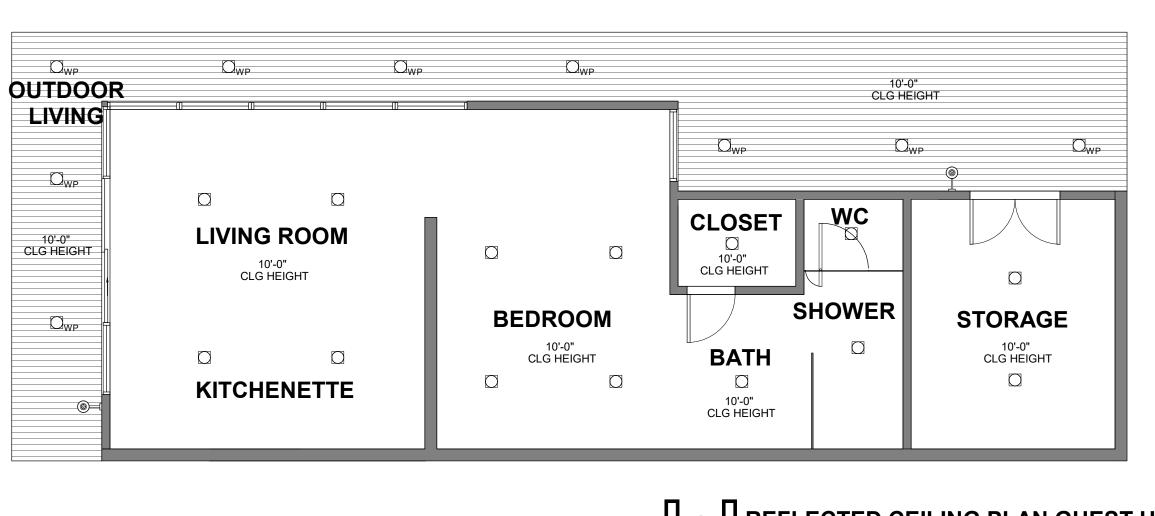


GUEST HOUSE WEST ELEVATION


3/16" = 1'-0"

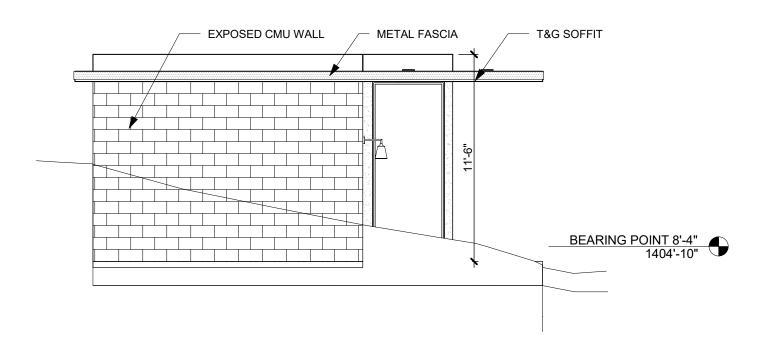

5 GUEST HOUSE EAST ELEVATION


3/16" = 1'-0"

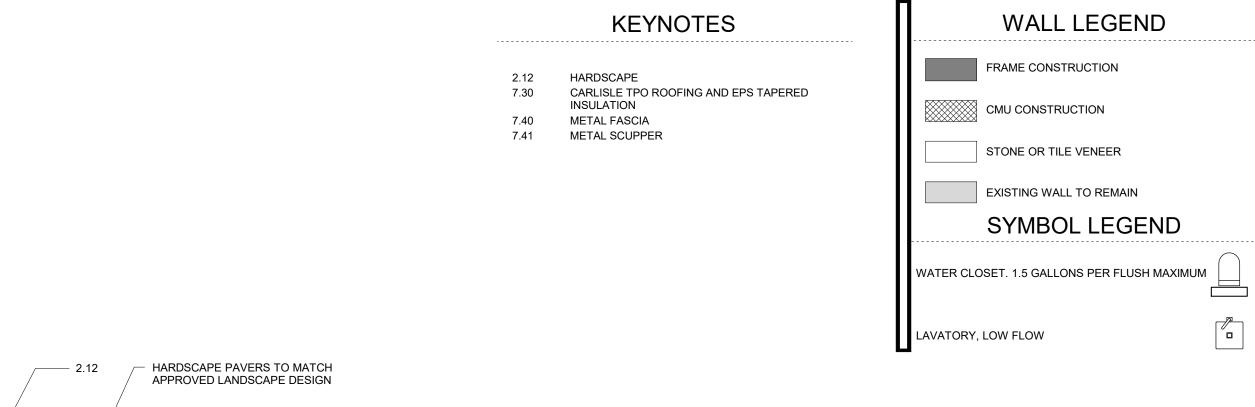

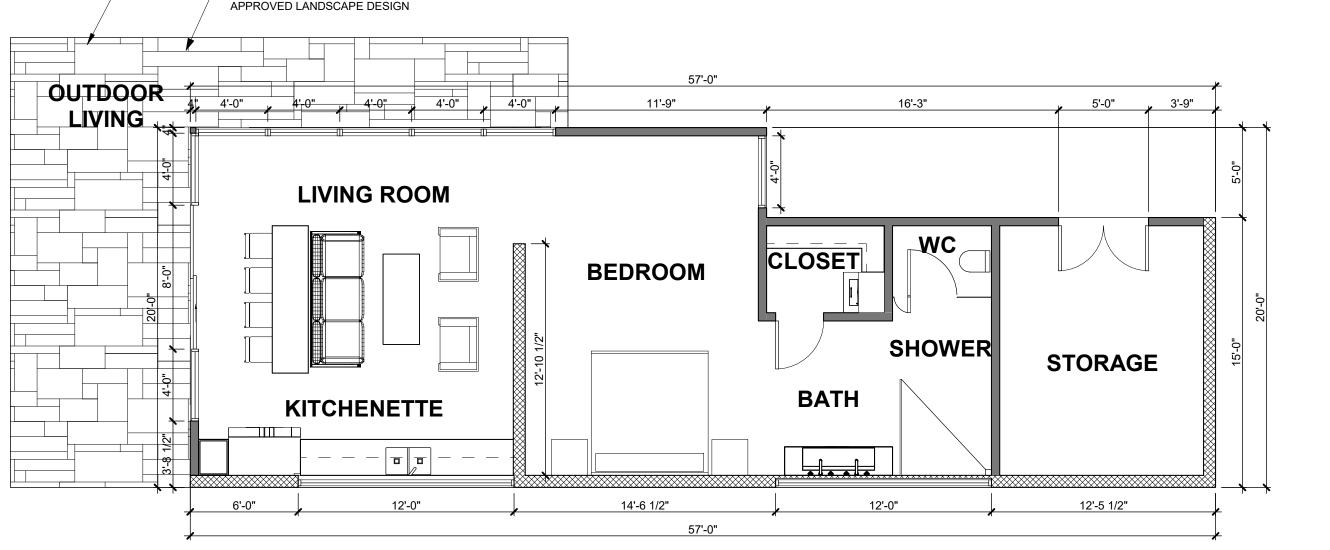


GUEST HOUSE LEVEL

3/16" = 1'-0"

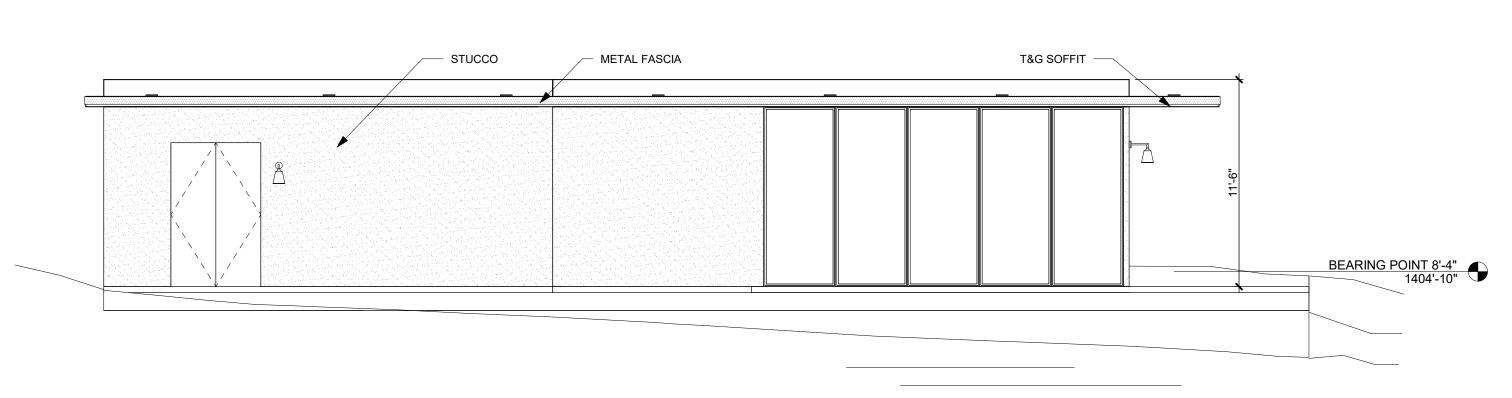

GUEST HOUSE NORTH ELEVATION

3/16" = 1'-0"

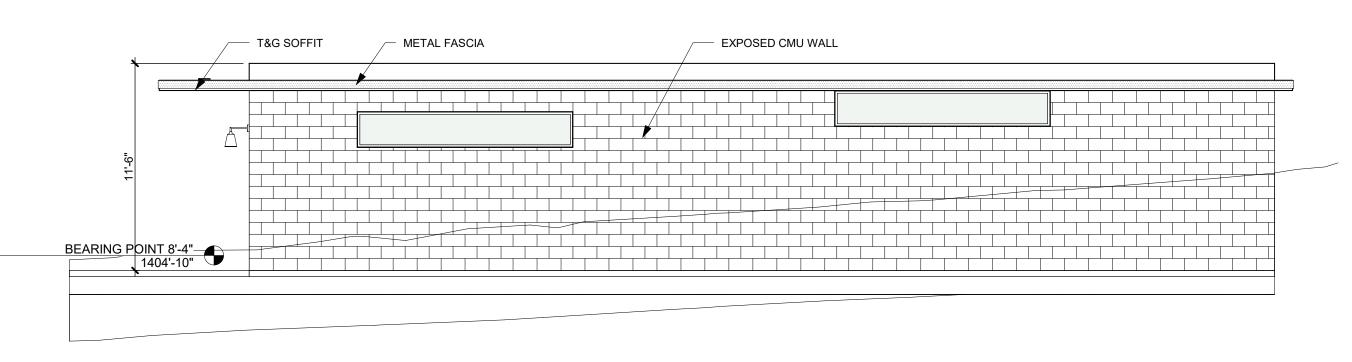

7 GUEST HOUSE SOUTH ELEVATION

3/16" = 1'-0"

BOWMAN DESIGN

ARCHITECTURE | PLANNING | DESIGN

GENERAL NOTES

G-1 MAG ONE-COAT STUCCO COMPLIANCE PROGRAM: ALL ONE-COAT STUCCO SYSTEMS SHALL BE APPLIED BY MFR. APPROVED INSTALLERS. AN APPROVED WEATHER RESISTIVE BARRIER SHALL BE APPLIED OVER ALL FRAMING AND WOOD BASED SHEATHING. ONE-COAT STUCCO SYSTEM SHALL BE "WESTERN ONE KOTE" STUCCO SYSTEM (ICC ESR #1607). THIS ONE-COAT STUCCO SYSTEM SHALL BE APPLIED OVER A WEATHER RESISTIVE BARRIER CONFORMING TO IRC R 703.9. G-2 PROVIDE WEATHER FLASHING/PROOFING AT EXTERIOR WALL PENETRATIONS, INCLUDING WINDOWS, DOORS AND VENTS PER R703.8 G-3 PAINT ALL UTILITARIAN METAL TO MATCH STUCCO U.N.O.
G-4 WEEP SCREED TO BE INSTALLED PER IRC R703.6.2.1
G-5 STUCCO/PLASTER FINISH MATERIAL TO BE INSTALLED PER IRC R703.6.2.

WINDOW NOTES

W-1 EACH SLEEPING ROOM SHALL HAVE AT LEAST ONE OPENABLE OR EXTERIOR WINDOW OR DOOR FOR EMERGENCY ESCAPE OR RESCUE. THE OPENING SHALL PROVIDE A MIN. OF 5.7 S.F. OF NET CLEAR OPENING.
THE OPENING SHALL PROVIDE A MIN. OF 24" CLEAR OPENING HEIGHT AND 20" CLEAR OPENING WIDTH. WHERE WINDOWS ARE PROVIDED AS A MEANS OF ESCAPE OR RESCUE, THE FINISH SILL HEIGHT SHALL NOT EXCEED 44" ABOVE FINISH FLOOR. W-2 PRIMARY WINDOWS (BEDROOMS, LIVING, ETC.) SHALL BE

RECESSED MIN 6" TO FACE OF GLASS
W-3 SECONDARY WINDOWS (BATHROOMS, CLOSETS, ETC.) SHALL BE RECESSED MIN. 4". W-4 DIVIDED LIGHTS SHALL BE TRUE DIVIDED OR SIMULATED LIGHT W/ EXTERNAL MUNTINS ON EACH SIDE OF GLASS WITH SHADOW BAR BETWEEN PANES. GLAZING SHALL

NOTE: ALL DOOR FRAMES AND WINDOW FRAMES TO BE WESTERN WINDOWS AND DOORS, DARK BRONZE ANODIZED COLOR WITH AN LRV NOTO TO EXCEED 38%, OR EQUIVALENT.

BE LOW-E COATED CLEAR GLASS.

MATERIAL LEGEND

STANDING SEAM METAL ROOFING

STUCCO TO COMPLY WITH G1
COLOR: SHERWIN WILLIAMS - NOR'EASTER ESR #1607

STANDING SEAM METAL ROOT INC COLOR = DARK BRONZE ANODIZED LRV = 7

METAL FASCIA
COLOR = DARK BRONZE ANODIZED

TONGUE & GROOVE - SIZE: T.B.D. SHERWIN WILLIAMS - HAWTHORNE - SW3518 APPROX LRV = 20 (OR EQUIVALENT)

MATERIAL NOTES

NOTE:

SEE MATERIAL BOARD A0.6 FOR EXTERIOR SITE MATERIALS, COLOR, FINISH, AND LIGHT REFLECTIVE

FOR: HILLSIDE REVIEW

REV # DATE

Scale


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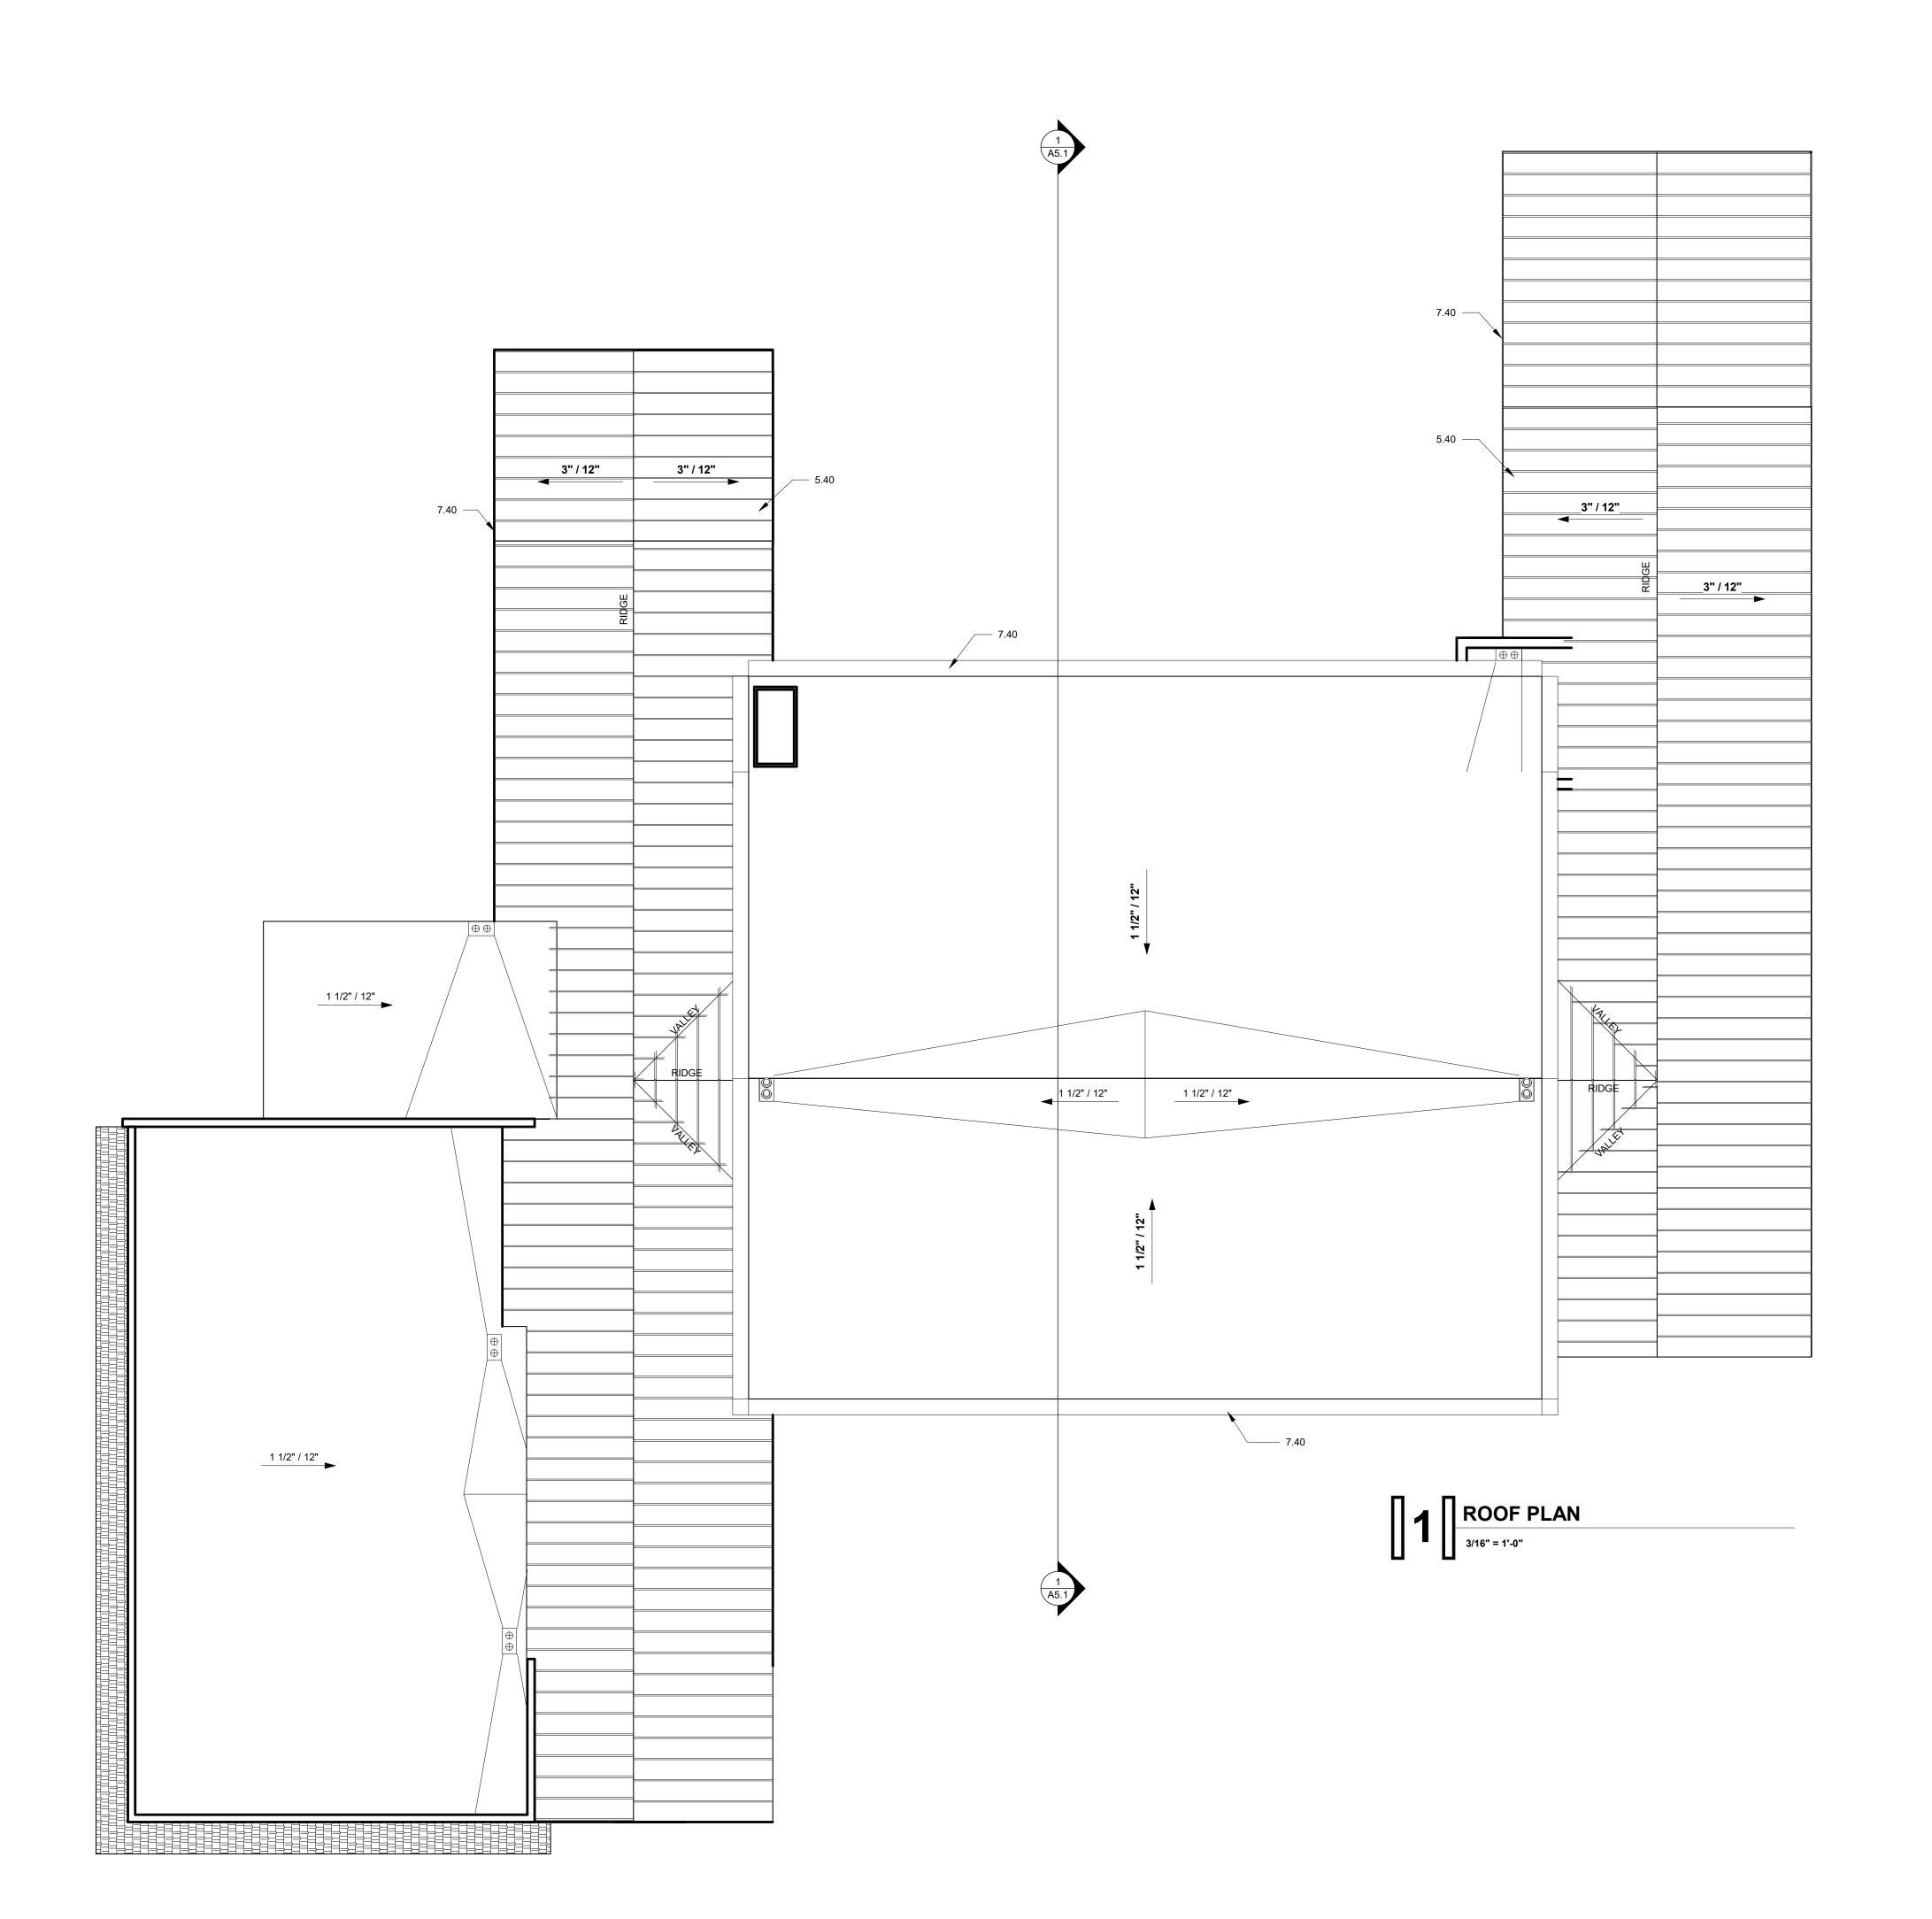
GUEST HOUSE

19-12 Project number 11/12/2020 Drawn by Checked by

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KEYNOTES

5.40 STEEL ROOFING 7.40

NOTE:

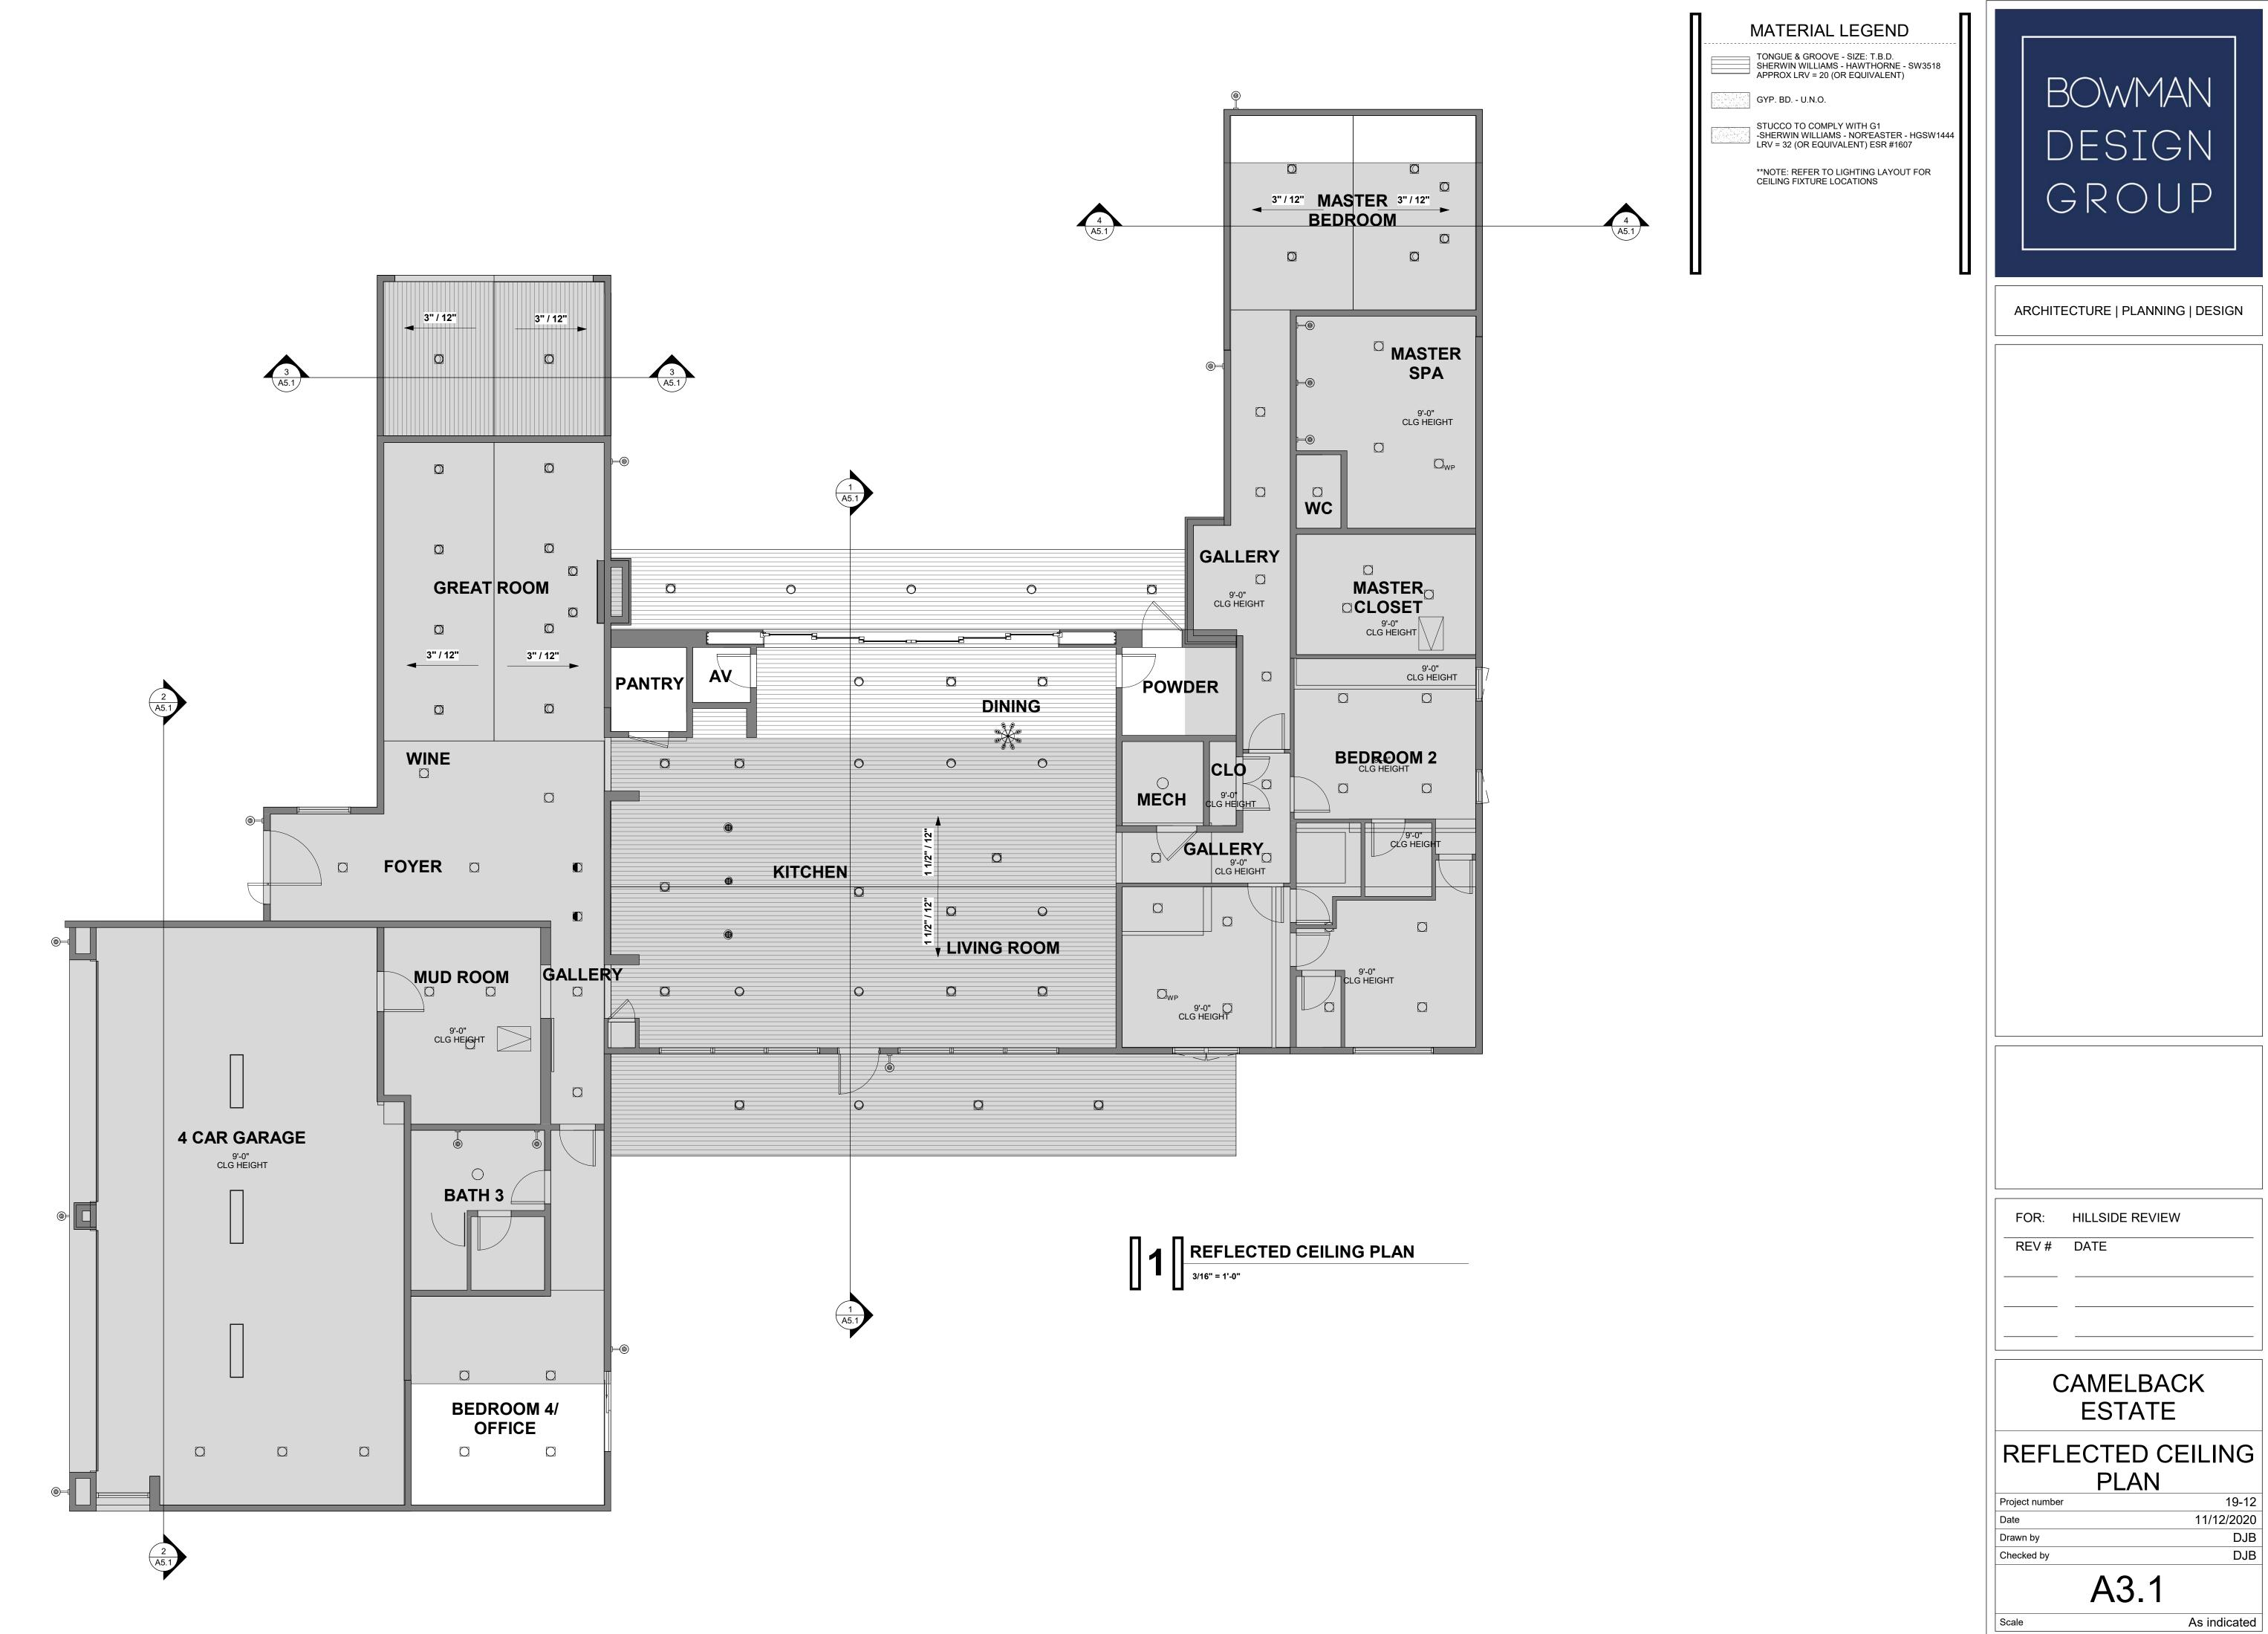METAL FASCIA -MBCI METAL ROOFING AND METAL FASCIA -MIDNIGHT BRONZE - LRV = 7 (OR EQUIVALENT)

PAINT ALL FLAT AREAS OF ROOF SHERWIN WILLIAMS - NOR'EASTER LRV = 32 (OR EQUIVALENT)

GENERAL NOTES

G-1 SEE ROOF FRAMING PLAN FOR SHEATHING

G-2 EXTEND FOAM UP VERTICAL WALL SURFACES AS REQUIRED BY MFR.

REQUIREMENTS.

G-3 PROVIDE FLASHING AND COUNTER-FLASHING AT ALL EDGES OF EXTERIOR WALL FINISH SYSTEM ADJACENT TO ROOF MATERIAL.

G-4 PROVIDE A 6" OVERFLOW DRAIN (2'-0" MEASURED HORIZONTALLY) AND SHALL DISCHARGE TO AN APPROVED LOCATION AND SHALL NOT BE CONNECTED TO ROOF DRAIN LINES. OVERFLOW DRAIN TO BE 2"
ABOVE THE LOWEST ADJACENT ROOF HEIGHT. PROVIDE STRAINERS AT INLETS AS REQUIRED. STRAINERS SHALL EXTEND NOT LESS THAN 4" ABOVE SURFACE OF ROOF AND SHALL HAVE A MINIMUN INLET AREA 1 1/2 TIMES THE PIPE TO WHICH IT IS CONNECTED.

G-5 GALV. FLASHING IN ALL VALLEYS, 8" EACH WAY AND AT ALL PARAPETS.

G-6 GALV. FLASH AT WALLS ABOVE ROOF.

G-7 SINGLE PLY ROOF FINISH COAT SHALL BE COLORED TO MATCH BODY OF HOUSE.

G-8 ALL ROOF VENTS AND EQUIPMENT MUST BE PAINTED TO MATCH BODY OF HOUSE.

G-9 BITUTHANE AT TOPS OF ALL PARAPETS & ALL HORIZ. STUCCO SURFACES.

ATTIC VENTILATION

NOT REQUIRED PER I.R.C. 806.4: CONDITIONED ATTIC REQUIRES NO VENTILATION- FASTEN INSULATION TO INSIDE FACE OF EXTERIOR SHEATHING AT TRUSS & TRUSS FRAMING MEMBERS

SYMBOL LEGEND

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STUCCO TO COMPLY WITH G1
COLOR: SHERWIN WILLIAMS - NOR'EASTER

STANDING SEAM METAL ROOFING COLOR = DARK BRONZE ANODIZED LRV = 7

METAL FASCIA
COLOR = DARK BRONZE ANODIZED
LRV = 7

TONGUE & GROOVE - SIZE: T.B.D.
SHERWIN WILLIAMS - HAWTHORNE - SW3518
APPROX LRV = 20 (OR EQUIVALENT)

FOR: HILLSIDE REVIEW

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ROOF PLAN

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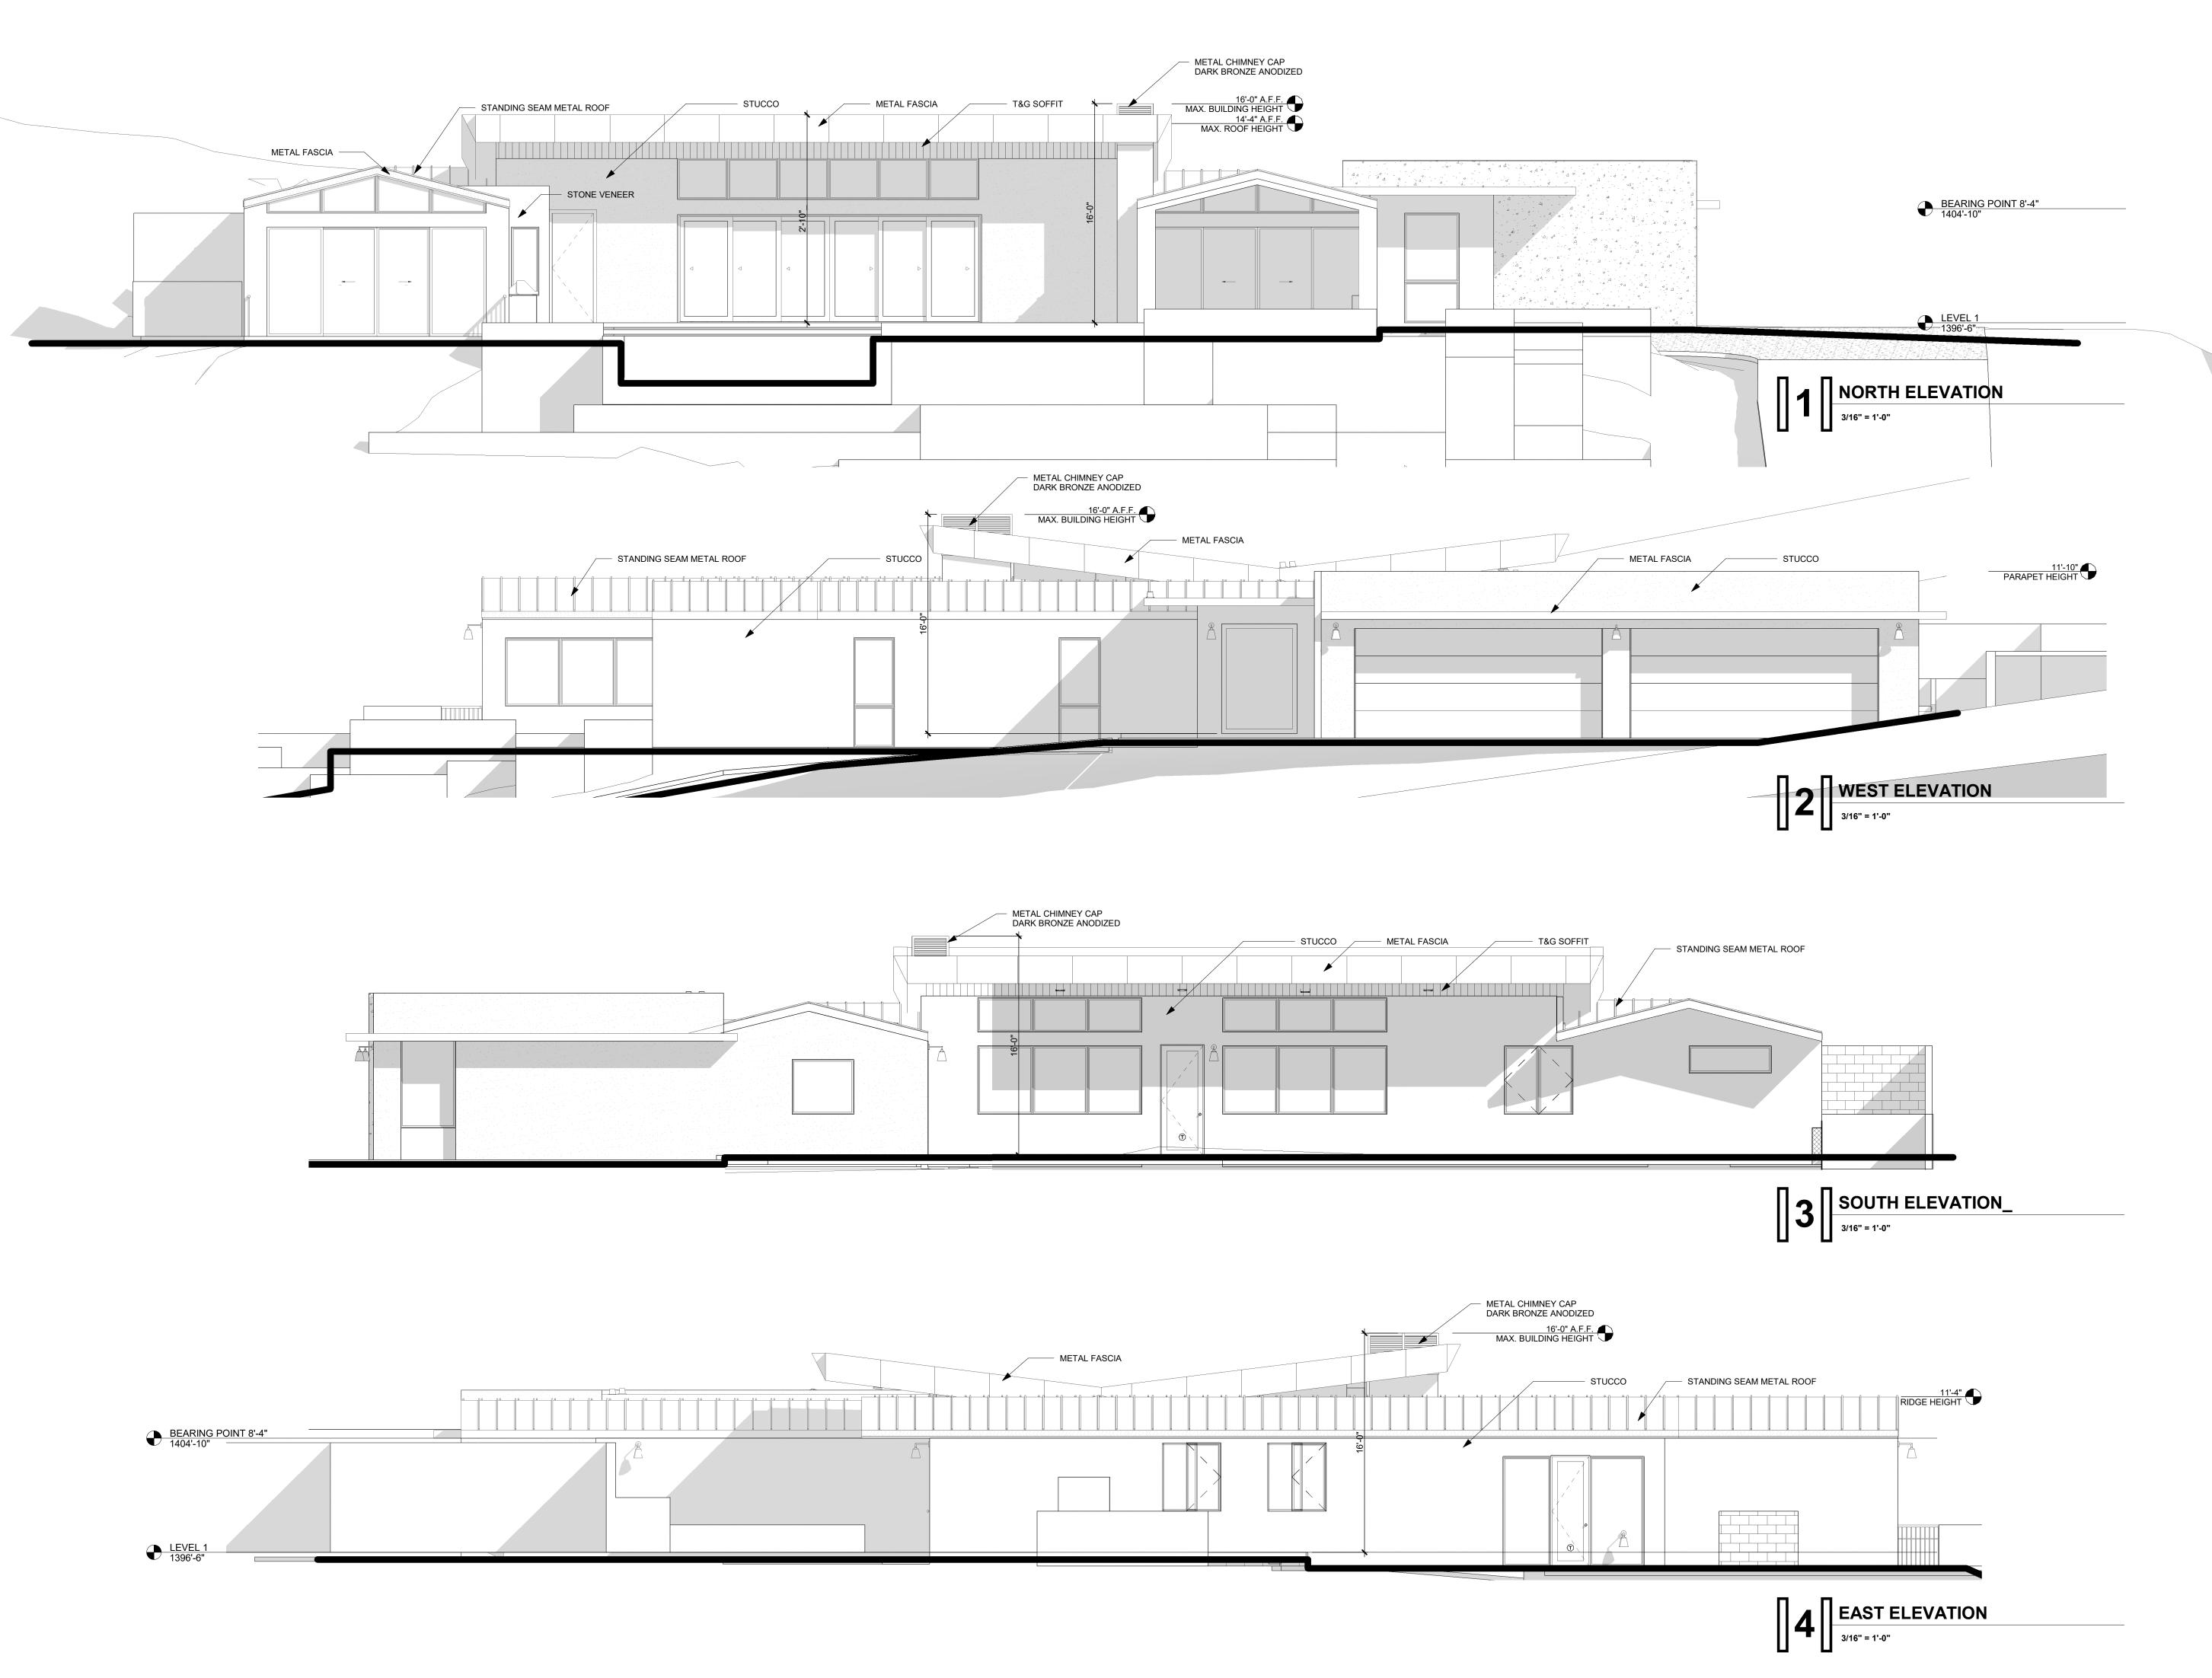
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19-12

Author

Checker

11/12/2020





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WALL PENETRATIONS, INCLUDING WINDOWS, DOORS AND VENTS PER R703.8
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MATERIAL LEGEND

STUCCO TO COMPLY WITH G1
COLOR: SHERWIN WILLIAMS - NOR'EASTER
LRV = 32
ESR #1607

STANDING SEAM METAL ROOFING COLOR = DARK BRONZE ANODIZED LRV = 7

METAL FASCIA
COLOR = DARK BRONZE ANODIZED
LRV = 7

TONGUE & GROOVE - SIZE: T.B.D.
SHERWIN WILLIAMS - HAWTHORNE - SW3518
APPROX LRV = 20 (OR EQUIVALENT)

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EXTERIOR ELEVATIONS

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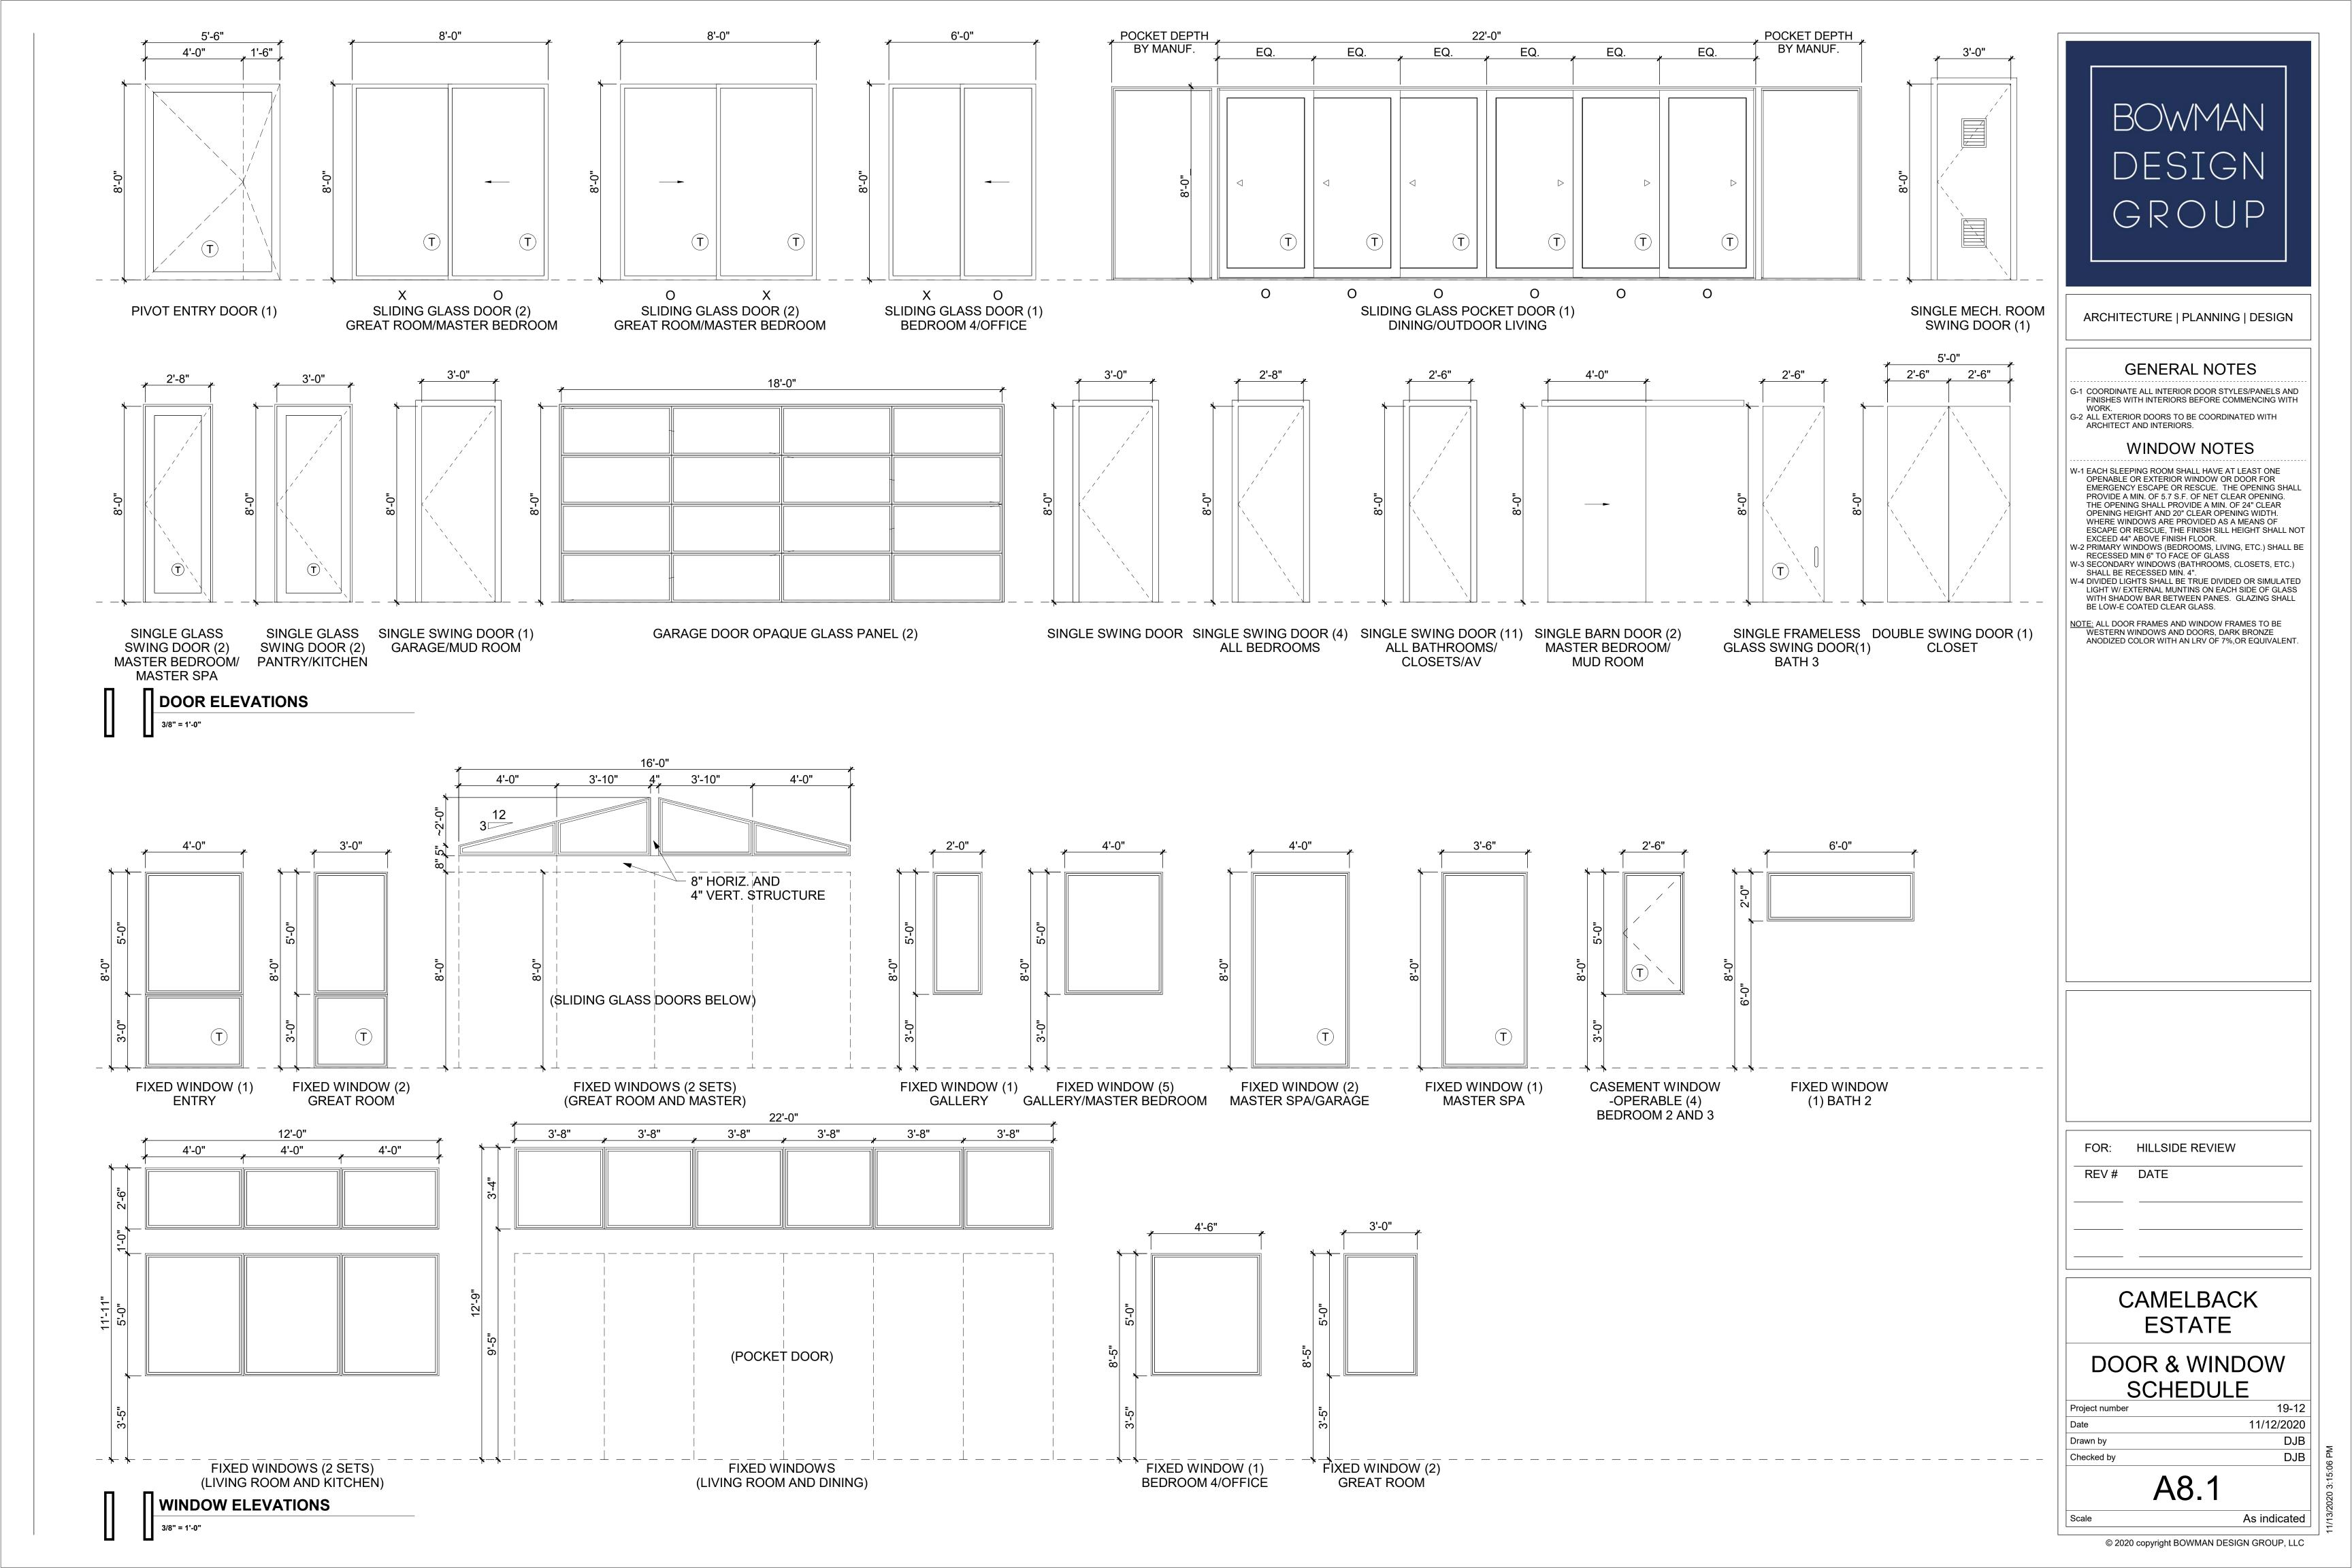
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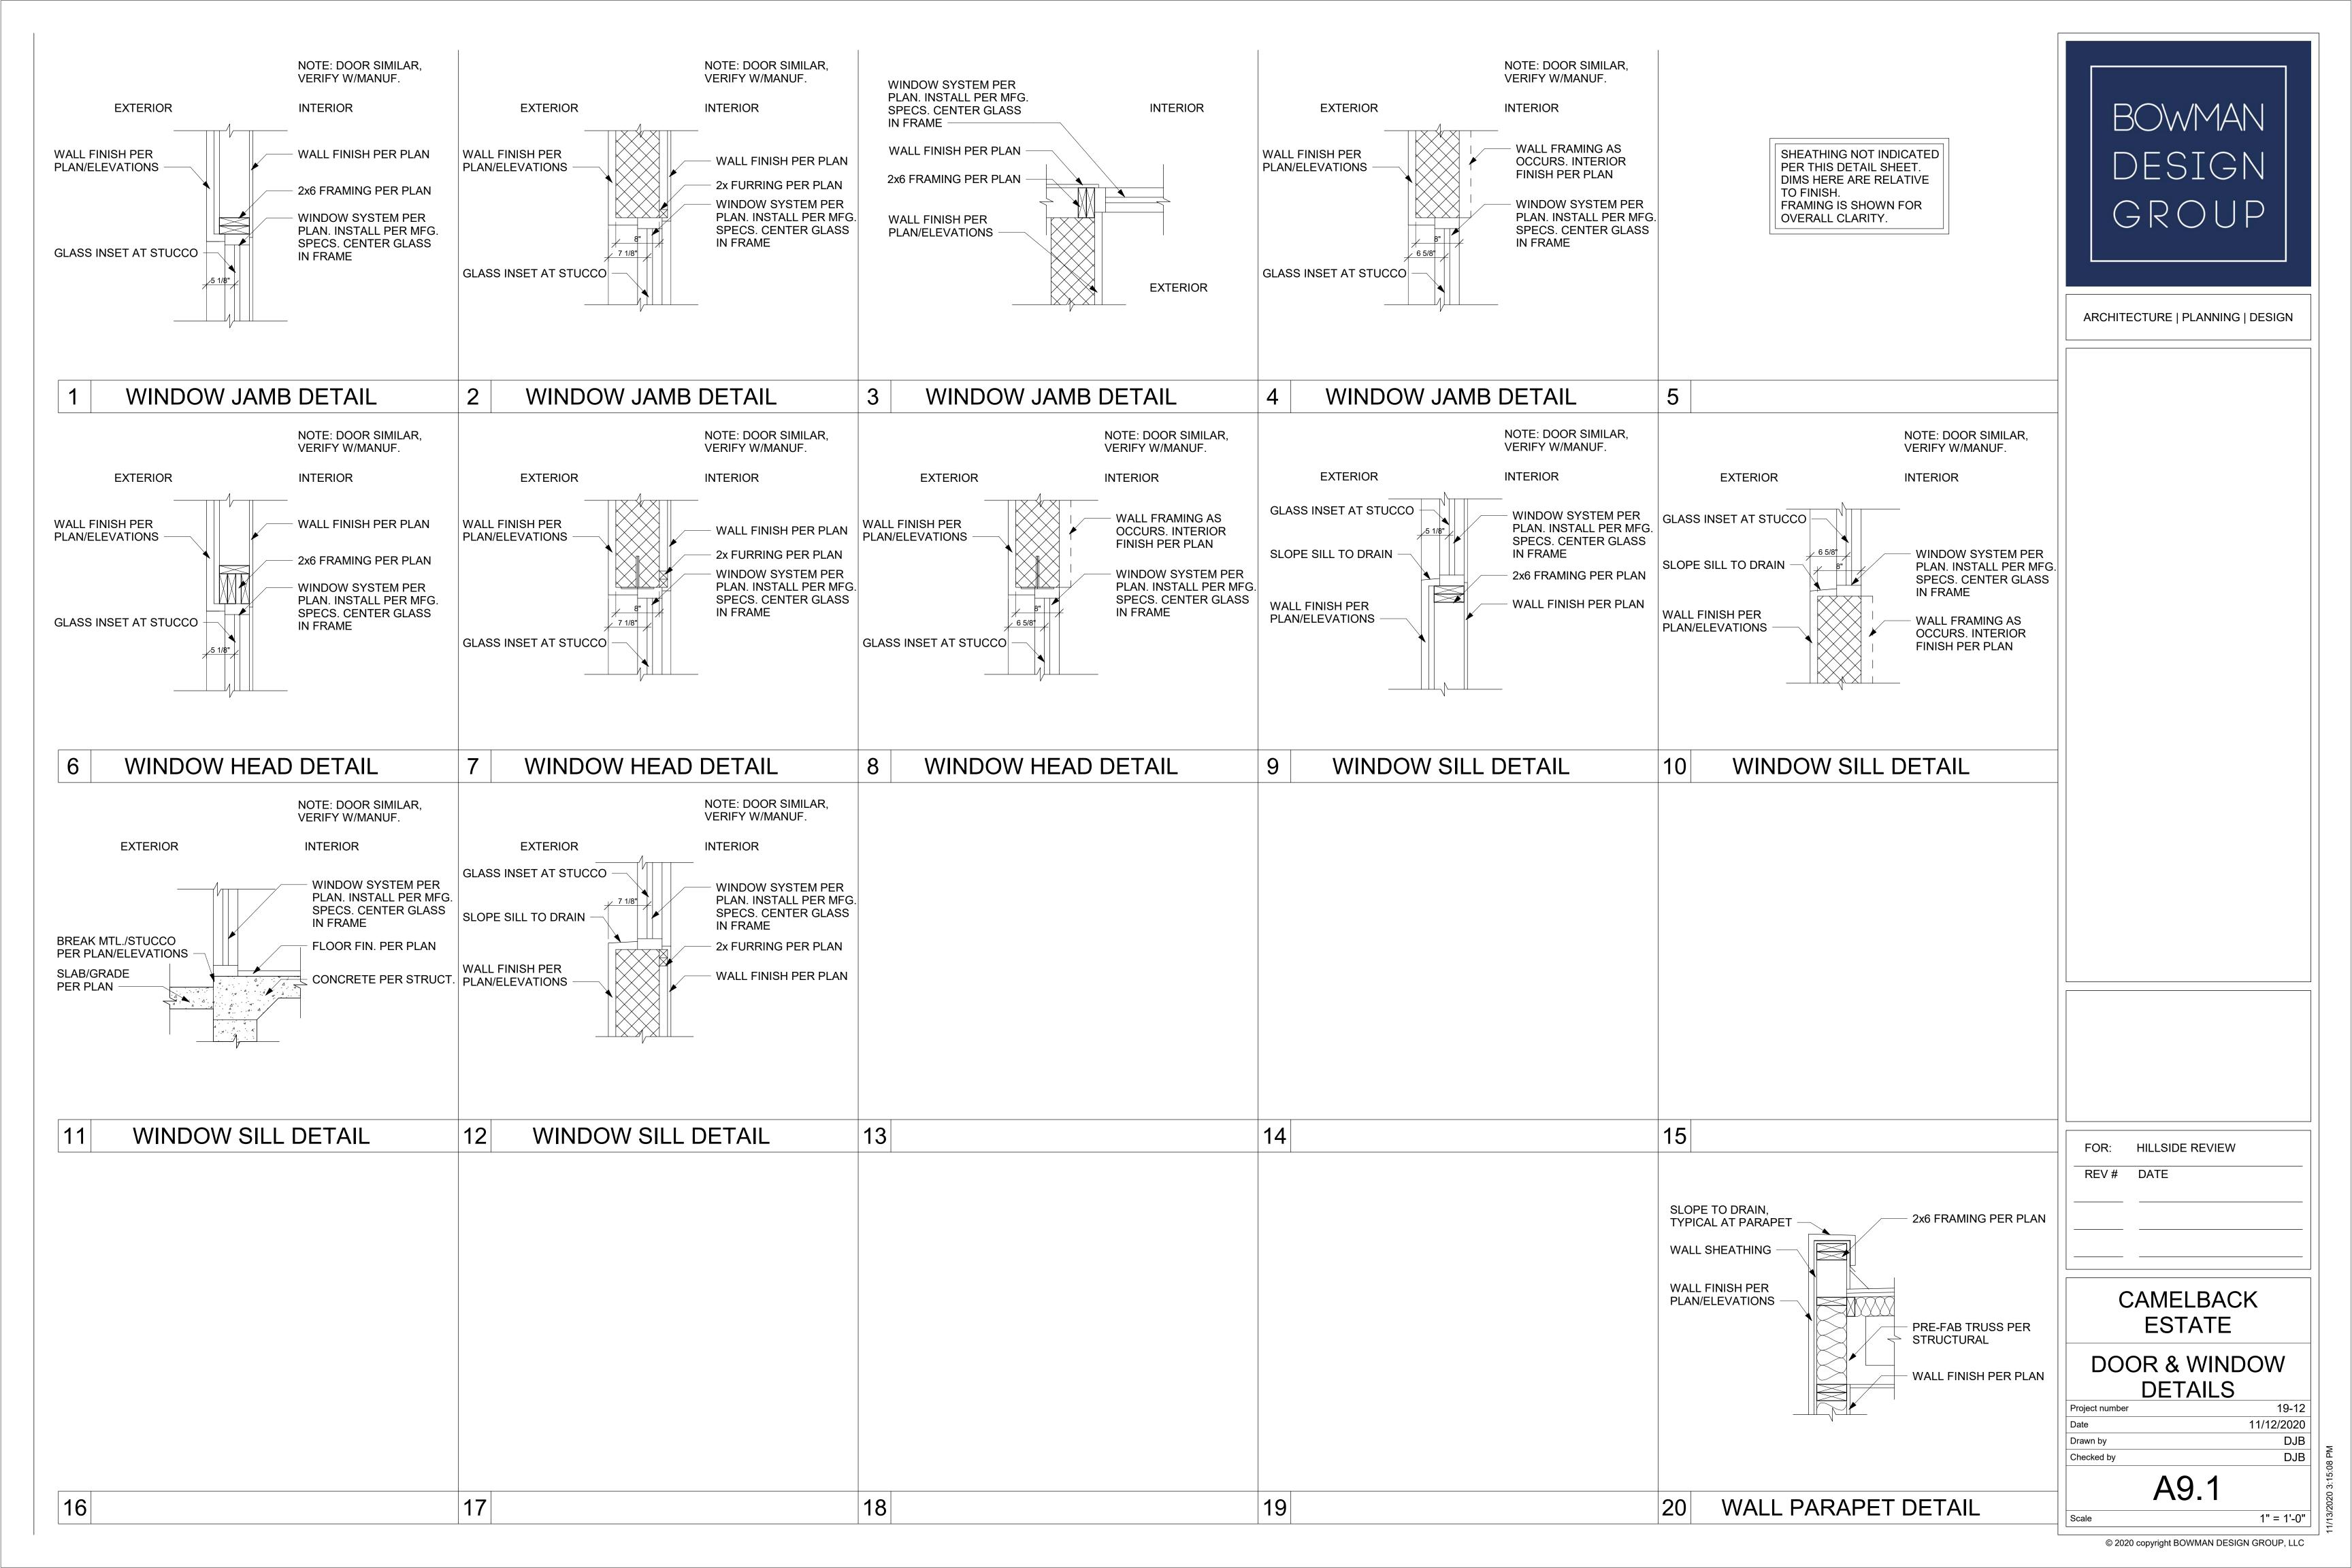
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A6.1

As indicated









KEYNOTES

16.10 ELECTRICAL SERVICE ENTRANCE
16.11 ELECTRICAL SUB-PANEL (FLUSH MOUNT)

GENERAL NOTES

G-1. GARAGE TO BE WIRED AND STUB OUT FOR FUTURE ELECTRIC CAR OUTLET. PANEL WILL NEED A DEDICATED CIRCUIT BREAKER WITH A 240V LINE.
G-2. ALL 125 V RECEPTAQCLES TO BE LISTED TAMPER

SYMBOL LEGEND

RESISTANT.
G-3. 75% OF ALL LIGHTING TO HAVE HIGH EFFECIENCY LAMPS
& ALL RECESSED LIGHTS IN BUILDING ENVELOPE TO BE
SEALED.

STANDARD WALL SWITCH 3-WAY WALL SWITCH STANDARD DUPLEX OUTLET (SEE GEN. NOTE E) 1/2" SWITCHED OUTLET (SEE GEN. NOTE E) FLOOR OUTLET - VERIFY LOCATION WITH OWNER (SEE GEN. NOTE E) 220 V. OUTLET (SEE GEN. NOTE E) 110 V. SMOKE DETECTOR WITH BATTERY BACKUP APPROVED CARBON MONOXIDE ALARM EXHAUST FAN (V.T.O) CAN LIGHT CANNED DIRECTIONAL LIGHT WALL MOUNTED LIGHT PENDENT CEILING LIGHT O SURFACE MOUNTED LIGHT D PUCK.ACCENT LIGHT COMBINATION PHONE / TV GAS VALVE GARAGE DOOR OPENER WEATHER PROOF BOX VAPOR PROOF FIXTURE GROUND FAULT CIRCUIT INTERRUPET 3-WAY CONTROL FOR SWITCH 4-WAY CONTROL FOR SWITCH

CAMELBACK ESTATE

ELECTRIC PLAN

Project number 19-12
Date 11/12/2020
Drawn by DJB
Checked by DJB

E2.1

As indicated