ABBREVIATIONS

ABC		AGGREGATE BASE COURSE
A.F.F.		ABOVE FINISHED FLOOR
C.I.		CAST IRON
C.M.U.		CONCRETE MASONRY UNIT
DW		DISHWASHER
F.O.P.		FACE OF POST
F.O.S.		FACE OF STUD
F.F.		FINISHED FLOOR
FG		FIBER GLASS
FLUOR.		FLUORESCENT (LIGHT FIXTURE)
F.V.		FIELD VERIFY
GSM		GALVANIZED SHEET METAL
GFI		GROUND FAULT CIRCUIT
GYP. BRE	Ð:	GYPSUM BOARD
I.B.C.		INTERNATIONAL BUILDING CODE
I.C.C.		INTERNATIONAL CODE COUNCIL
I.F.C.		INTERNATIONAL FIRE CODE
I.M.C.		INTERNATIONAL MECHANICAL CODE
I.P.C.		INTERNATIONAL PLUMBING CODE
I.R.C.		INTERNATIONAL RESIDENTIAL CODE
MFR.		MANUFACTURER
MICRO		MICROWAVE OVEN
N.E.C.		NATIONAL ELECTRIC CODE
N.T.S.		NOT TO SCALE
O.A		OVER ALL
O.C.		ON CENTER
P.E.N.		PERIMETER EDGE NAILING
PTDF		PRESSURE TREATED DOUGLAS FIR
P.L.F.		PER LINEAR FOOT
REF -		REFRIGERATOR
R -		RISER (ie 16R=16 RISERS)
SPECS.		SPECIFICATIONS
SS -		STAINLESS STEEL
TEMP.		TEMPERED GLASS
TC -		TRASH COMPACTOR
TYP.		TYPICAL
U.O.N		UNLESS OTHERWISE NOTED
WC -		WATER CLOSET
WP -		WATER PROOF
WI -		WROUGHT IRON
WWF -		WELDED WIRE FABRIC
Г		

PUULS, SPAS& HUT TUBS

SWIMMING POOL IS DEFINED AS ANY CONTAINED BODY OF WATER 18 INCHES (457 MM) AT ANY POINT. THIS INCLUDES IN-GROUND, ABOVE GROUND AND ON-GROUND SWIMMING POOLS AND HOT TUBS AND SPAS. BARRIER REQUIREMENTS

THE PROVISIONS OF THIS CHAPTER SHALL CONTROL THE DESIGN OF BARRIERS FOR RESIDENTIAL SWIMMING POOLS. SPAS AND HOT TUBS. THESE DESIGN CONTROLS ARE INTENDED TO PROVIDE PROTECTION AGAINST POTENTIAL DROWNINGS AND NEAR DROWNINGS BY RESTRICTING ACCESS TO SWIMMING POOLS, SPAS AND HOT TUBS.

AN OUTDOOR SWIMMING POOL, INCLUDING AN IN-GROUND, ABOVE-GROUND OR ON-GROUND POOL, HOT TUB OR SPA SHALL BE SURROUNDED BY A BARRIER WHICH SHALL COMPLY WITH THE FOLLOWING:

- THE TOP OF THE BARRIER SHALL BE AT LEAST 60 INCHES (1524 MM) ABOVE GRADE MEASURED ON THE SIDE OF THE BARRIER WHICH FACES AWAY FROM THE SWIMMING POOL. THE TOP OF THE BARRIER THAT SEPARATES THE SWIMMING POOL ONLY FROM HABITABLE SPACES ON THE SAME PROPERTY SHALL BE AT LEAST 48 INCHES (1219 MM) ABOVE GRADE MEASURED ON THE SIDE OF THE BARRIER WHICH FACES AWAY FROM THE SWIMMING POOL THÉ MAXIMUM VERTICAL CLEARANCE BETWEEN GRADE AND THE BOTTOM OF THE BARRIER SHALL BE 2 INCHES (51 MM). THE MAXIMUM VERTICAL CLEARANCE AT THE BOTTOM OF THE BARRIER MAY BE INCREASED TO 4 INCHES (102 MM) WHEN GRADE IS A SOLID SURFACE SUCH AS CONCRETE. THE BARRIER SHALL BE AT LEAST 20 INCHES FROM THE WATER'S EDGE.
- OPENINGS IN THE BARRIER SHALL NOT ALLOW PASSAGE OF A 4 INCH DIAMETER (102 MM) SPHERE. ANY DECORATIVE DESIGN WORK SUCH AS PROTRUSIONS, INDENTATIONS OR CUTOUTS WHICH MAKE THE BARRIER EASILY CLIMBABLE IS PROHIBITED. SOLID BARRIERS WHICH DO NOT HAVE OPENINGS. SUCH AS MASONRY OR STONE WALL, SHALL NOT CONTAIN
- INDENTATIONS OR PROTRUSIONS EXCEPT FOR NORMAL CONSTRUCTION TOLERANCES AND TOOLED MASONRY JOINTS THERE SHALL BE AT LEAST 45" INCHES BETWEEN HORIZONTAL ELEMENTS.
- MAXIMUM MESH SIZE FOR CHAIN LINK FENCES SHALL BE A 2 1/4 INCH (57 MM) SQUARE UNLESS THE FENCE HAS SLATS FASTENED AT THE TOP OR THE BOTTOM WHICH REDUCE THE OPENINGS TO NOT MORE THAN 1 3/4 INCHES (44 MM). CHAIN LINK FENCING SHALL NOT BE LESS THAN 11 GAUGE. WHERE THE BARRIER IS COMPOSED OF DIAGONAL MEMBERS, SUCH AS A LATTICE FENCE, THE MAXIMUM
- OPENING FORMED BY THE DIAGONAL MEMBERS SHALL NOT BE MORE THAN 1 3/4 INCHES (44MM). ACCESS GATES SHALL COMPLY WITH THE REQUIREMENTS OF THIS SECTION. ITEMS 1 THROUGH 6. AND SHALL BI EQUIPPED TO ACCOMMODATE A LOCKING DEVICE. PEDESTRIAN ACCESS GATES SHALL OPEN OUTWARD AWAY FROM THE POOL AND SHALL BE SELF-CLOSING AND HAVE A SELF-LATCHING DEVICE. GATES OTHER THAN PEDESTRIAN ACCESS GATES SHALL BE LOCKABLE. WHERE THE RELEASE MECHANISM OF THE SELF-LATCHING DEVICE IS LOCATED LESS THAN 54 INCHES (1372 MM) FROM THE BOTTOM OF THE GATE, THE RELEASE MECHANISM AND OPENINGS SHALL COMPLY WITH THE FOLLOWING:
- 7.1. THE RELEASE MECHANISM SHALL BE LOCATED ON THE POOL SIDE OF THE GATE AT LEAST 3 INCHES (76 MM) BELOW THE TOP OF THE GATE; AND 7.2. THE GATE AND BARRIER SHALL HAVE NO OPENING LARGER THAN 1/2 INCH (13 MM) WITHIN 18 INCHES (457 MM) OF THE BELEASE MECHANISM WHERE A WALL OF A DWELLING SERVES AS PART OF THE BARRIER, ONE OF THE FOLLOWING CONDITIONS SHALL
- BE MET 8.1. IN LIEU OF THE BARRIER BETWEEN THE DWELLING AND THE SWIMMING POOL, THE SWIMMING POOL SHALL BE EQUIPPED WITH A POWERED SAFETY COVER IN COMPLIANCE WITH ASTM F1346; OR 8.2. DOORS WITH DIRECT ACCESS TO THE POOL THROUGH THAT WALL SHALL BE EQUIPPED WITH AN ALARM WHICH PRODUCES AN AUDIBLE WARNING WHEN THE DOOR AND/OR ITS SCREEN, IF PRESENT, ARE OPENED. THE ALABM SHALL BE LISTED IN ACCORDANCE WITH UL 2017. THE AUDIBLE ALABM SHALL ACTIVATE WITHIN 7 SECONDS AND SOUND CONTINUOUSLY FOR A MINIMUM OF 30 SECONDS AFTER THI
- DOOR AND/OR ITS SCREEN. IF PRESENT, ARE OPENED AND BE CAPABLE OF BEING HEARD THROUGHOUT THE HOUSE DURING NORMAL HOUSEHOLD ACTIVITIES. THE ALARM SHALL AUTOMATICALLY RESET UNDER ALL CONDITIONS. THE ALARM SYSTEM SHALL BE EQUIPPED WITH A MANUAL MEANS, SUCH AS TOUCH PAD OR SWITCH, TO TEMPORARILY DEACTIVATE THE ALARM FOR A SINGLE OPENING. DEACTIVATION SHALL LAST FOR NOT MORE THAN 15 SECONDS. THE DEACTIVATION SWITCH(ES) SHALL BE LOCATED AT LEAST 54 INCHES (1372 MM) ABOVE THE THRESHOLD OF THE DOOR; OR 8.3. OTHER MEANS OF PROTECTION. SUCH AS SELF-CLOSING DOORS WITH SELF-LATCHING DEVICES, WHICH
- ARE APPROVED BY THE GOVERNING BODY, SHALL BE ACCEPTABLE SO LONG AS THE DEGREE OF PROTECTION AFFORDED IS NOT LESS THAN THE PROTECTION AFFORDED BY ITEM 8.1 OR 8.2 DESCRIBED ABOVE. SELF-CLOSING AND SELF LATCHING DEVICES SHALL BE INSTALLED ON ALL DOORS WITH DIRECT ACCESS TO THE POOL AREA, WITH THE RELEASE MECHANISM LOCATED A MINIMUM OF FIFTY-FOUR INCHES ABOVE THE FLOOR.
- WHERE AN ABOVE-GROUND POOL STRUCTURE IS USED AS A BARRIER OR WHERE THE BARRIER IS MOUNTED ON TOP OF THE POOL STRUCTURE, AND THE MEANS OF ACCESS IS A LADDER OR STEPS: 9.1. THE LADDER OR STEPS SHALL BE CAPABLE OF BEING SECURED, LOCKED OR REMOVED TO PREVENT ACCESS: OR 9.2. THE LADDER OR STEPS SHALL BE SURROUNDED BY A BARRIER WHICH MEETS THE REQUIREMENTS OF
- THIS SECTION, ITEMS 1 THROUGH 9. WHEN THE LADDER OR STEPS ARE SECURED, LOCKED OR REMOVED, ANY OPENING CREATED SHALL NOT ALLOW THE PASSAGE OF A 4 INCH DIAMETER (102 MM) SPHERE 10. PET DOORS WHICH PROVIDE DIRECT ACCESS TO THE POOL AREA ARE PROHIBITED UNLESS THEY MEET THE REQUIREMENTS OF ITEM 2 OR ARE EQUIPPED WITH AN ALARM THAT MEETS ITEM 8.2. WINDOWS WITH ACCESS TO THE POOL AREAS WILL BE PROTECTED IN THE FOLLOWING WAYS: 11.1 EMERGENCY ESCAPE OR RESCUE WINDOWS FROM SI FEPING AREAS WITH ACCESS TO THE SWIMMING POOL
- WILL BE EQUIPPED WITH A LATCHING DEVICE NOT LESS THAN 54 INCHES (1372 MM) ABOVE THE FLOOR. 11.2 ALL OTHER OPENABLE WINDOWS WITH SIMILAR ACCESS WILL ALSO BE EQUIPPED WITH A LATCHING DEVICE NOT LESS THAN 54 INCHES (1372 MM) ABOVE THE FLOOR OR SHALL BE EQUIPPED WITH KEY LOCK DEVICE THAT PREVENTS OPENING THE WINDOW MORE THAN 4 INCHES (102 MM).
- WALLS SURROUNDING AN INDOOR SWIMMING POOL SHALL COMPLY WITH ITEM 8.
- BARRIERS SHALL BE LOCATED TO PROHIBIT PERMANENT STRUCTURES. EQUIPMENT OR SIMILAR OBJECTS FROM BEING USED TO CLIMB THEM

SPAS OR HOT TUBS WITH A SAFETY COVER WHICH COMPLIES WITH ASTM F 1346 SHALL BE EXEMPT FROM THE PROVISIONS OF THIS SECTION

FIRE SPRINKLERS

- 02. A WATER METER W/ DOMESTIC LINE AS REQUIRED FOR C.O.S. I'S & A'S, SECT 8.1.1.3 RESIDENTIAL FIRE SPRINKLER SYSTEM.
- 03. A SEPARATE PERMIT IS REQUIRED FROM THE FIRE DEPT. FOR FIRE SPRINKLER SYSTEM.
- 04. MEET PROVISIONS OF 2015 IFC AMMENDMENTS ORD. 4045 AND SRC 36-18 AUTOMATIC FIRE SPRINKLER SYSTEM -SEC. 903.

01. PROVIDE REMOVABLE PANEL OF SUFFICIENT SIZE TO ACCESS PUMP 02. CIRCULATION PUMP SHALL BE LOCATED ABOVE THE CROWN WEIR OF THE TRAP. 03. PUMP AND CIRCULATION PIPING SHALL BE SELF-DRAINING. 04. SUCTION FITTINGS SHALL COMPLY WITH THE LISTED STANDARDS. 05. PROVIDE G.F.I. CIRCUIT (N.E.C. ARTICLE 680-70)

AG104 SPAS AND HOT TUBS

FOR A NONSELF-CONTAINED AND SELF-CONTAINED SPA OR HOT TUB, PROTECTION SHALL COMPLY WITH THE **REQUIREMENTS OF SECTION 103.1** EXCEPTION: A SELF-CONTAINED SPA OR HOT TUB EQUIPPED WITH A LISTED SAFETY COVER SHALL BE EXEMPT FROM THE REQUIREMENTS OF SECTION 103.1.

REQUIRED RESIDENTIAL NOTES

- 1. ALL PRODUCTS LISTED BY I.C.C./N.E.R. NUMBER(S) SHALL BE INSTALLED PER THE REPORT AND MANUFACTURER'S EVALUATION REPORT(S) OR BE APPROVED.
- 02. EXTERIOR WALL, BOTTOM SILL PLATES, SHALL BE PRESSURE TREATED OR EQUAL, AND SHALL BEAR/EXTEND MINIMUM 6" ABOVE FINISH GRADE, (2015 IRC SEC, R317.1) 03. MISCELLANEOUS SITE STRUCTURES, POOLS, SPAS, FENCES, SITE WALLS, RETAINING WALLS, AND GAS STORAGE TANKS
- REQUIRE SEPARATE PERMITS 04. ALL EXITS TO BE OPERABLE FROM THE INSIDE WITHOUT THE USE OF A KEY OR SPECIAL KNOWLEDGE.
- 05. DOORS LEADING INTO HOUSE FROM GARAGE SHALL BE SELF-CLOSING, SELF-LATCHING (2015 IRC R302.5.1)
- 06. EXTERIOR WALL PENETRATIONS BY PIPES, DUCTS OR CONDUITS SHALL BE CAULKED. (2015 IRC R302.4.1)
- SUPPLY AND RETURN AIR DUCT INSULATION VALUE OF R-8(MIN.) 09. LUMBER SHALL BEAR AN APPROVED GRADING STAMP. (R502.1
- OF PARADISE VALLEY
- 1. FIRE BLOCKING SHALL COMPLY WITH (2015 IRC R302.11) THE WINDOW TO BE MINIMUM 24 INCHES ABOVE THE FLOOR IN WHICH IT SERVES (R613.2)
- MEMBERS 24" O.C. OR USE LABELED 1/2" SAG-RESISTANT GYPSUM CEILING BOARD. TABLE R702.3.5 (d)
- 4. SHOWERS AND TUB-SHOWER COMBINATIONS SHALL BE PROVIDED WITH INDIVIDUAL CONTROL VALVES OF THE PRESSURE BALANCE OR THERMOSTATIC MIXING VALVE TYPE (P2708.3)
- VALL TILE IN TUB AND SHOWER AREAS AND WALL PANELS IN SHOWER AREAS (B702.3.4)
- CLOSETS- TANK TYPE 1.6 GAL/FLUSH, SHOWER HEAD 2.5 GAL/MINUTE, FAUCETS 2.2 GAL/MINUTE PROVIDE AFRATOR
- WHEN NOT IN USE.
- POSSIBLE (P2717.3)
- SENSOR SWITCH SHALL OPERATE THE PUMP WITH AN AUTOMATIC TEMPERATURE SENSOR SHUT-OFF (M2005.5 AMENDED)
- TO A MINIMUM R-6 (N1103.2.1)
- EXCEED A TOTAL LENGTH OF 35 FEET, UNLESS AN ENGINEERED DUCT SYSTEM IS PROVIDED (M1501.3)
- 23. EXHAUST AIR FROM KITCHENS, BATHROOMS AND TOILET ROOMS SHALL NOT BE RE-CIRCULATED WITHIN A RESIDENCE INSIDE THE BUILDING, M1506.2
- 24. PROVIDE IC-RATED RECESSED LIGHT FIXTURES INSTALLED IN INSULATED CEILINGS (N1102.4.3)
- 27. PROVIDE GFCI PROTECTED RECEPTACLES AT AL EXTERIOR, BATHROOM AND GARAGE LOCATIONS. (E3802.1, .2)
- LAVATORY (E3801.6)
- 29. ALL 120-VOLT BRANCH CIRCUITS IN FAMILY ROOMS, DINING ROOMS, LIVING ROOMS, PARLORS, LIBRARIES, DENS, PROTECTED BY A COMBINATION TYPE AFCI (E3802.11)
- MORE IN WIDTH (E3502.2
- 31. PROVIDE A MINIMUM OF TWO 20-AMP SMALL APPLIANCE BRANCH CIRCUITS FOR THE KITCHEN/DINING/BREAKFAST. (E3603.3)
- RECEPTACLE INSTALLED SOLELY FOR ELECTRIC SUPPLY TO AN ELECTRICAL CLOCK IN THE RANGES, OVENS OR COUNTER MOUNTED UNITS. (E3603.2)
- 33. RECEPTACLE OUTLETS FOR RANGES AND CLOTHES DRYERS SHALL BE 3-POLE WITH GROUND TYPE. FOUR-WIRE, GROUNDING -TYPE FLEXIBLE CORDS WILL BE REQUIRED FOR CONNECTION OF RANGES AND CLOTHES DRYERS. THE GROUNDING-TYPE ATTACHMENT PLUG. (E4001.3)
- AMPERE SERVICE) (E3508.1, .2)
- 35. PROVIDE BONDING TO THE WATER PIPING, GAS AND METAL BUILDING SYSTEMS. (MINIMUM #4 FOR 200-AMP SERVICE
- CARRYING METAL PARTS SHALL NOT BE BONDED (E4104.2, .4)
- JOINT THICKNESS SHALL BE WITHIN THE FOLLOWING TOLERANCES FROM THE SPECIFIED DIMENSIONS: 1. BED JOINT + 1/8 INCH 2. HEAD JOINT: 1/4 INCH + 3/8 INCH 3. COLLAR JOINTS: 1/4 INCH +3/8 INCH
- HIGHER THAN THE FIREBOX. (R1006.1)

01. PROVIDE AUTOMATIC RESIDENTIAL FIRE SPRINKLER SYSTEM PER NFPA 13D. (UNDER SEPERATE PERMIT



WRITTEN INSTRUCTIONS. PRODUCTS SUBSTITUTIONS FOR PRODUCT(S) LISTED SHALL ALSO HAVE AN ICC APPROVED

PROVIDE ROOF ATTIC VENTILATION UNLESS INSULATION IS APPLIED DIRECTLY TO UNDERSIDE OF ROOF SHEATHING. 08. ENERGY CONSERVATION REQUIREMENTS: CEILING/ATTIC R-VALUE = R-38 (MIN.), FRAME WALL R-VALUE =R-19 (MIN.), MASONRY WALL R-VALUE = R-4 (MIN.), WINDOW U-VALUE = 0.40 (MAX.), SOLAR HEAT GAIN COEFFICIENT = 0.25 (MAX.),

10. PROVIDE ENGINEERED TRUSS DESIGNS FOR ALL PREFABRICATED TRUSSES FOR REVIEW AND APPROVAL BY THE TOWN

12. WINDOWS LOCATED MORE THAN 72" ABOVE FINISHED GRADE SHALL HAVE THE LOWEST PART OF CLEAR OPENING OF

PSUM BOARD APPLIED TO A CEILING SHALL BE 1/2" WHEN FRAMING MEMBERS ARE 16" O.C. OR 5/8" WHEN FRAMING

15. SHOWER AREA WALLS SHALL BE FINISHED WITH A SMOOTH, HARD NON-ABSORBENT SURFACE, SUCH AS CERAMIC TILE, TO A HEIGHT OF NOT LESS THAN 72 INCHES ABOVE THE DRAIN INLET. WATER-RESISTANT GYPSUM BOARD SHALL NOT BE INSTALLED OVER A VAPOR RETARDER IN A SHOWER OR TUB COMPARTMENT. CEMENT, FIBER-CEMENT OR GLASS. MAT GYPSUM BACKERS INSTALLED WITH MANUFACTURER'S RECOMMENDATIONS SHALL BE USED AS BACKERS FOR

16. PLUMBING FIXTURES SHALL COMPLY WITH THE FOLLOWING CONSERVATION REQUIREMENTS: TABLE P2903.2 WATER

17. WATER TREATMENT SYSTEMS - SHALL BE EQUIPPED WITH AND AUTOMATIC SHUTOFF TO PREVENT CONTINUOUS FLOW

18. DOMESTIC DISH WASHING MACHINES CONNECTED TO A DISPOSER SHALL HAVE THE DISCHARGE INSTALLED AS HIGH AS

19. HOT WATER RECIRCULATION PUMPS. PROVIDE A HOT WATER DEMAND CONTROLLED RECIRCULATION PUMP FOR WATER HEATERS LOCATED MORE THAN 20 FEET FROM FURTHEST FIXTURE SERVED. A MANUAL CONTROL OR OCCUPANT

20. SUPPLY AND RETURN DUCTS SHALL BE INSULATED TO A MINIMUM R-8. DUCTS IN FLOOR TRUSSES SHALL BE INSULATED

21. REGISTERS, DIFFUSERS AND GRILLES SHALL BE MECHANICALLY FASTENED TO RIGID SUPPORTS OR STRUCTURAL MEMBERS ON AT LEAST TWO OPPOSITE SIDES IN ADDITION TO BEING CONNECTED TO THE DUCTWORK THEY SERVE

22. THE CLOTHES DRYER SHALL BE PROVIDED WITH A 4-INCH DIAMETER EXHAUST DUCT TO THE EXTERIOR AND SHALL NOT

OR TO ANOTHER DWELLING UNIT AND SHALL BE EXHAUSTED DIRECTLY TO THE OUTDOORS. EXHAUST AIR FROM KITCHENS, BATHROOMS AND TOILET ROOMS SHALL NOT DISCHARGE INTO AN ATTIC, CRAWL SPACE OR OTHER AREAS

25. FIXTURES LOCATED IN DAMP OR WET LOCATIONS SHALL BE "LISTED" TO BE SUITABLE FOR SUCH LOCATION. (E3903.8) 26. PROVIDE GECI PROTECTION FOR RECEPTACLES WITHIN 6' OF ALL LAVATORIES. SINKS AND BASINS. (E3802.7

28. PROVIDE A WALL MOUNTED GFCI PROTECTED RECEPTACLE OUTLET WITHIN 36" OF A BATHROOM OR POWDER ROOM

BEDROOMS, SUN ROOMS, RECREATION ROOMS, CLOSETS, HALLWAYS AND SIMILAR ROOMS OR AREAS SHALL BE

30. RECEPTACLE OUTLETS SHALL BE INSTALLED SO THAT NO POINT ALONG THE FLOOR LINE IN ANY WALL SPACE IS MORE THAN 6 FEET, MEASURED HORIZONTALLY, FROM AN OUTLET IN THAT SPACE, INCLUDING ANY WALL SPACE 2 FEET OR

32. THE TWO OR MORE 20-AMPERE SMALL APPLIANCE BRANCH CIRCUITS SHALL HAVE NO OTHER OUTLETS, EXCEPT THE KITCHEN/DINING/BREAKFAST AREAS OR RECEPTACLES FOR SUPPLEMENTAL EQUIPMENT AND LIGHTING FOR GAS-FIRED


BONDING JUMPER SHALL NOT BE CONNECTED BETWEEN THE NEUTRAL TERMINAL AND THE FRAME OF THE APPLIANCE. FLEXIBLE CORDS SHALL BE USED ONLY WHERE THE FLEXIBLE CORD SUPPLYING AN APPLIANCE SHALL TERMINATE IN A

34. PROVIDE A CONCRETE ENCASED GROUNDING ELECTRODE OF NOT LESS THAN 20 FEET OF #4 BARE COPPER (200

36. ALL METAL PIPING SYSTEMS, METAL PARTS OF ELECTRICAL EQUIPMENT, AND PUMP MOTORS ASSOCIATED WITH THE HYDRO MASSAGE TUB SHALL BE BONDED TOGETHER USING A COPPER BONDING JUMPER, INSULATED, COVERED, OR BARE, NOT SMALLER THAN NO. 8 SOLID. METAL PARTS OF LISTED EQUIPMENT INCORPORATING AN APPROVED SYSTEM OF DOUBLE INSULATION AND PROVIDING A MEANS FOR GROUNDING INTERNAL NON-ACCESSIBLE, NON-CURRENT-

37. R607.2.1 MASONRY BED AND HEAD JOINTS...SHALL BE 3/8" THICK. THE THICKNESS OF THE BED JOINT OF THE STARTING COURSE PLACED OVER FOUNDATIONS SHALL NOT BE LESS THAN 1/4" INCH AND NOT MORE THAN 3/4 INCH. MORTAR

PERSPECTIVE VIEW

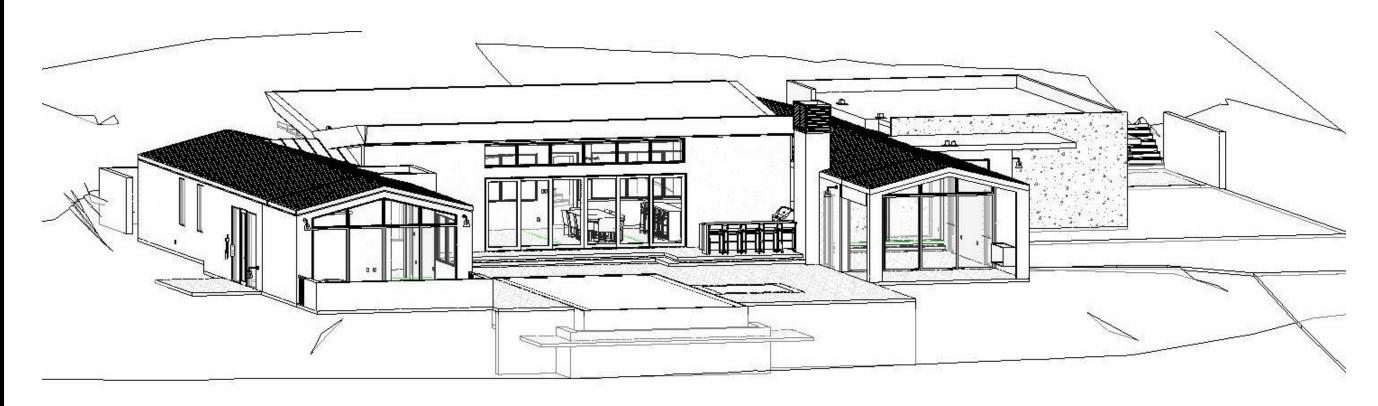


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01.	FOLLOWING	G CODES AND	DATA - ALL CONSTI AMMENDMENTS P BUILDING CODE RESIDENTIAL COL	ER THEIR AL				LL COMPLY WITH ⁻	THE	_	EXIST NEW L
	2015 IN 2015 IN 2015 IN	TERNATIONAL TERNATIONAL	FIRE CODE PLUMBING CODE MECHANICAL COE								ΤΟΤΑΙ
02.	2015 IN 2015 IN 2015 IN	TERNATIONAL TERNATIONAL TERNATIONAL	PROPERTY MAINT ENERGY CONSER FUEL GAS CODE	VATION COE	DE					_	EXIST
RC	OOF SNOW	WIND	SEISMIC DESIGN CATEGORY ^{f,g}	1	. ,			WINTER DESIGN TEMP. ^f	FLOOD HAZARDS ^h		TOTAI
		SPEED [®] (MPH)		WEATHERING ^a	FROST LINE DEPTH ^b	TERMITE℃	DECAYd				
0		115 EXPOSURE B	В	NEGLIGABLE	12" BELOW FINAL GRADE	MODERATE TO HEAVY	NONE TO SLIGHT	34 DEGREES	NFIP 040049		EXIST NEW (
	THE SAME	NATURE AS OT	SCALED. ALL DIME THER SIMILAR CON	NDITIONS. VE	ERIFY ALL D	IMENSION	IS PRIO	R TO STARTING W	ORK.		ΤΟΤΑΙ
	CLARIFICAT	ION OR REVIS	L NOTIFY BOWMAN NONS PRIOR TO CO	OMMENCING	WITH WOF		PANCIE	S ON DRAWINGS.	REQUIRING		TOTAL
	ANY ENGIN	EERING DESIG	IEER REGISTERED	THERS AND	SUBMITTE	D FOR RE	VIEW, S	HALL BEAR THE SE	EAL AND		OVER
07.			N (AS BUILT) SHALL NON WHERE REQU		IED BY THE	CITY FOR	THE FE	DERAL EMERGEN	CY		
08.	NECESSAR	Y IF THEY CHO	ONTRACTORS CON DOSE AN OPTION A FATED BY SELECTI	ND SHALL C	OORDINAT	E ALL DET	AILS. TH	HE COST OF ADDIT	IONAL		NET L
09.		OF ADDITIONA NTRACTOR.	L DESIGN WORK D	OUE TO ERRO	DRS OR OM	ISSIONS II	N CONS	TRUCTION SHALL	BE INCURRED		PROP TOTAL
10.	DRAWINGS PRIOR TO M WITHOUT A	. NO STRUCTU //AKING CHANC /PROVAL, SUC OR OR SUBCC	URAL DRAWINGS A IRAL CHANGES FR GES, WRITTEN APF CH CHANGES SHAI INTRACTOR INVOL	OM THE APP PROVAL IS O LL BE THE LI	PROVED PL/ BTAINED FI EGAL AND F	ANS SHAL ROM THE FINANCIAL	L BE MA ENGINE RESPO	DE IN THE FIELD, I ER. IF CHANGES A INSIBILITY OF THE	UNLESS RE MADE		

SCOPE OF WORK

SCOPE OF WORK THIS PROJECT IS AN EXISTING SINGLE STORY 4 BEDROOM PLUS STUDY, 2 AND A HALF BATHROOM, 2 CAR GARAGE RESIDENTIAL BUILDING THAT IS TO BE REMODELED WITH AN ADDITION TO BE A 3 BEDROOM PLUS STUDY, 3 BATHROOM, 4 CAR GARAGE RESIDENTIAL BUILDING.

VICINITY MAP

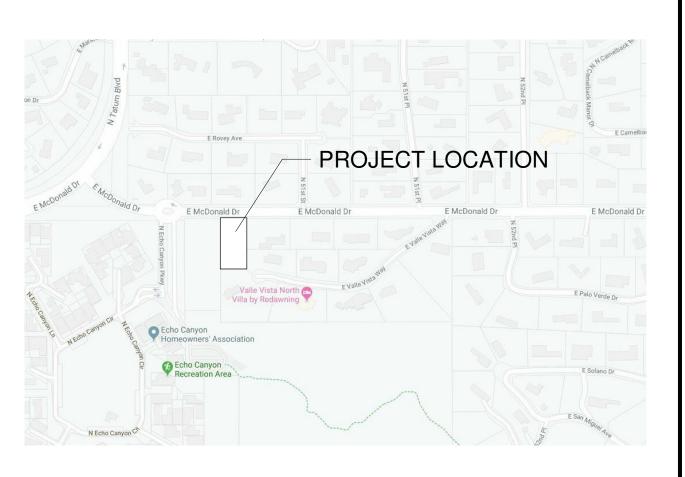

SHEET INDEX A0.1 COVER SHEET A1.0 DEMO PLAN GD100 GRADING AND DRAINAGE PLAN L1 LANDSCAPE PLAN L2 LANDSCAPE PLAN A0.2 LAND SURVEY A0.3 PROPERTY PHOTOS A0.4 PROPERTY RENDERINGS A0.5 SITE CROSS SECTIONS A0.6 MATERIAL BOARD A1.1 ARCH. SITE PLAN A1.1a ARCH. SITE PLAN A1.1b ARCH. SITE PLAN A1.1c LIGHTING PLAN A1.2 OPEN SPACE DIAGRAM A1.3 OPEN SPACE SECTIONS A2.1 FLOOR PLAN A3.1 REFLECTED CEILING PLAN A4.1 ROOF PLAN A5.1 BUILDING SECTIONS A6.1 EXTERIOR ELEVATIONS A8.1 DOOR & WINDOW SCHEDULE A9.1 DOOR & WINDOW DETAILS E2.1 ELECTRIC PLAN

SQUARE FOOTAGES

TING LIVABLE:	3,032 SF
LIVABLE:	637 SF
L LIVABLE:	3,669 SF
TING GARAGE/MECH: GARAGE:	553 SF 509 SF
L GARAGE/MECHANICAL:	1,062 SF
TING COVERED PATIOS (FRONT/BACK) COVERED PATIOS:): 272 SF 576 SF
L COVERED PATIOS:	848 SF
L UNCOVERED PATIO:	280 SF
RHANGS:	260 SF
LOT AREA: 1.01 ACRES = WABLE F.A.R. (25%) POSED LOT COVERAGE: LL FLOOR AREA RATIO:	43,573 SF 10,893 SF 6,119 SF 14.0%

BOWMAN DESIGN GROUP

ARCHITECTURE | PLANNING | DESIGN

<u>OWNER</u>

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APN:

SITE AREA:

R-43

172-04-009

43,573 (1.01 AC.)

LEGAL ADDRESS: 5001 E MCDONALD DR. PARADISE VALLEY, AZ 85253

REV #

DATE

CAMELBACK ESTATE


COVER SHEET

Project number Date Drawn by Checked by

Scale

19-12 4/08/2020 DJB DJB A0.1


12" = 1'-0"

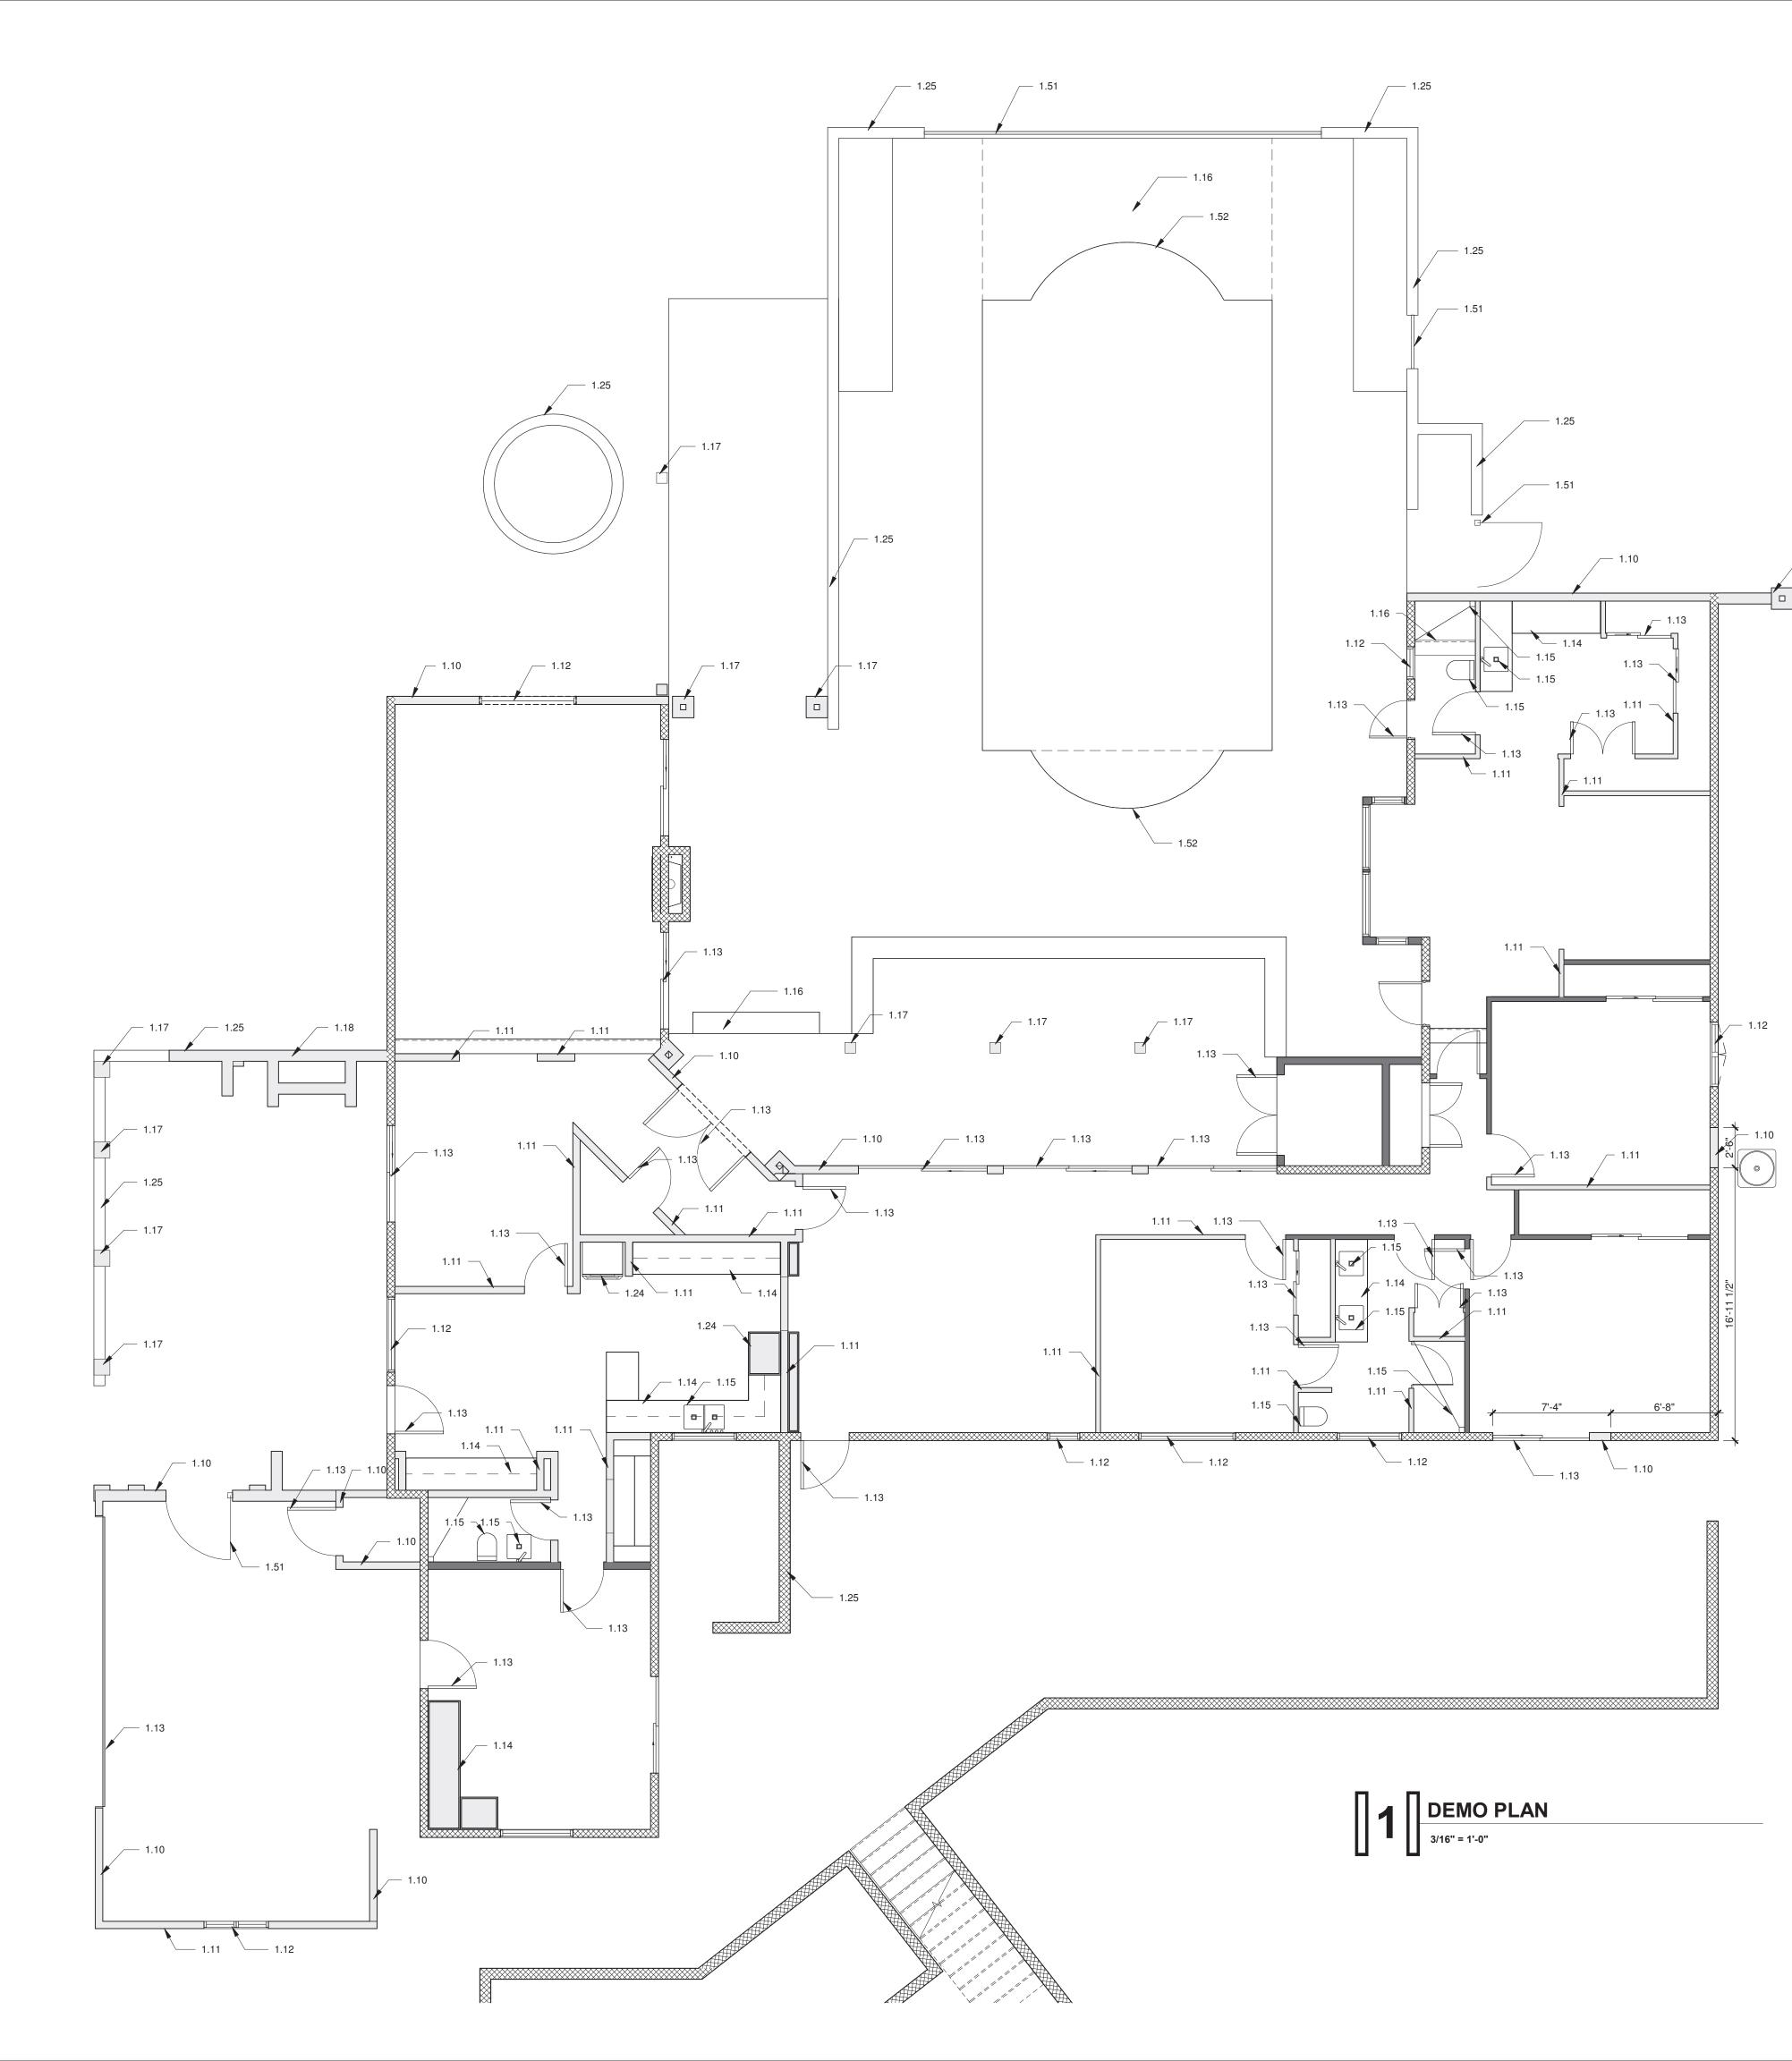

ARCHITECTURE | PLANNING | DESIGN

_____ 1.25

	KEYNOTES
	1.10 DEMO EXISTING EXTERIOR WALL - BRACE/SHORE AS REQUIRED - LOWER STEM AS REQUIRED 1.11 DEMO EXISTING INTERIOR WALL 1.12 DEMO EXISTING WINDOW 1.13 DEMO EXISTING DOOR, FRAME, AND ASSOCIATED HARDWARE 1.14 DEMO EXISTING MILLWORK/ SHELVING 1.15 DEMO EXISTING FIXTURE - CAP ALL DRAINS AS REQUIRED 1.16 DEMO EXISTING CONCRETE AS INDICATED 1.17 DEMO EXISTING POST/ COLUMN-VERIFY WITH STRUCTURAL 1.18 DEMO EXISTING FIREPLACE 1.24 DEMO EXISTING APPLIANCE 1.25 DEMO EXISTING LOW WALL, SITE WALL, PLYNTH, STOOP 1.51 DEMO EXISTING EXTERIOR GATE OR BAILING
	1.51 DEMO EXISTING EXTERIOR GATE OR RAILING 1.52 PARTIAL DEMO OF EXISTING POOL, COORDINATE WITH NEW DESIGN
	AUGISTERED ARCHITECO AUGISTERED ARCHITECO GADTS GADTS GADTS GADTS GADTS C C C C C C C C C C C C C
	FOR: SCHEMATIC DESIGN REV # DATE
	CAMELBACK ESTATE
	DEMO PLAN
	Project number 19-12 Date 01/09/2020 Drawn by DJE Checked by DJE
	A1.0 Scale As indicated
1	

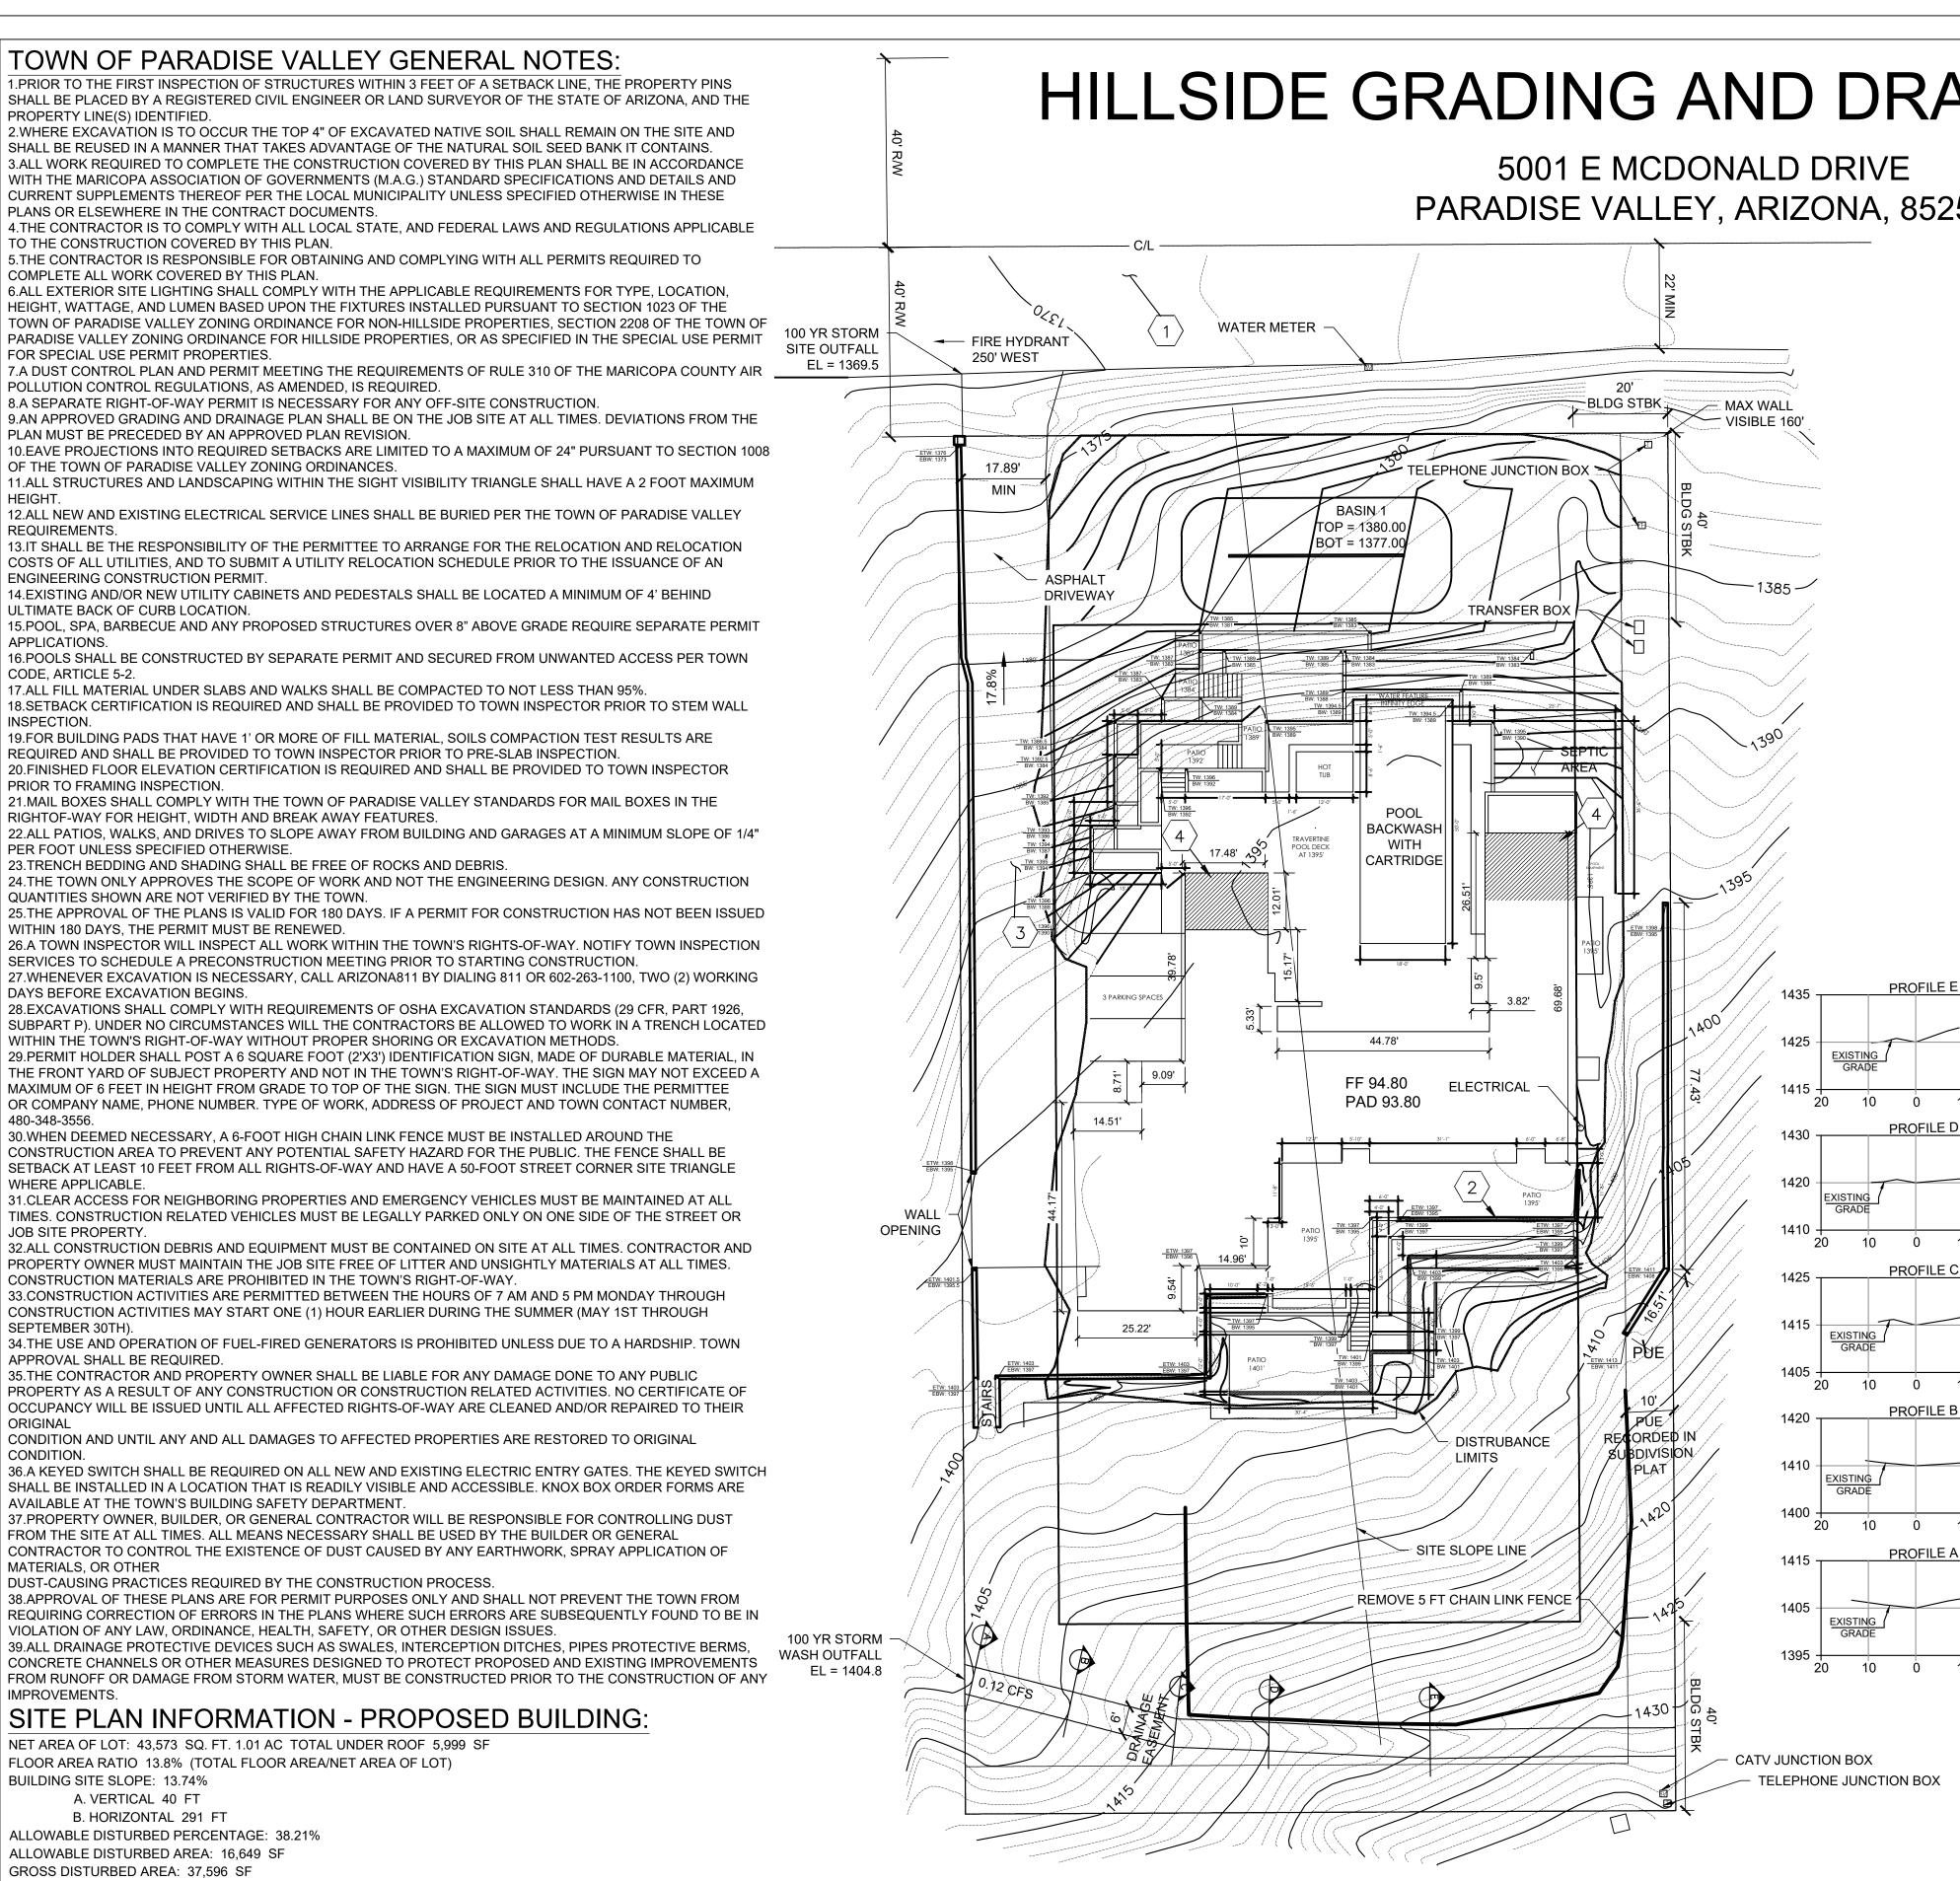

TOTAL LIVABLE FOOTPRINT: 3,669 SF - CREDIT AREA: 3,669 SF

ATTACHED GARAGE FOOTPRINT: 1,062 SF - CREDIT AREA: 1,062 SF

DRIVEWAY CREDIT @ 100%: 2,444 SF, NO NEW ASPHALT AREAS - CREDIT AREA: 2,444 SF RETENTION BASIN CREDIT @ 50%: 1,336 SF - CREDIT AREA: 668 SF

RESTORED AREAS: 8,756 SF - CREDIT AREA: 8,756 SF ASPHALT DRIVEWAY @ 150%: 1,814 SF - CREDIT AREA: (2,721 SF)

NET PROPOSED DISTURBED AREA: 23,718 SF (54.4%)

PERCENT OF LOT STEEPER THAN NATURAL GRADE (5% MAX) 3% VOLUME OF CUT 75 C.Y. VOLUME OF FILL 75 C.Y. HILLSIDE ASSURANCE @ \$35/CUBIC YARD OF CUT + FILL \$6,633

DRIVEWAY: AREA: 1.814 SF ASPHALT: 2.444 SF PAVERS MATERIAL: ASPHALT & PAVERS

HILLSIDE GRADING AND DRAINAGE PLAN

PARADISE VALLEY, ARIZONA, 85253



REVISED: **REVISED**:

REVISED

BY MY DATED SIGNATURE BELOW, I REAFFIRM MY DECLARATION ON THE FIRST SHEET (COVER SHEET) OF THESE AS BUILT DRAWINGS, AS RELATES SPECIFICALLY TO THE CONTENTS OF THIS SHEET. MY RESPONSIBILITY FOR THE ACCURACY OF THE INFORMATION HEREON IS LIMITED AS SET FORTH IN THOSE DECLARATIONS.

SIGNATURE AND DATE:

OWNER JOHN MITCHELL 5001 E MCDONALD DRIVE

PARADISE VALLEY, AZ 85253 480.760.5727 IUMITCHELL02@YAHOO.COM CONTACT: JOHN MITCHELL

CIVIL ENGINEER:

WERK URBAN DESIGN 51 W 3RD ST, SUITE 450 TEMPE, AZ 85281 480.200.7187 NEIL@WERKURBANDESIGN.COM CONTACT: NEIL HUCKLA

ADDRESS: 5001 E MCDONALD DR APN 172-04-009 ZONING R-43 AREA 43,573 SF (1.00 ACRES) CONSTRUCTION YEAR: 1963

CUT 75 CY 75 CY FILL NET 0 CY FILL

67 OF MAPS, PAGE 15.

FRONT REAR SIDE

10

10

10

10

10

BASIS OF BEARING: THE MONUMENT LINE OF MCDONALD DRIVE, USING A BEARING OF SOUTH 89 DEGREES 43 MINUTES 30 SECONDS WEST, PER THE PLAT OF MIRADOR, RECORDED IN BOOK 67, PAGE 15, M.C.R.

RANGE 4E.

SURVEY: ON 07-18-19

PRE V POST V=C*(P/12)*A

FIRST FLUSH Vff = (P/12)*A Vff = (0.5/12)*43,573 = 1,816 CUBIC FT

RETENTION PROVIDED: Vp = (1,336+15)/2*3 = 2,026 CUBIC FT

WASH FLOW VOLUME: Q=ciA=0.5*2.21*4,566 SF = 0.12 CFS

ENGINEER'S CERTIFICATION:

THE FINISHED FLOOR ELEVATIONS OF 1394.80 ON THIS PLAN ARE CERTIFIED TO BE 12" ABOVE THE 100-YEAR STORM OUTFALL ELEVATION OF 1369.50, ACCORDING TO SECTION 1024, PARAGRAPH V OF THE TOWN OF PARADISE VALLEY ZONING ORDINANCE.



57431 REGISTRATION

TO BE FOUND IN VIOLATION OF LAWS AND ORDINANCES.

1						
	FLOOD INSUF	RANCE RAT	E MAP (F	IRM) INF	ORMATION	PARADISE VALLEY TOWN ENGINEER
	COMMUNITY	PANEL	DATED	ZÓNE		
	NUMBER	NUMBER				
	040049	17651	10-16-13	V		
	040049	1765L	10-10-13	Х		DATE:
	THIS SET OF F	PLANS HAS	BEEN R	EVIEWED	FOR COMPLIANCE W	ITH TOWN OF PARADISE VALLEY
	REQUIREMEN	TS PRIOR	TO ISSUA	NCE OF	PERMIT. THE TOWN N	IEITHER ACCEPTS NOR ASSUMES
	ANY LIABILITY	FOR ERR	ORS OR (OMISSIO	NS. THIS COMPLIANCE	E APPROVAL SHALL NOT PREVENT
	THE TOWN EN	IGINEER F	ROM REC	UIRING	CORRECTIONS OF ERI	RORS OR OMISSIONS IN THE PLANS

PARCEL DATA:

CUT/FILL QUANTITIES:

NOTE: FOR ESTIMATING PURPOSES ONLY; ENGINEER MAKES NO WARRANTY OF ACCURACY. IT IS THE CONTRACTOR'S RESPONSIBILITY TO DETERMINE EXACT QUANTITIES BASED ON THE PLANS. QUANTITIES DO NOT INCLUDE ANY TOPSOIL REMOVAL ANY SHRINKAGE OR EXPANSION/SWELLING OF THE SOIL; OR WETHER SOIL CAN BE REUSED ON-SITE. ASSUMED 4" CONCRETE SLAB AND 4" ABC ARE NOT INCLUDED IN VOLUME QUANTITIES.

LEGAL DESCRIPTION:

LOT 6, OF MIRADOR, ACCORDING TO THE PLAT RECORD IN THE OFFICE OF THE COUNTY RECORDER OF MARICOPA COUNTY, ARIZONA, RECORDED IN BOOK

BUILDING SETBACKS:

40 FT 40 FT 20 FT

BENCHMARK:

BRASS CAP IN HANDHOLE FOUND AT THE NORTHWEST CORNER OF SECTION 17, TOWNSHIP 2N,

ELEVATION = 1337.90 (NAV 88 DATUM)


FIELD SURVEY CONDUCTED BY KDM SURVEYING, LLC

DRAINAGE CALCULATIONS:

Vpre = 0.95*(2.21/12)*13,920+0.85*(2.21/12)*29,653 = 7,077 CUBIC FT Vpost = 0.95*(2.21/12)*16,420+0.85*(2.21/12)*27,153 = 7,123 CUBIC FT

2			
ENG	iIN	١E	E

6-4-2020

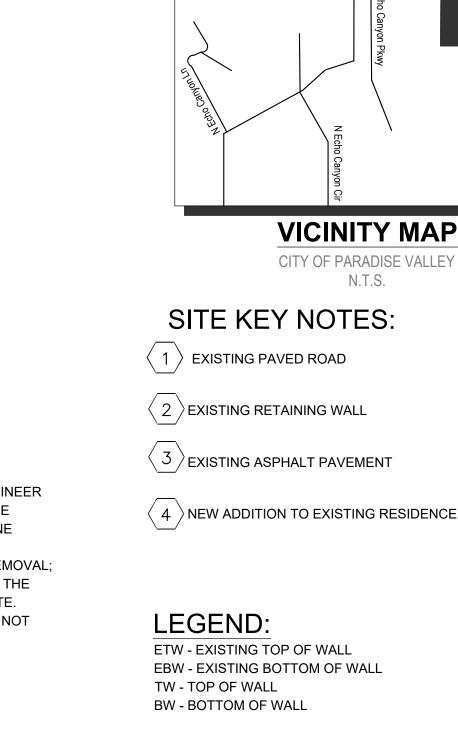

 $\mathbf{1}$

E Rovey Ave

E McDonald Dr

PROJEC[®]

UTILITY PROVIDERS:

1.WATER - EPCOR 2.SANITARY SEWER - SEPTIC **3.ELECTRIC - APS** 4. TELEPHONE - COX COMMUNICATIONS **5.NATURAL GAS - SOUTHWEST GAS** 6.CABLE TV - COX COMMUNICATIONS

DRAINAGE STATEMENT

1. ULTIMATE STORM WATER OUTFALL LOCATIONS AND ELEVATIONS SHOWN ON DRAWING 2.PROPOSED DEVELOPMENT DOES NOT IMPACT DRAINAGE CONDITIONS OF ADJOINING LOTS 3.RETENTION IS PROVIDED FOR THE 100-YEAR, 2-HOUR STORM EVENT PER THE STORM WATER DRAINAGE DESIGN MANUAL 4.THE LOWEST FINISH FLOOR ELEVATION OF 1394.80 IS SAFE FROM INUNDATION DURING A 100-YEAR PEAK RUN-OFF EVENT IF CONSTRUCTED IN ACCORDANCE WITH THE

HILLSIDE NOTES:

APPROVED PLANS.

1. NO CERTIFICATE OF OCCUPANCY SHALL BE ISSUED UNTIL ALL HILLSIDE STIPULATIONS AND ALL TOWN CODE REQUIREMENTS ARE COMPLIED INCLUDING, BUT NOT LIMITED TO LANDSCAPING, GROUND RESTORATION, FIRE FLOW, FIRE SAFETY AND ALL ONSITE AND OFFSITE IMPROVEMENTS.

2. ALL OUTDOOR LIGHTING SHALL BE IN CONFORMANCE WITH ARTICLE XXII OF THE TOWN ZONING ORDINANCE. 3. ALL EXCESS FILL MATERIAL SHALL BE REMOVED FROM THE SITE WITH NO NEW SPILL SLOPES.

4. THE USE OF HYDRAULIC RAM HAMMERS AND HEAVY EQUIPMENT USED TO CUT THROUGH ROCK, INCLUDING MACHINERY WITH AUDIBLE BACK UP WARNING DEVICES SHALL BE LIMITED TO USE BETWEEN THE HOURS OF 7:00 AM OR SUNRISE, WHICHEVER IS LATER, AND 6:00 PM OR SUNSET, WHICHEVER IS EARLIER, MONDAY THROUGH FRIDAY, WITH LIMITED WORK ON SATURDAY AND NO WORK ON SUNDAY OR LEGAL HOLIDAYS. 5. CONSTRUCTIONS STAKING AND/OR FENCING SHALL BE PLACED AROUND THE CONSTRUCTION SITE SO AS TO PROTECT THE UNDISTURBED NATURAL AREAS. 6.REQUIRE LIMITED AND EFFICIENT USE OF EXTERIOR LIGHTING TO MAINTAIN MINIMAL NIGHT-TIME LIGHTING

NATIVE PLANTS STATEMENT:

LEVELS AND PRESERVATION OF THE DARK SKY.

ALL NATIVE PLANTS IMPACTED BY CONSTRUCTION SHALL BE RELOCATED ON SITE.


NGIN	=ER	DATE	
			REVIEWED AND APPROVED:
NUM	BER		
<u> </u>	<u>IRM) INF</u>	ORMATION	PARADISE VALLEY TOWN ENGINEER
ED	ZONE		
6-13	V		
5-13	Х		DATE:
N RE	EVIEWED	FOR COMPLIANCE W	ITH TOWN OF PARADISE VALLEY
SUA	NCE OF	PERMIT. THE TOWN N	EITHER ACCEPTS NOR ASSUMES
OR C	MISSIO	NS. THIS COMPLIANCE	E APPROVAL SHALL NOT PREVENT


GD100

1 OF 1 SHEETS

nii at least two full w

	WERK Urban Design & Engineering WERK, LLC. 455 N 3rd Street, Suite 1010 Phoenix, AZ 85004 T. 602.429.9922 www.WERKurbandesign.com
	BY DATE APPR
	DESCRIPTION
ļ	Let
	HILLSIDE GRADING AND DRAINAGE PLAN
	5001 E MCDONALD DR PARADISE VALLEY, AZ 85253 PREPARED FOR BOWMAN DESIGN PARADISE VALLEY
	PROJECT No. 19020 SCALE (H): 1" = 20' SCALE (V): NONE DRAWN BY: HS DESIGN BY: NH CHECK BY NH DATE: 05/16/2020
	Sond OGOAN Sond Control ATE 10 Sond Control ATE 1

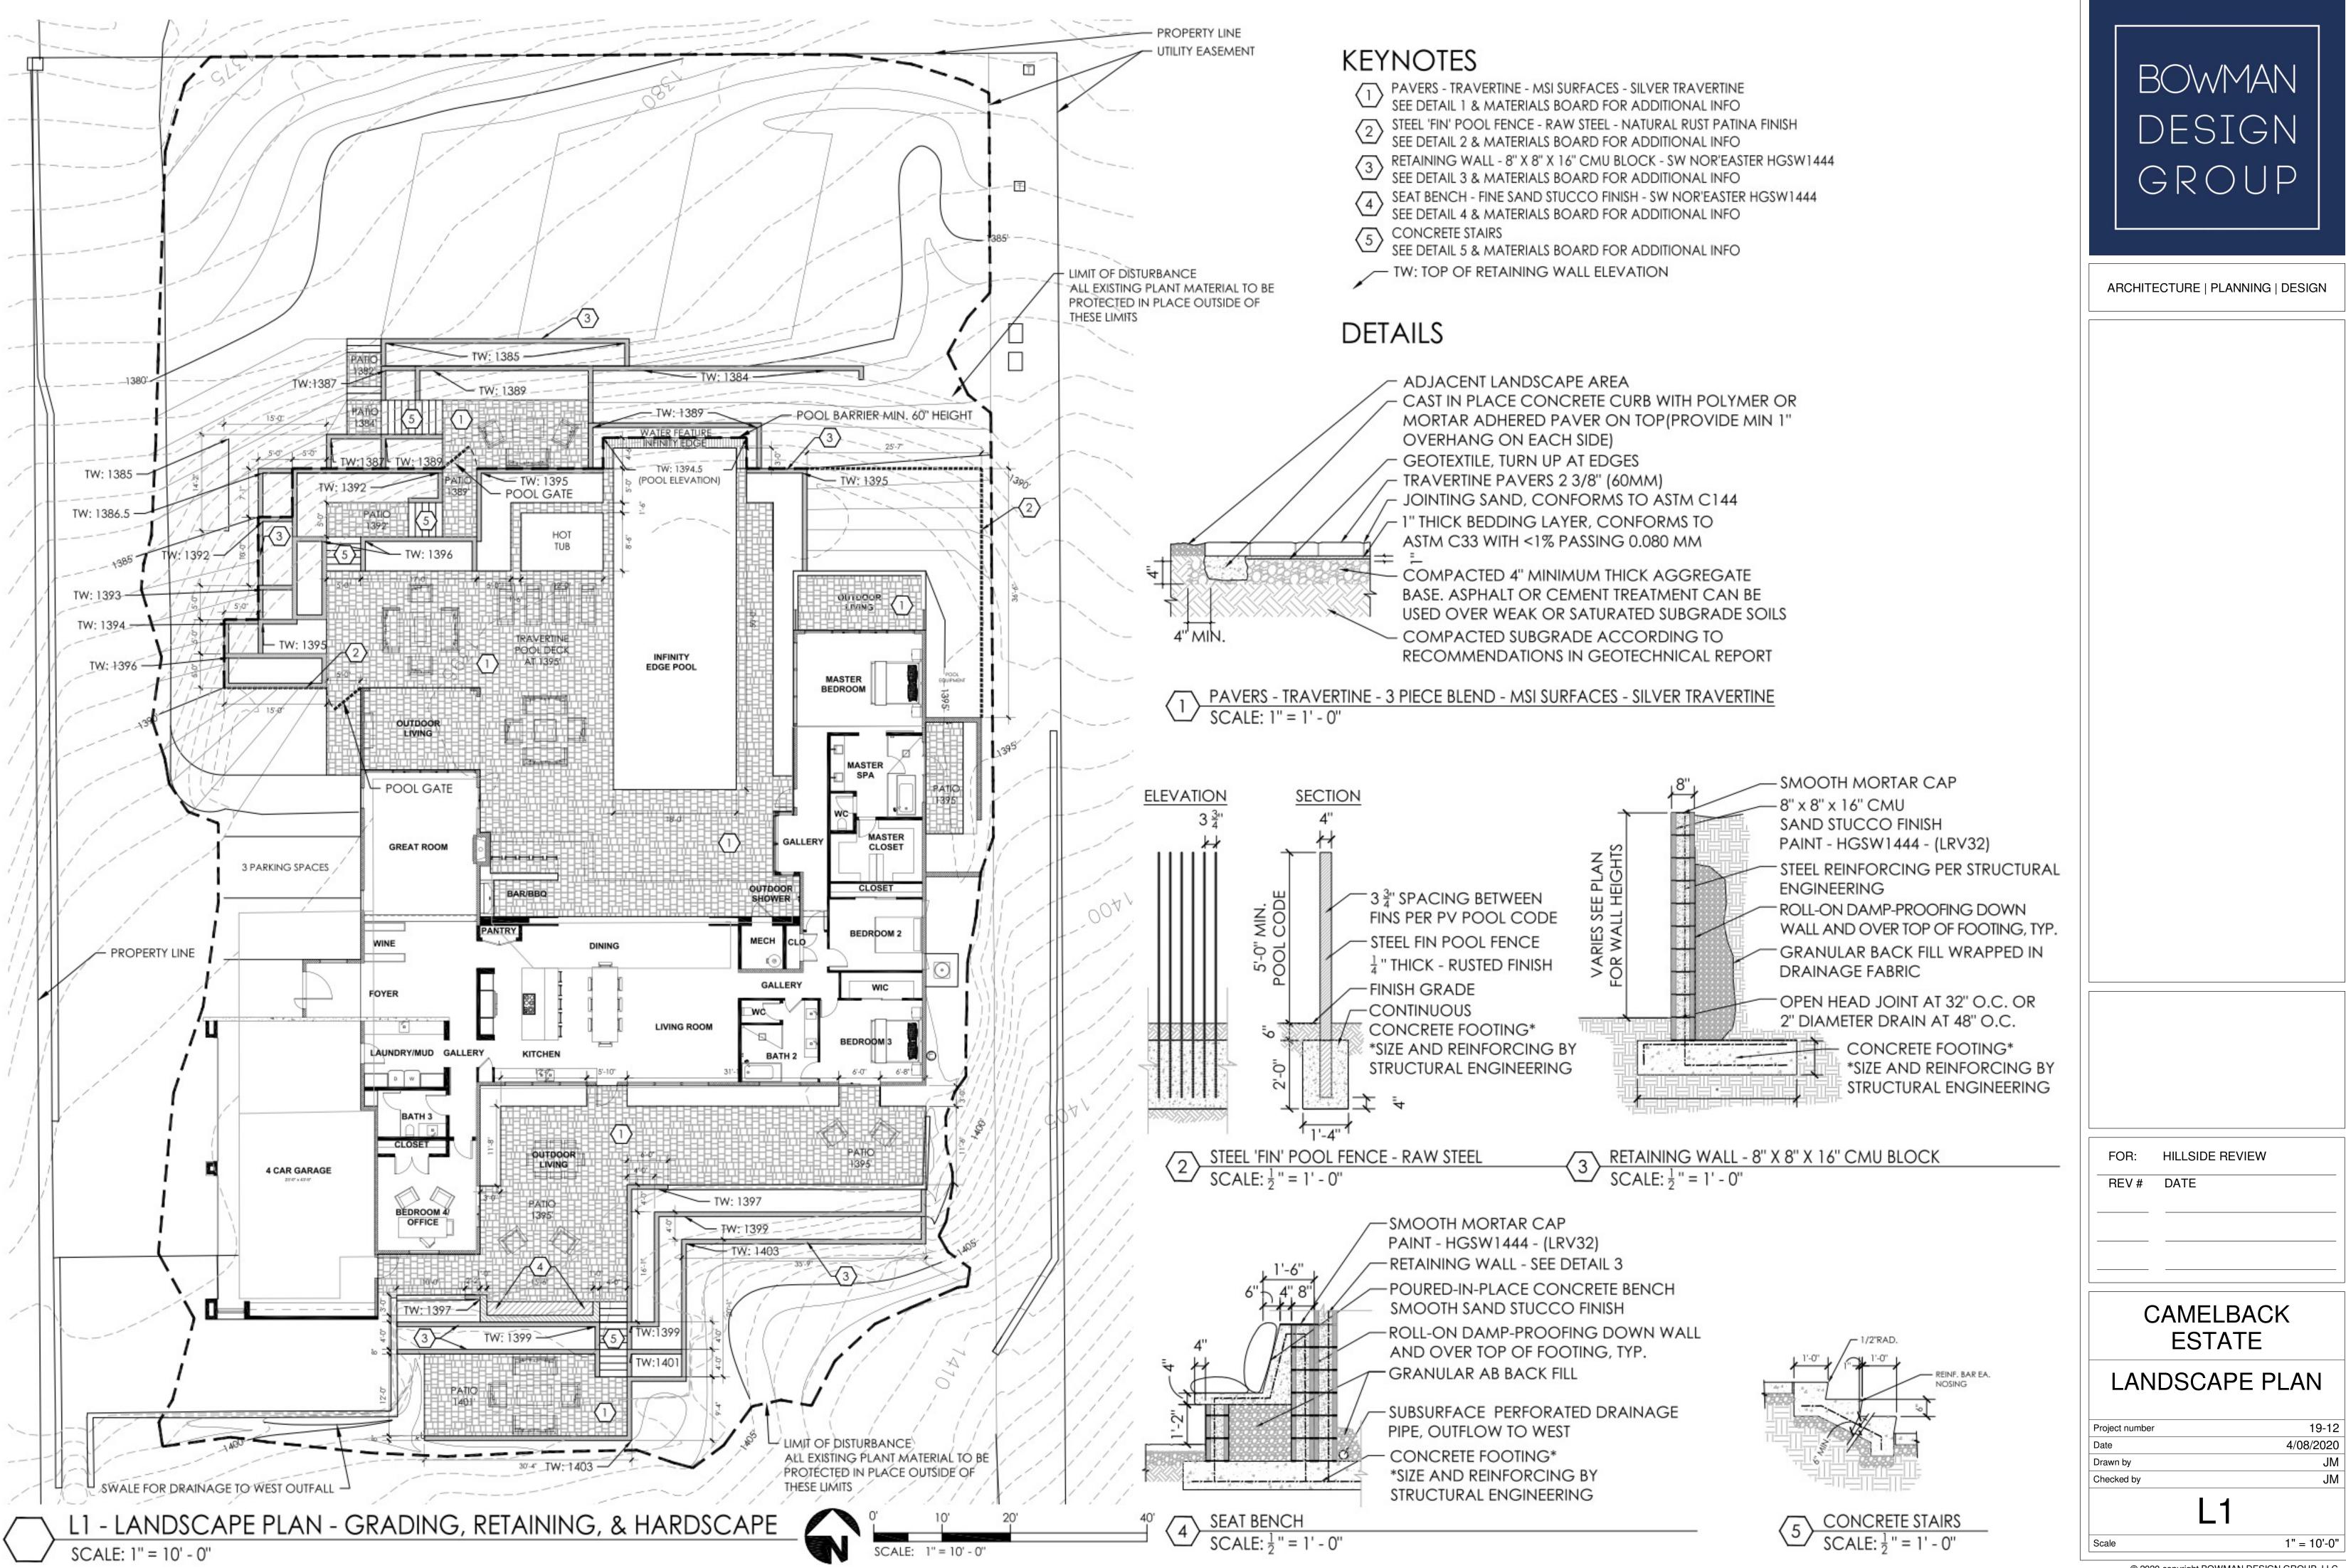

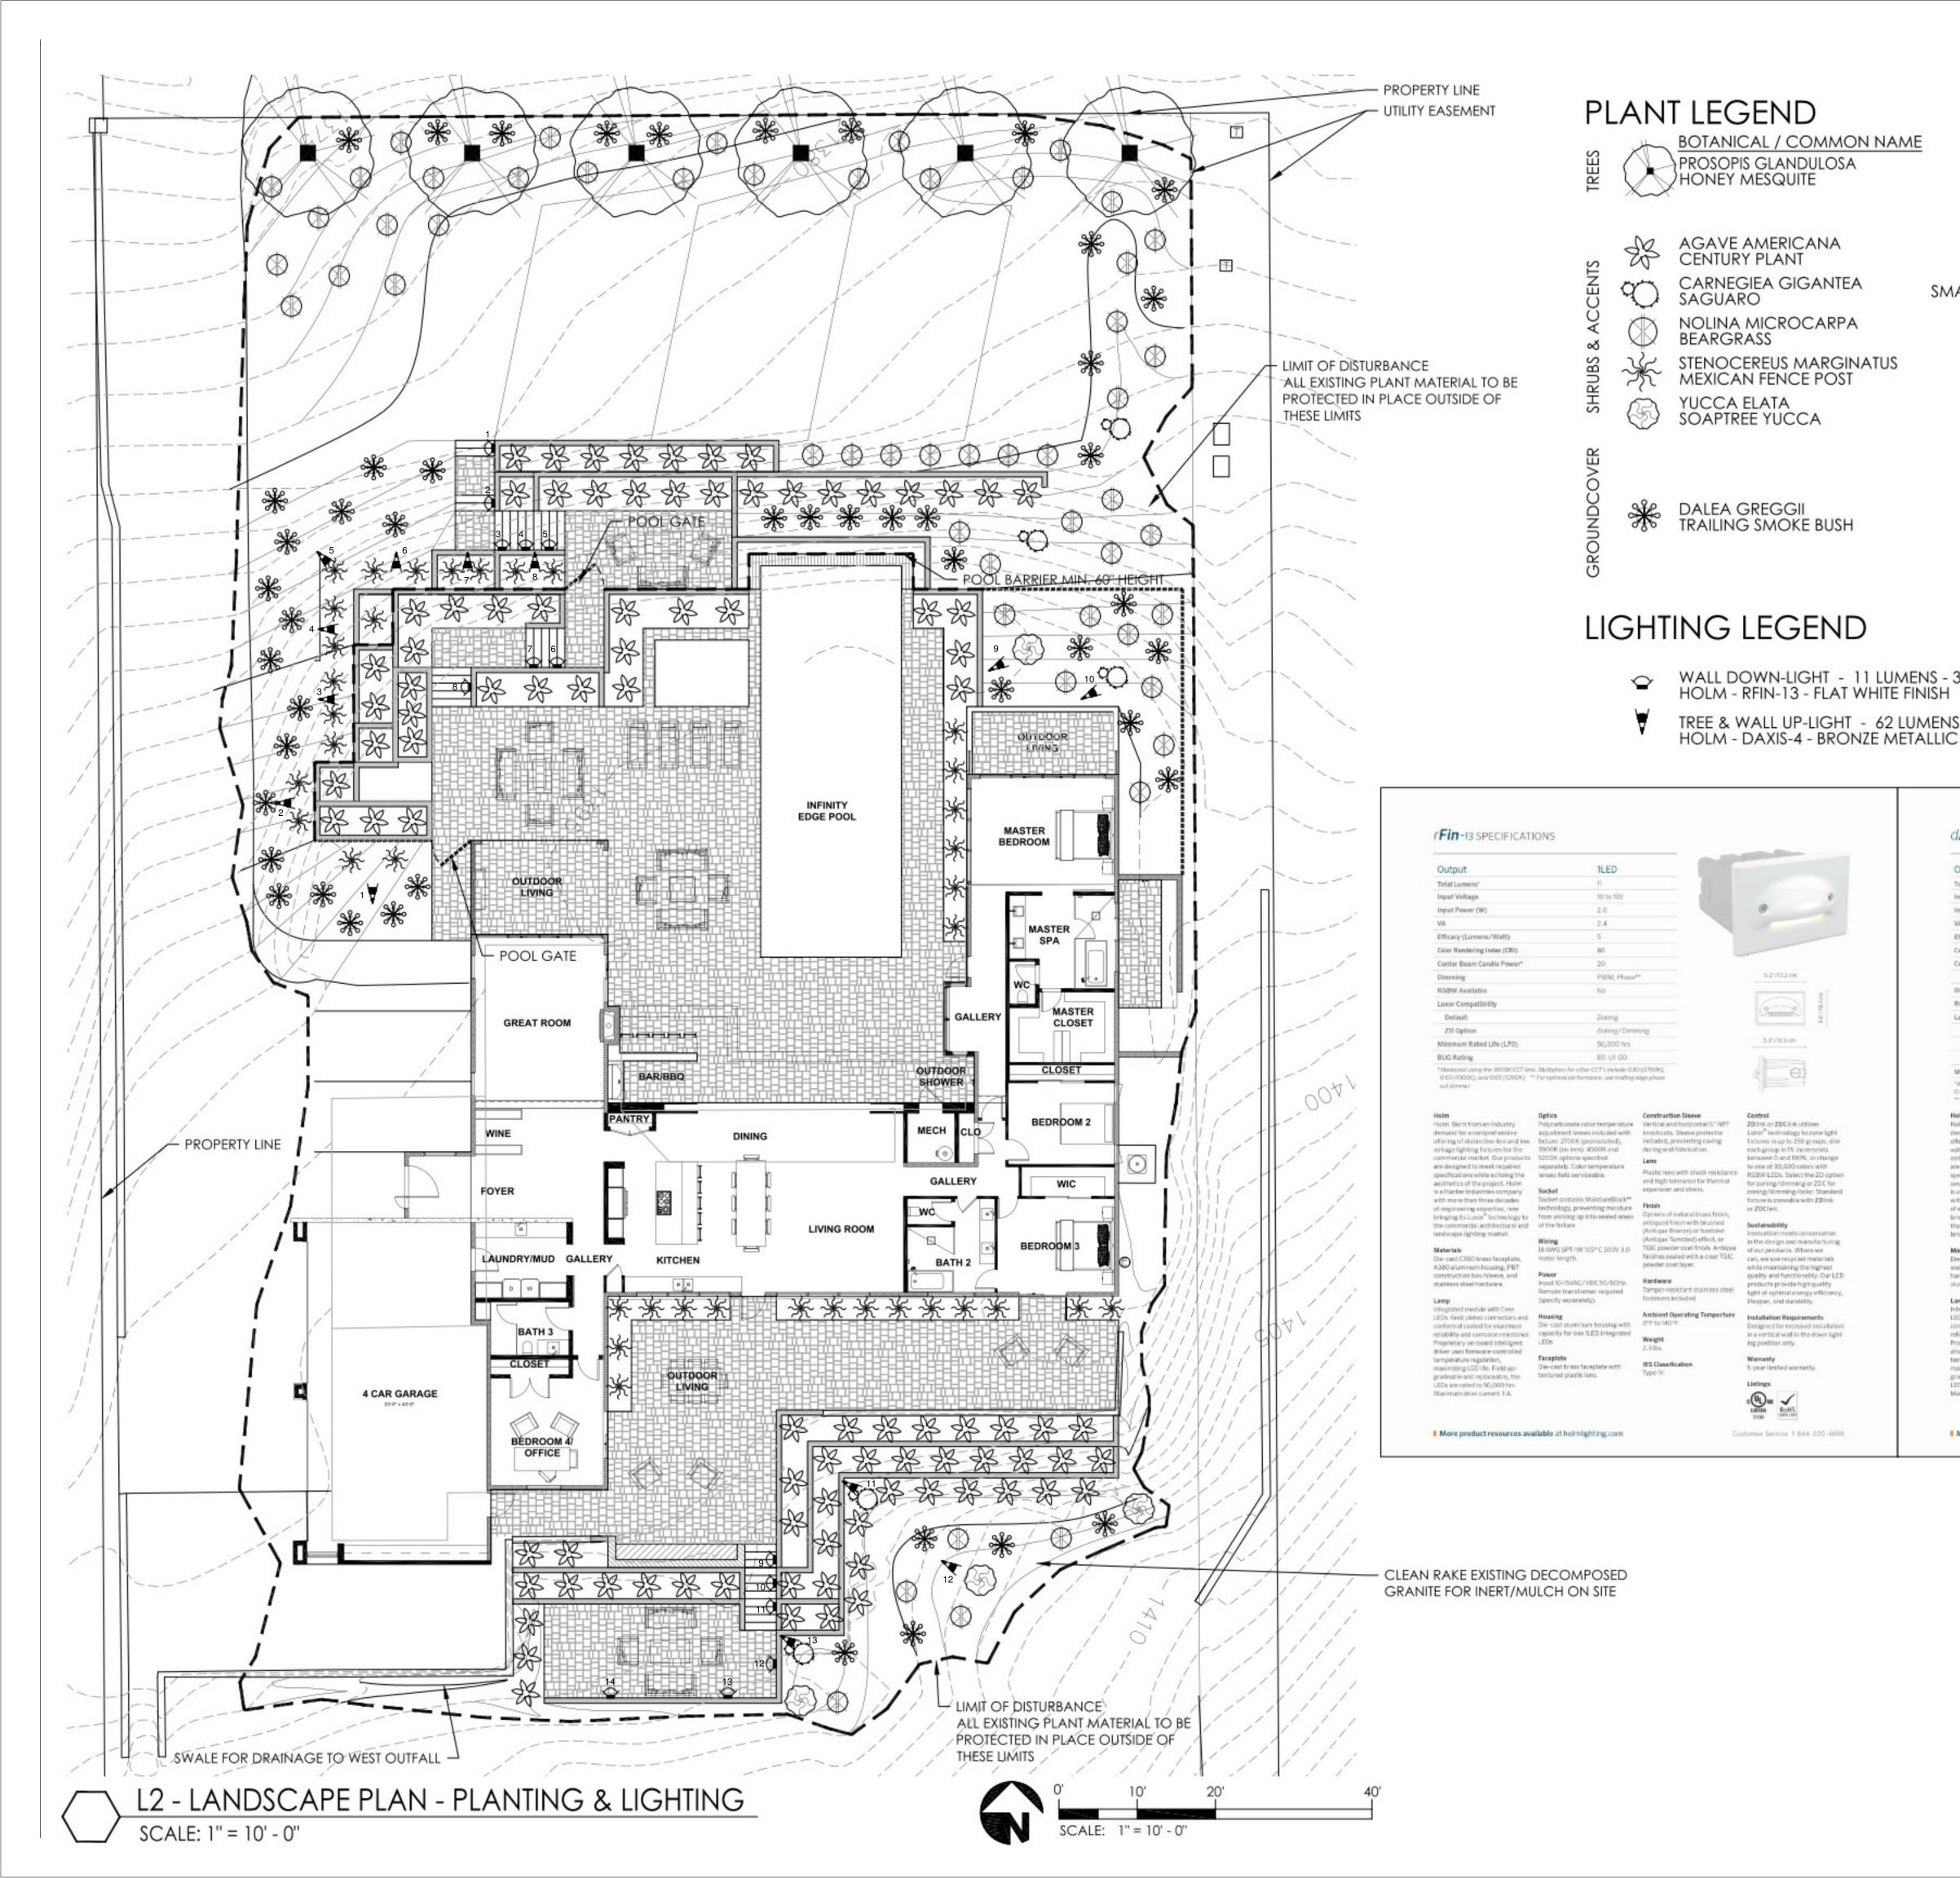

14 K	SIZE / CALIPER 8" BOX/3" CAL	10 10 10 10 10 10 10 10 10 10 10 10 10 1	
SMAL	l TRANSPLANT 5 GAL. 15 GAL.	54 38	
	15 GAL. 5 GAL.	4	
NS - 300 NISH MENS - ALLIC FI	3000K	<u>QTY</u> 14 13	

1LED Output Total Lumens Input Voltage Input Power (W) Efficacy (Lumens/Wal Color Rendering Index (CRI Center Beam Candle Power* Dimming PWM, Phane* RGBW Available Luxor Compatibility Default Zoning ZD Option Zoning/Dimming ZDC Option Minimum Rated Life (hrs) 50,000 ¹ Measured using the 3900K CCT lens. Multipliers for other CCT's include 0.80 (2700K), 0.65 (4500/0, and 0.65 (5200K) * Information not available for Flood or Wide Floo

dAxis-4 SPECIFICATIONS

** For optimal performance, use trailing edge phase cut dimmer

Holm. Born from an industry Polycarbonate color temperature Die-cast zinc/aluminum a loy

offering of distinctive line and low 2700K (preinstalled), 3900K (no Compress and lock features voltage lighting flutures for the commercial market. Our products for 10°, 20°, 9° increments adjustability over 0 and 100%, or change bio optics for 10°, 20°, 9° increments adjustability over 0 and 100%, or change are designed to meet required 30%-32% or 55-58° distributions 220° of vertical alignment. specifications while echoing the ordered preasembled to fisture aesthetics of the project. Holm (field serviceable). Beam angle is Lens is a Hunter Industries company calculated using LM-79 method. Tempered glass lans with shock roning/dimming/color. Standard with more than three decades for SSL luminaires. of engineering expertise, now bringing its Luxer® technology to Socket e commercial architectural and Socket contains Molsturelflock^{ie} Finish technology, preventing moisture Two-layer protection of marinelandscape lighting market. from wicking up into sealed areas grade sulfuric acid anothration Materials of the flature. and polyester TEIC powder Die-cast aluminum A380 housing and shroud with stainless steel hardware. Die-cast zinc/ 18 AWG SPT-TW 105° C 30CV 1.5 Tested to ASTM standards. aluminum alloy knuckle. meter length. Hardware

Power Integrated module with Cree Input 10-15VAC/VDC 50/60Hz. lock screw. Includes ProAim[®] LEDs. Gold plated connectors and Remote transformer required conformal coated for maximum (specify separately). reliability and corrosion resistance. Proprietary on-board intelligent Housing driver uses firmware-controlled Die-cast aluminum housing with capacity for "LED integrated LEDs Ambient Operating Temperture 5-year limited warranty temperature regulation, maximizing LED He. Fleid up-

gradeable and replaceable, the Shroud Die-cast aluminum shroud with Weight LEDs are rated to 50,000 hrs. 25° cutoff. Maximum drive current: 1.A.

More product resources available at holmlighting.com

175/43 cm

ZDlink or ZDClink utilizes demand for a comprehensive filters included with focure knuckle with %-14 NPSM threads. Loop* technology to zone light Extures in up to 250 groups, dim

to one of 30,000 colors with RGBW LEDs. Select the ZD option for zoning/dimming or ZDC fo resistance and high tolerance for duture is zoneable with ZDI ink or thermal expansion and stress. ZDClink.

Sustainability innovation meets conservation in the design and manufacturing of our products. Where we coat, providing superior outdoor can, we use recycled materials while maintaining the highest quality and functionality. Our LEI products provide high quality light at optimal energy efficiency

> Hespan, and durability. Installation Requirements Designed for installation in th upward direction only.

Warranty



%-20 x N' stainless steel angle

ratcheting ABS spike for 360*

increments. Temper-resistant

horizontal rotation in 10*

locking screw included.

0"F to 140"F.

Customer Service 1-844-200-4656



ARCHITECTURE | PLANNING | DESIGN

FOR: HILLSIDE REVIEW REV # DATE

CAMELBACK ESTATE LANDSCAPE PLAN

Project number Date Drawn by Checked by L2

Scale


19-12


JM

JM

4/08/2020

1" = 10'-0"

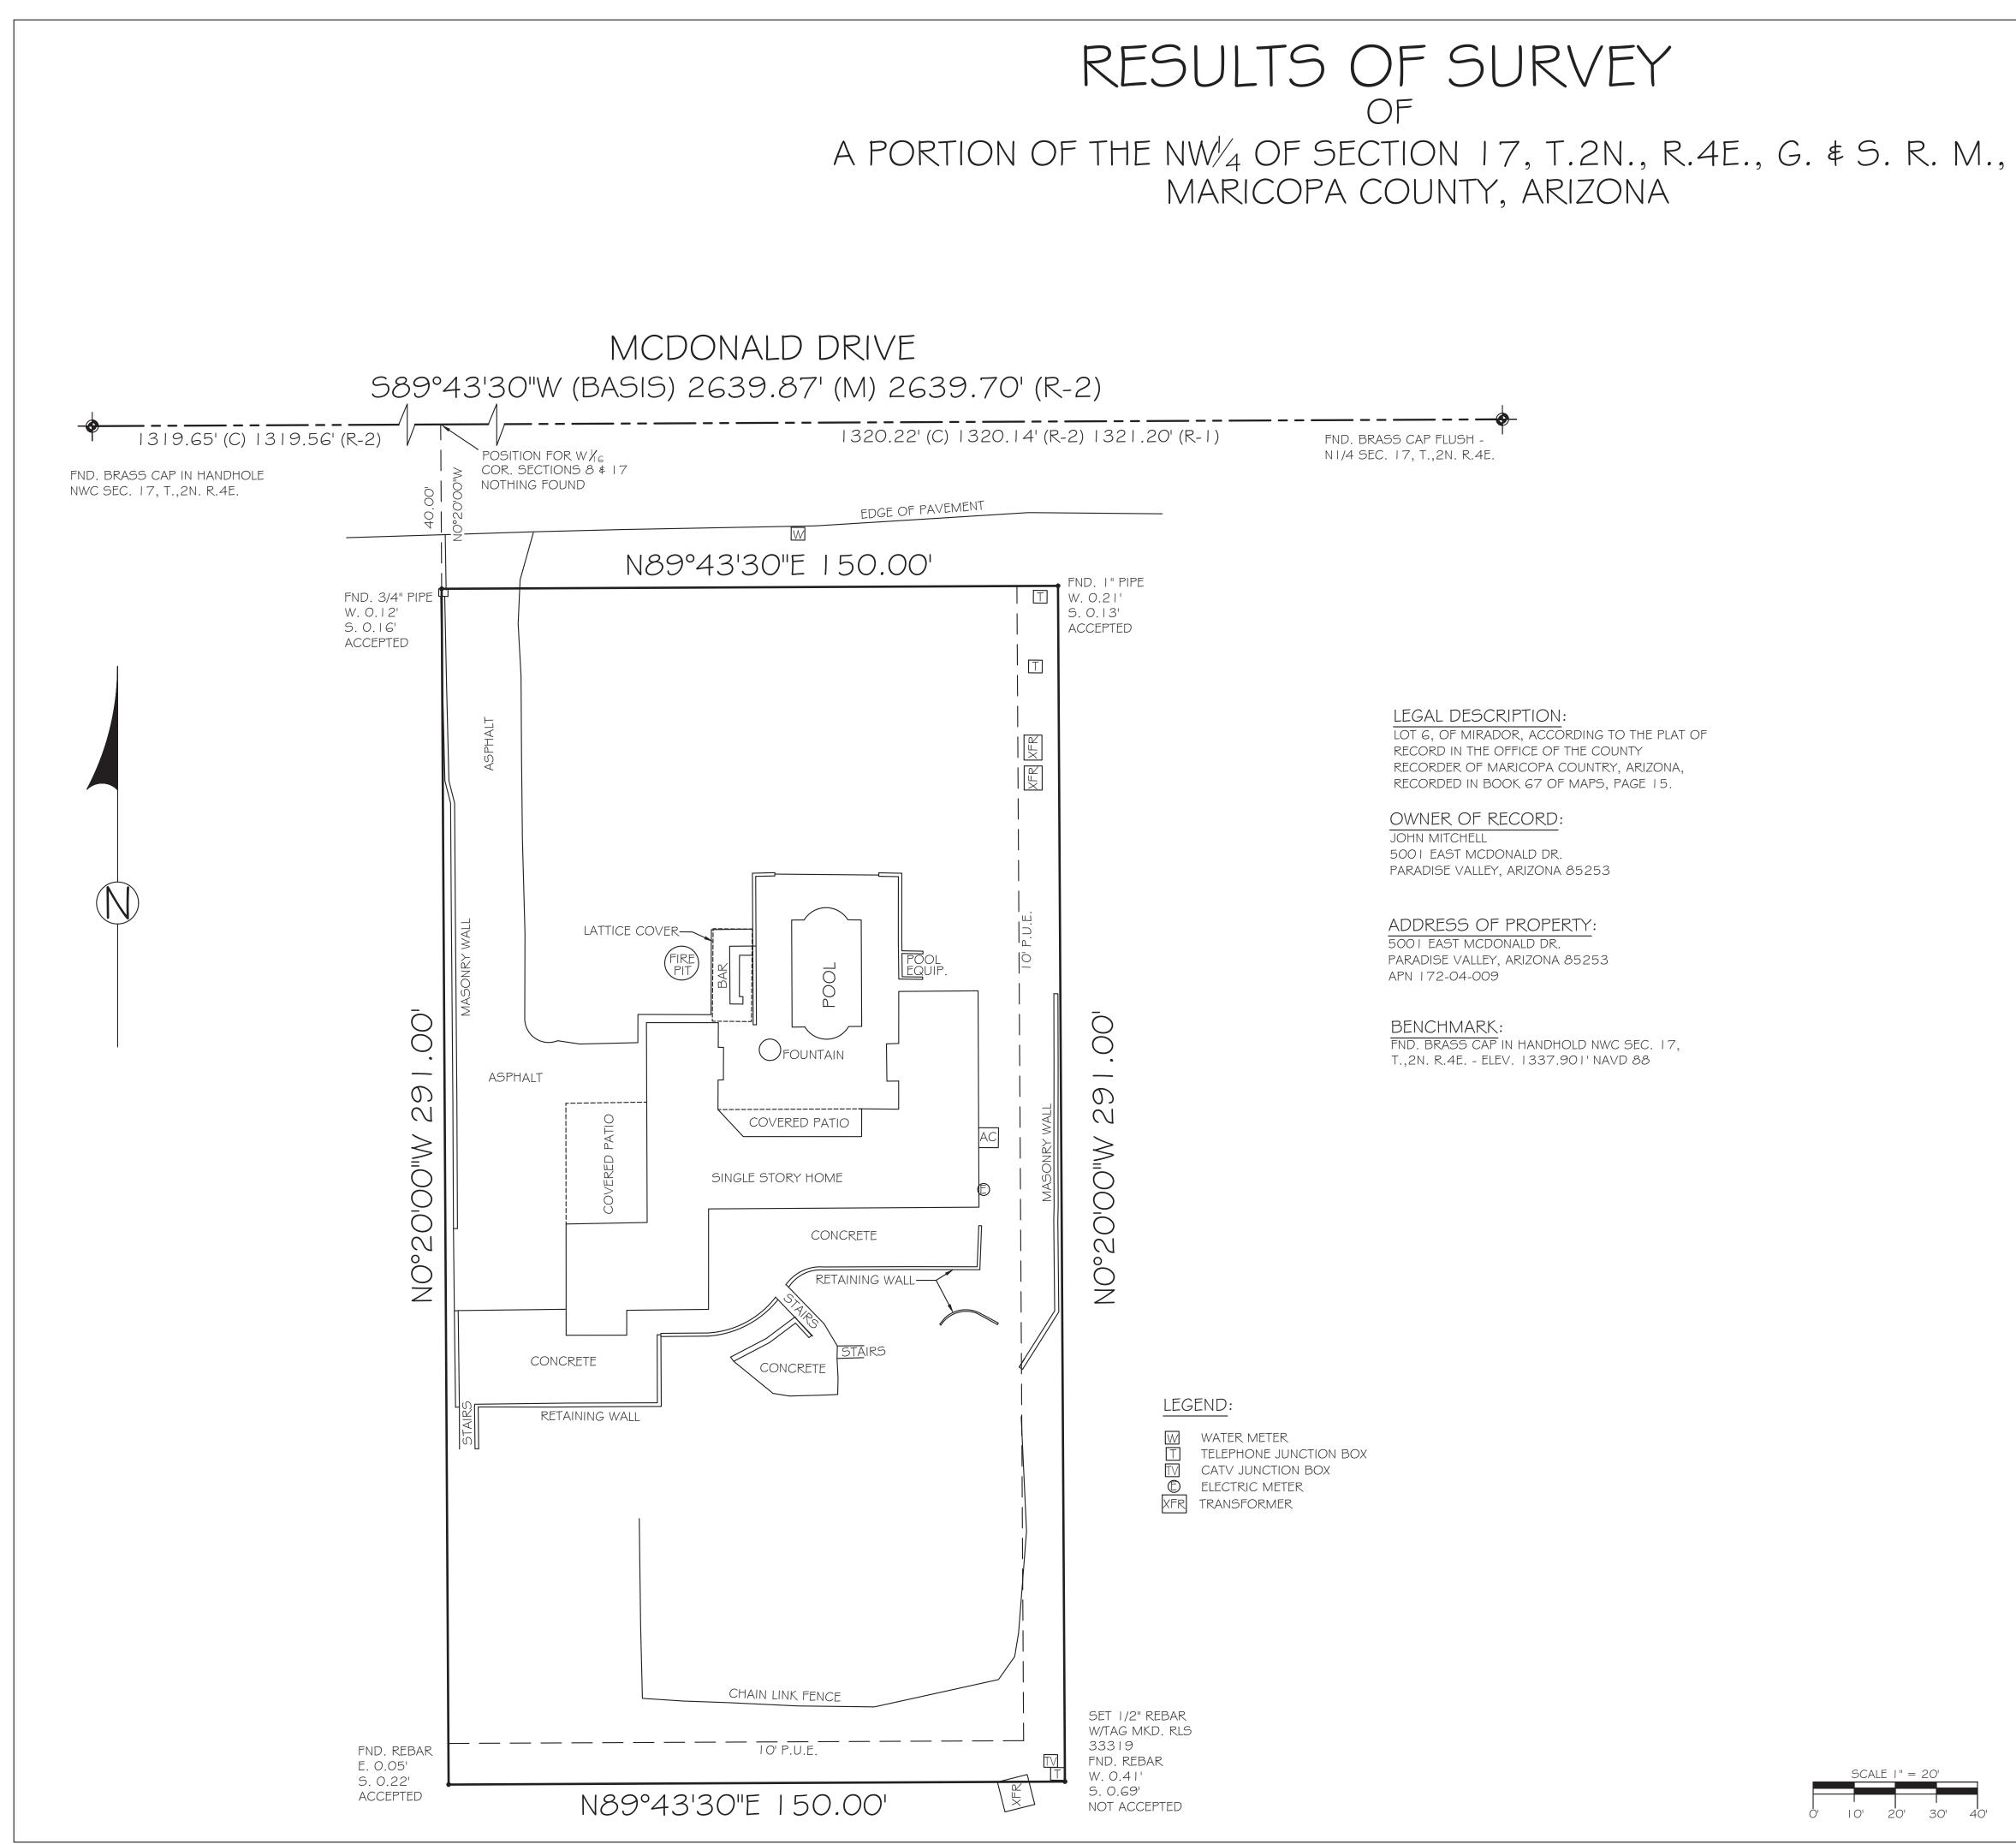

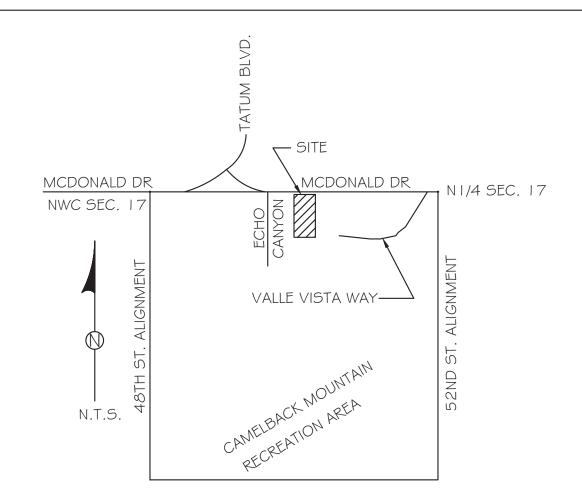

NOTES

- I. THIS SURVEY WAS PERFORMED IN THE FIELD DURING THE MONTH OF JULY, 2019.
- 3. ALL VISIBLE SURFACE UTILITIES WERE LOCATED, NO UNDERGROUND UTILITIES ARE SHOWN.
- 4. SURVEY PLATTED HEREON DOES NOT PURPORT TO VERIFY OWNERSHIP.

5. EXCEPT AS NOTED, SURVEYOR HAS MADE NO INVESTIGATION OR INDEPENDENT SEARCH FOR EASEMENTS OF RECORD, ENCUMBRANCES, RESTRICTIVE COVENANTS. OWNERSHIP TITLE EVIDENCE, OR ANY OTHER FACTS THAT AN ACCURATE AND CURRENT TITLE REPORT MAY DISCLOSE.

6. DECLARATION IS MADE TO ORIGINAL PURCHASER ONLY. SURVEY IS NOT TRANSFERABLE TO SUBSEQUENT OWNERS OR ADDITIONAL INSTITUTIONS WITHOUT WRITTEN PERMISSION OF THE SURVEYOR.

- 7. SURVEY IS VALID ONLY IF PRINT BEARS ORIGINAL SEAL AND SIGNATURE OF SURVEYOR.
- 8. CONDITIONS SHOWN ARE THOSE THAT EXISTED AT THE TIME OF SURVEY.
- 9. RECORD BOUNDARY AND EASEMENT INFORMATION TAKEN FROM THE FOLLOWING:
 - R-1 "MIRADOR", BOOK 67 OF MAPS, PAGE 11.
 - R-2 "FINAL PLAT FOR HF SURPRISE ESTATES", BOOK 1251 OF MAPS, PAGE 48.

SURVEYORS STATEMENT

I, KENT DAVID MILLER, A PROFESSIONAL LAND SURVEYOR, REGISTERED IN THE STATE OF ARIZONA, STATE THAT THIS PLAT AND THE SURVEY UPON WHICH IT IS BASED, WAS COMPLETED UNDER MY DIRECT SUPERVISION DURING THE MONTH OF JULY, 2019, AND THAT ALL MONUMENTS FOUND OR SET ARE CORRECT TO THE BEST OF MY KNOWLEDGE AND ARE SUFFICIENT TO ALLOW THE SURVEY TO BE RETRACED.

Kerst set file	KENT D. MILLER, R.L.S.	file no. echocanyon_ros_01
33319 KENT D. ~~ R MILLER ~ Scoreg .4/ 4R/ZONA, U.S. ^{K.}	243 NORTH 65TH STREET SCOTTSDALE, ARIZONA 85254 (480) 23 -4492 FAX (480) 998-0 38	drawn by KDM checked by KDM
EXPIRES 3-31-2023	kdmsurveying@cox.net	APRIL 17,2020



(1) EXISTING NORTHEAST CORNER OF HOUSE



(4) EXISTING WEST SIDE OF THE HOUSE GARAGE AND COVERED ENTRY



(7) EXISTING BACK SIDE OF THE HOUSE SHOWING 2' RETAINING SITE WALLS



(2) EXISTING NORTH SIDE OF HOUSE WITH POOL



(5) EXISTING SOUTH SIDE OF THE HOUSE GARAGE AND OFFICE



(3) EXISTING NORTHWEST CORNER OF HOUSE



(6) EXISTING SOUTHEAST CORNER THE HOUSE UP THE HILL ON CORNER LOT



(9) EXISTING NORTHEAST CORNER OF THE LOT SHOWING LANDSCAPE



(8) EXISTING NORTHWEST CORNER OF THE LOT SHOWING LANDSCAPE





MCDONALD DRIVE 9 8 $\mathbf{\Omega}$ 6 KEY PLAN



ARCHITECTURE | PLANNING | DESIGN

REV # DATE

FOR: HILLSIDE REVIEW

CAMELBACK ESTATE PROPERTY PHOTOS

Project number Date Drawn by Checked by

Scale

19-12 4/08/2020 Author Checker A0.3


1" = 1'-0"

SOUTHEAST CORNER OF HOUSE




NORTHEAST CORNER OF HOUSE




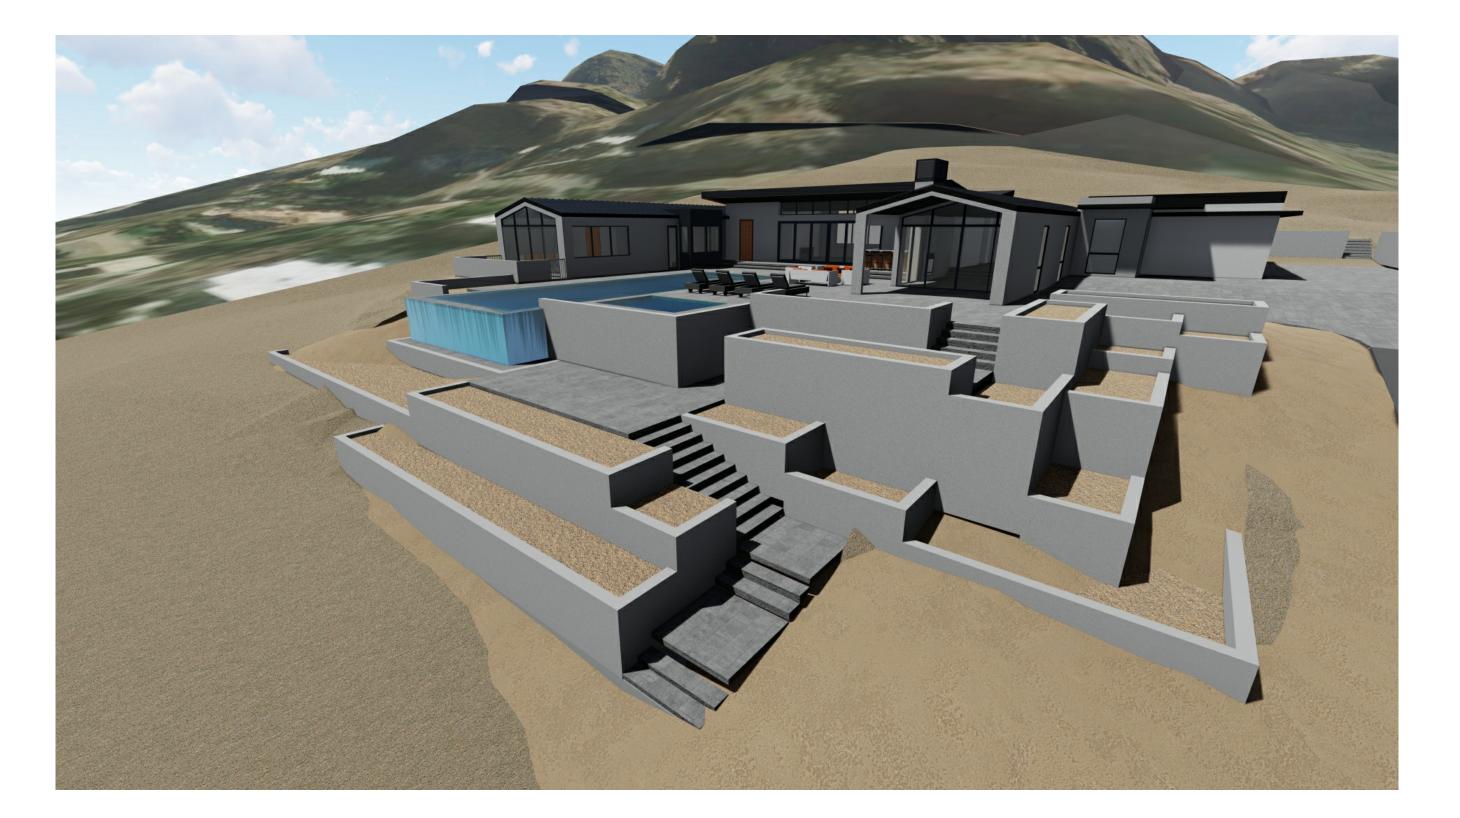


NORTHWEST CORNER OF HOUSE

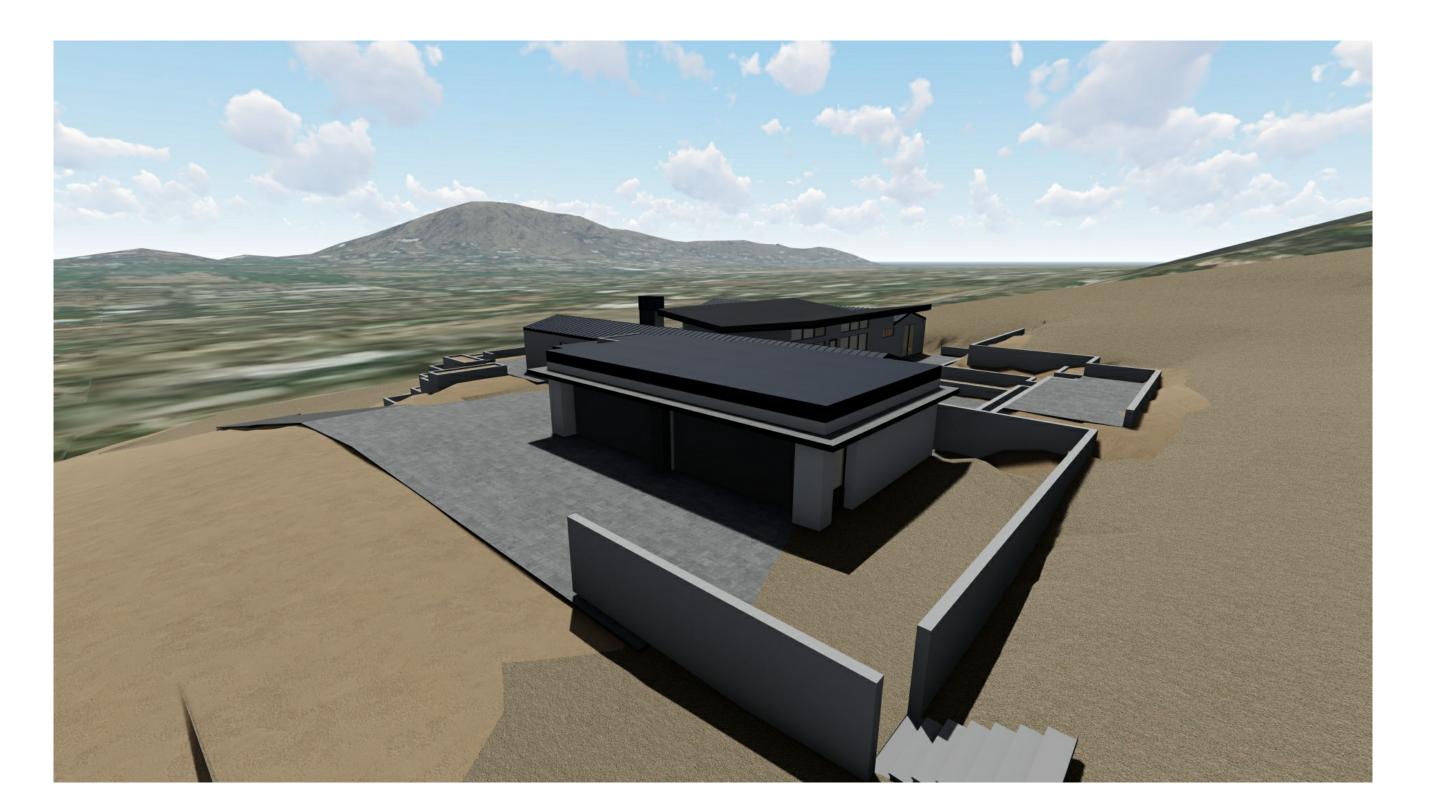

SOUTHWEST CORNER OF HOUSE

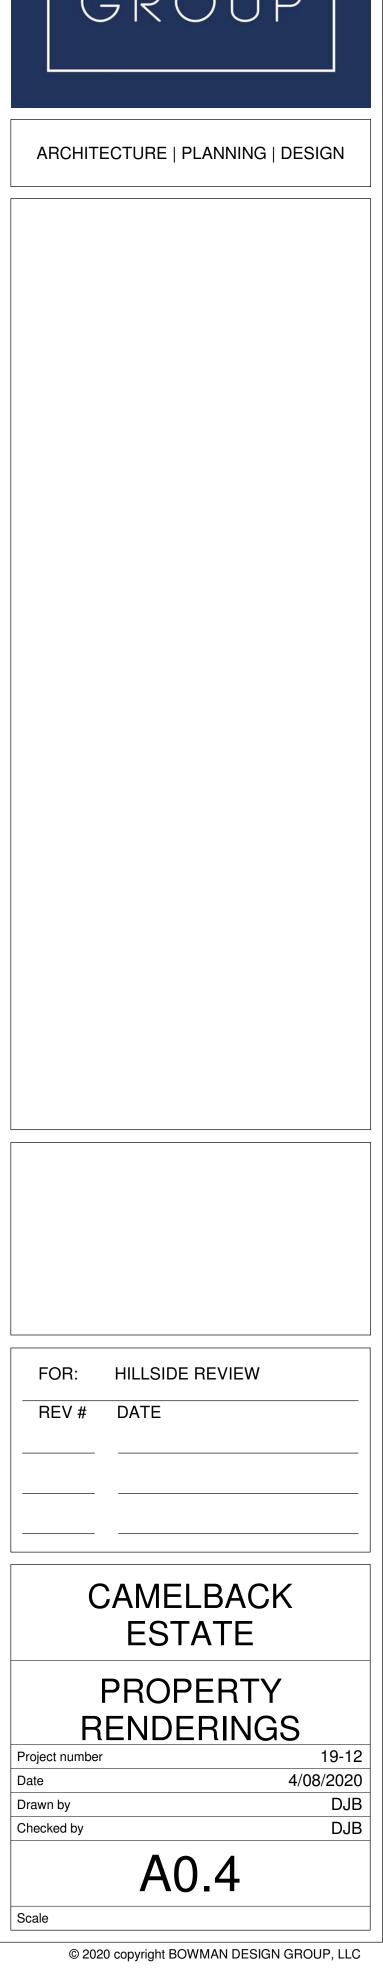



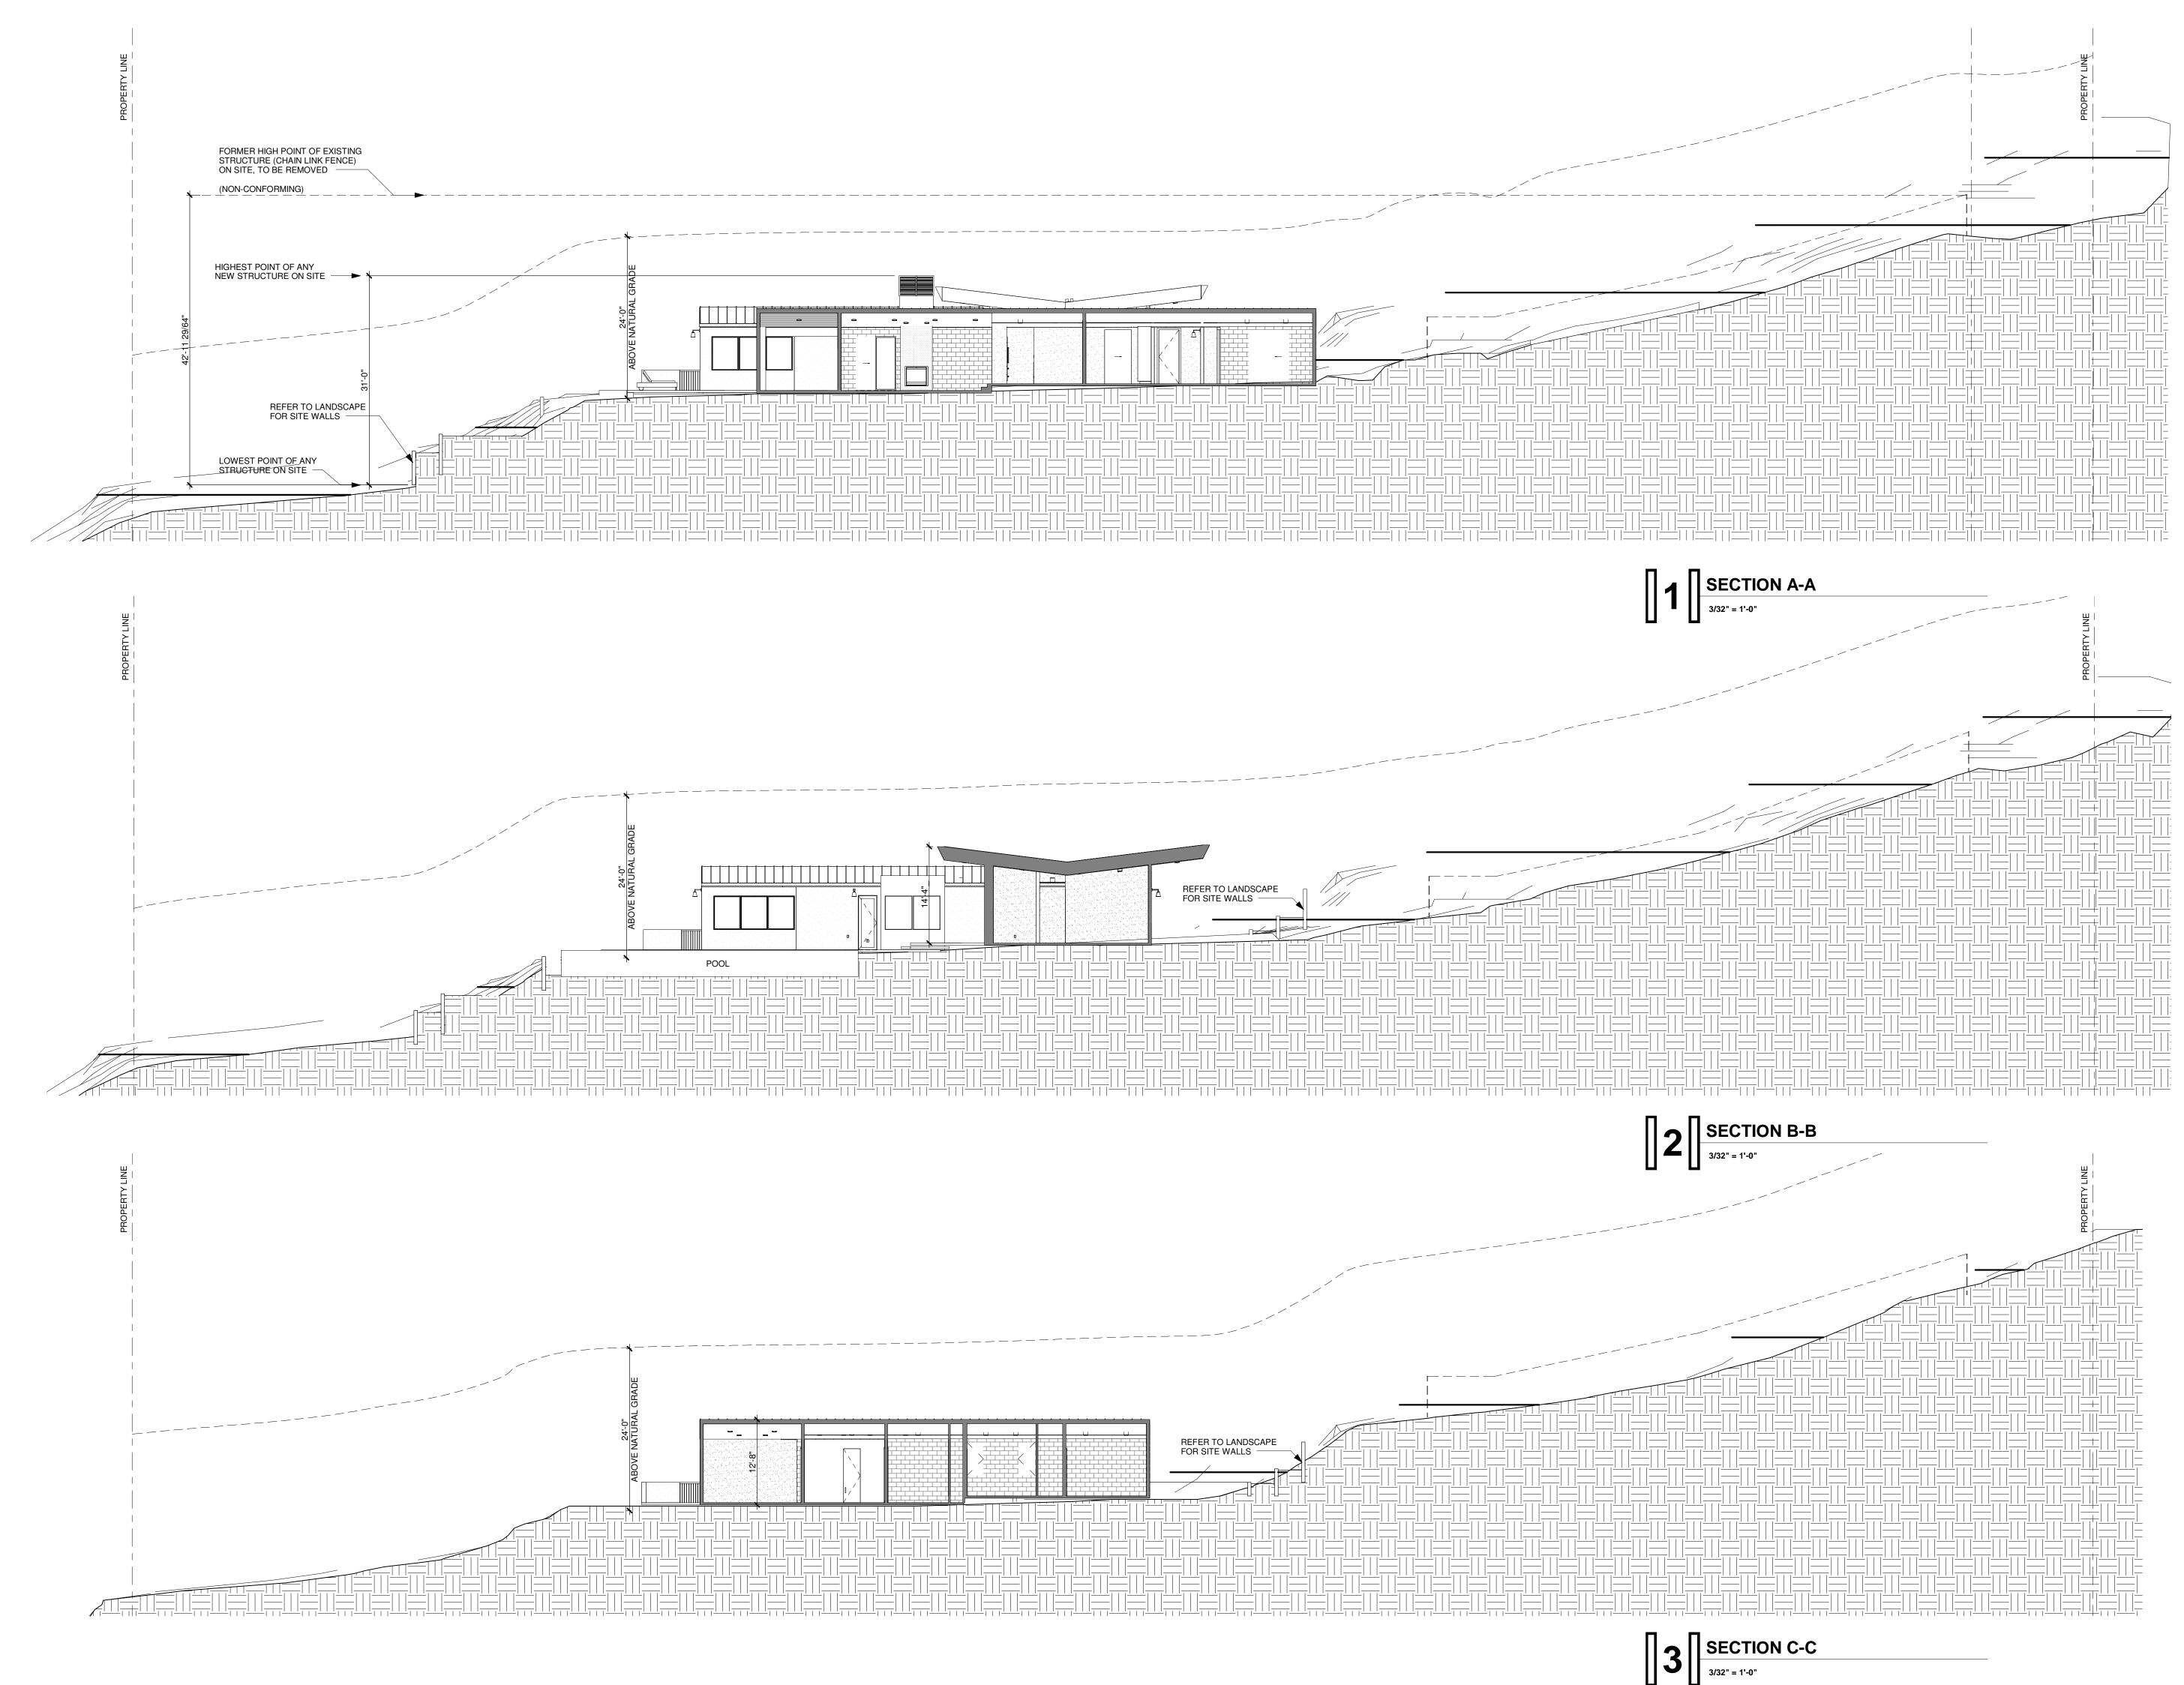

ARCHITECTURE | PLANNING | DESIGN

FOR: HILLSIDE REVIEW REV # DATE

CAMELBACK ESTATE SITE CROSS SECTIONS

Project number Date Drawn by Checked by

Scale

A0.5


19-12

DJB


DJB

4/08/2020

3/32" = 1'-0"

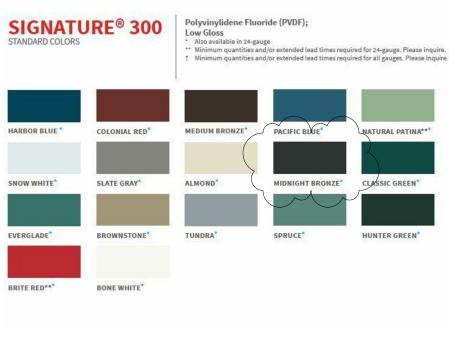




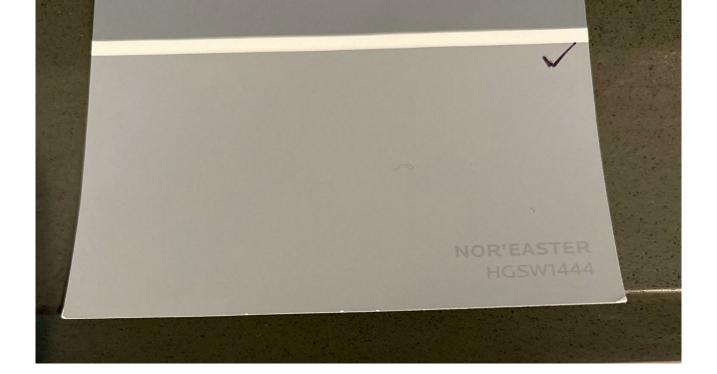

STUCCO PAINT, STUCCO SOFFITS, GYP BOARD SOFFITS, AND TRIM -SHERWIN WILLIAMS -NOR'EASTER - HGSW1444 - LRV = 32 (OR EQUIVALENT)




POOL DECK PAVERS MSI SURFACES -SILVER TRAVERTINE APPROX. LRV = 30 (OR EQUIVALENT)

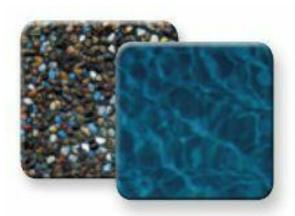

Midnight Blue

POOL FINISH -PEBBLETEC MIDNIGHT BLUE - APPROX LRV = 15 (OR EQUIVALENT)

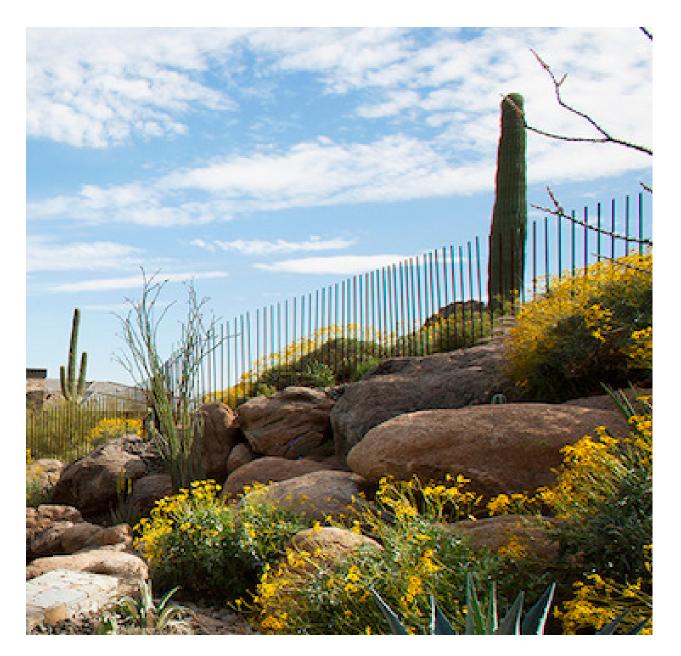




EXTERIOR TONGUE & GROOVE WOOD SOFFIT -SHERWIN WILLIAMS HAWTHORNE - SW3518 - APPROX LRV = 20 (OR EQUIVALENT)

STANDING SEAM METAL ROOF AND METAL FASCIA -MBCI METAL ROOFING -MIDNIGHT BRONZE - LRV = 7(OR EQUIVALENT)

SITE VIEW FENCE -RUSTED METAL REBAR OR FLAT BAR APPROX. LRV = 12 (OR EQUIVALENT)



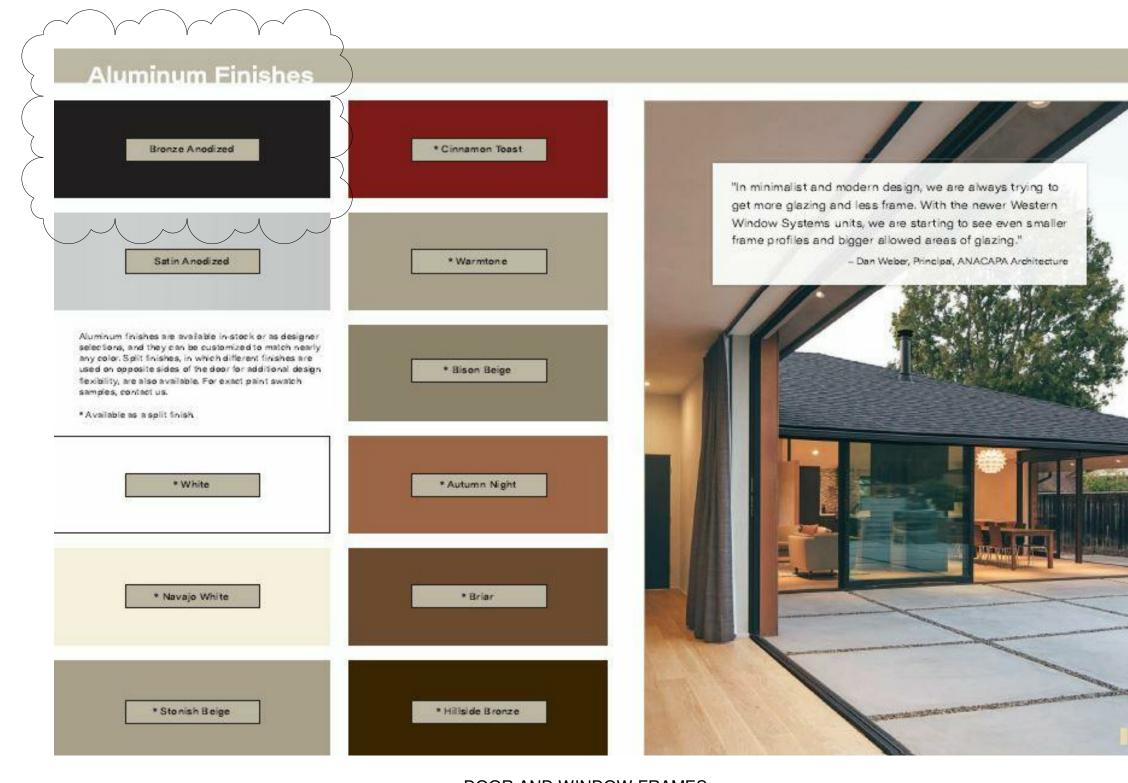


-WESTERN WINDOWS -DARK BRONZE ANODIZED - LRV = 7 (OR EQUIVALENT)



DRIVEWAY/PARKING PAVERS -BELGARD -LUEDERS GRAY APPROX. LRV = 30 (OR EQUIVALENT)



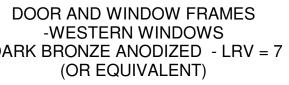





STONE VENEER

EXTERIOR WALL SCONCE -MODERN FARMS - DOUBLE DOWN OUTDOOR WALL SCONCE -BLACK FINISH - 3000 KELVIN - 275 LUMENS LRV = 5

BOWMAN DESIGN GROUP

ARCHITECTURE | PLANNING | DESIGN

GENERAL MATERIAL NOTES

- 1. ALL EXTERIOR MATERIAL PALETTE SHALL BE IN ACCORDANCE WITH SECTION 2207.II.D.
- 2. ALL EXTERIOR LIGHTING SHALL COMPLY WITH SECTION 2208.

FOR: HILLSIDE REVIEW REV # DATE

CAMELBACK ESTATE


MATERIAL BOARD

Project number Date Drawn by Checked by

Scale

19-12 4/08/2020 DJB DJB A0.6

3/16" = 1'-0"

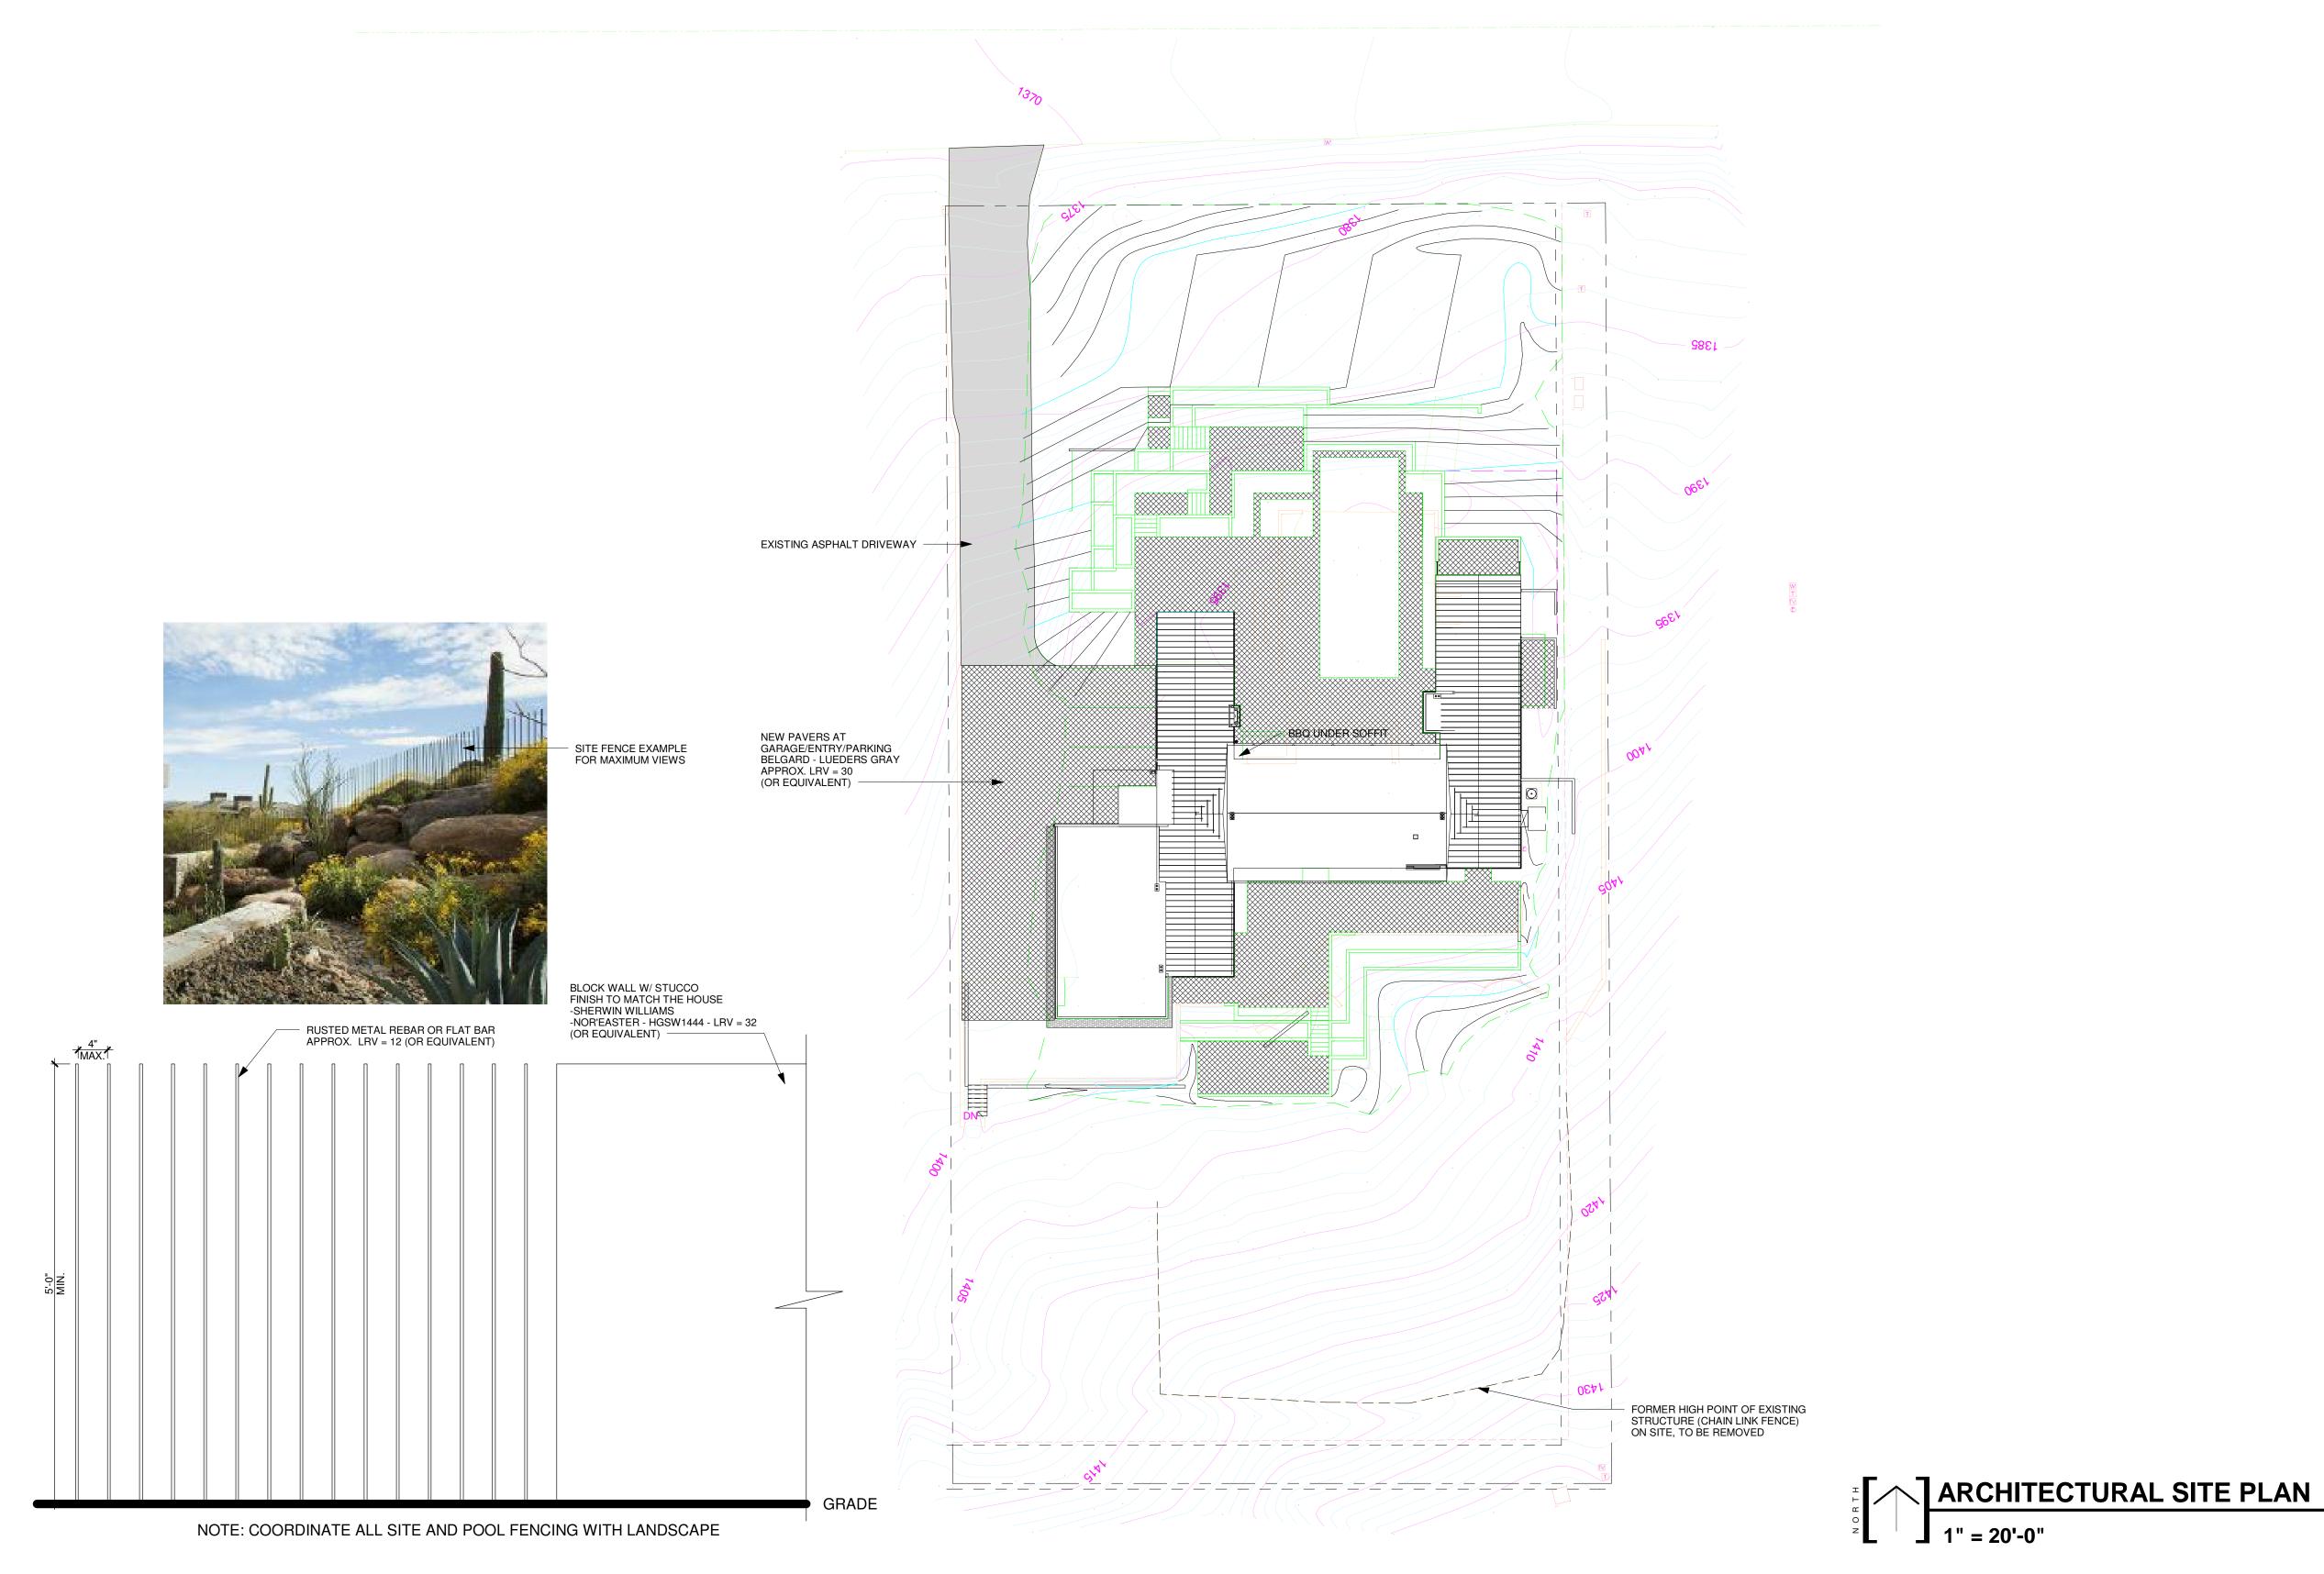

POOL FENCE SCHEMATIC 1" = 1'-0"

BOWMAN DESIGN GROUP

ARCHITECTURE | PLANNING | DESIGN

MATERIAL NOTES NOTE: SEE MATERIAL BOARD A0.6 FOR EXTERIOR SITE MATERIALS, COLOR, FINISH, AND LIGHT REFLECTIVE VALUE. FOR: HILLSIDE REVIEW REV # DATE CAMELBACK ESTATE ARCH. SITE PLAN 19-12 Project number 4/08/2020 Date DJB Drawn by DJB Checked by A1.1 As indicated Scale





ARCHITECTURE | PLANNING | DESIGN


$\frac{1}{2} = 20'-0"$

FOR:	HILLSIDE REVIEW	
REV #	DATE	
(CAMELBAC	κ
	ESTATE	
AR	CH. SITE PL	AN
Project numbe	r	19-12
Date		4/08/2020
Drawn by		DJB
Checked by		DJB
	A1.1a	
Scale		1" = 20'-0"

12,448 SF

2,444 SF 5,999 SF

1,814 SF

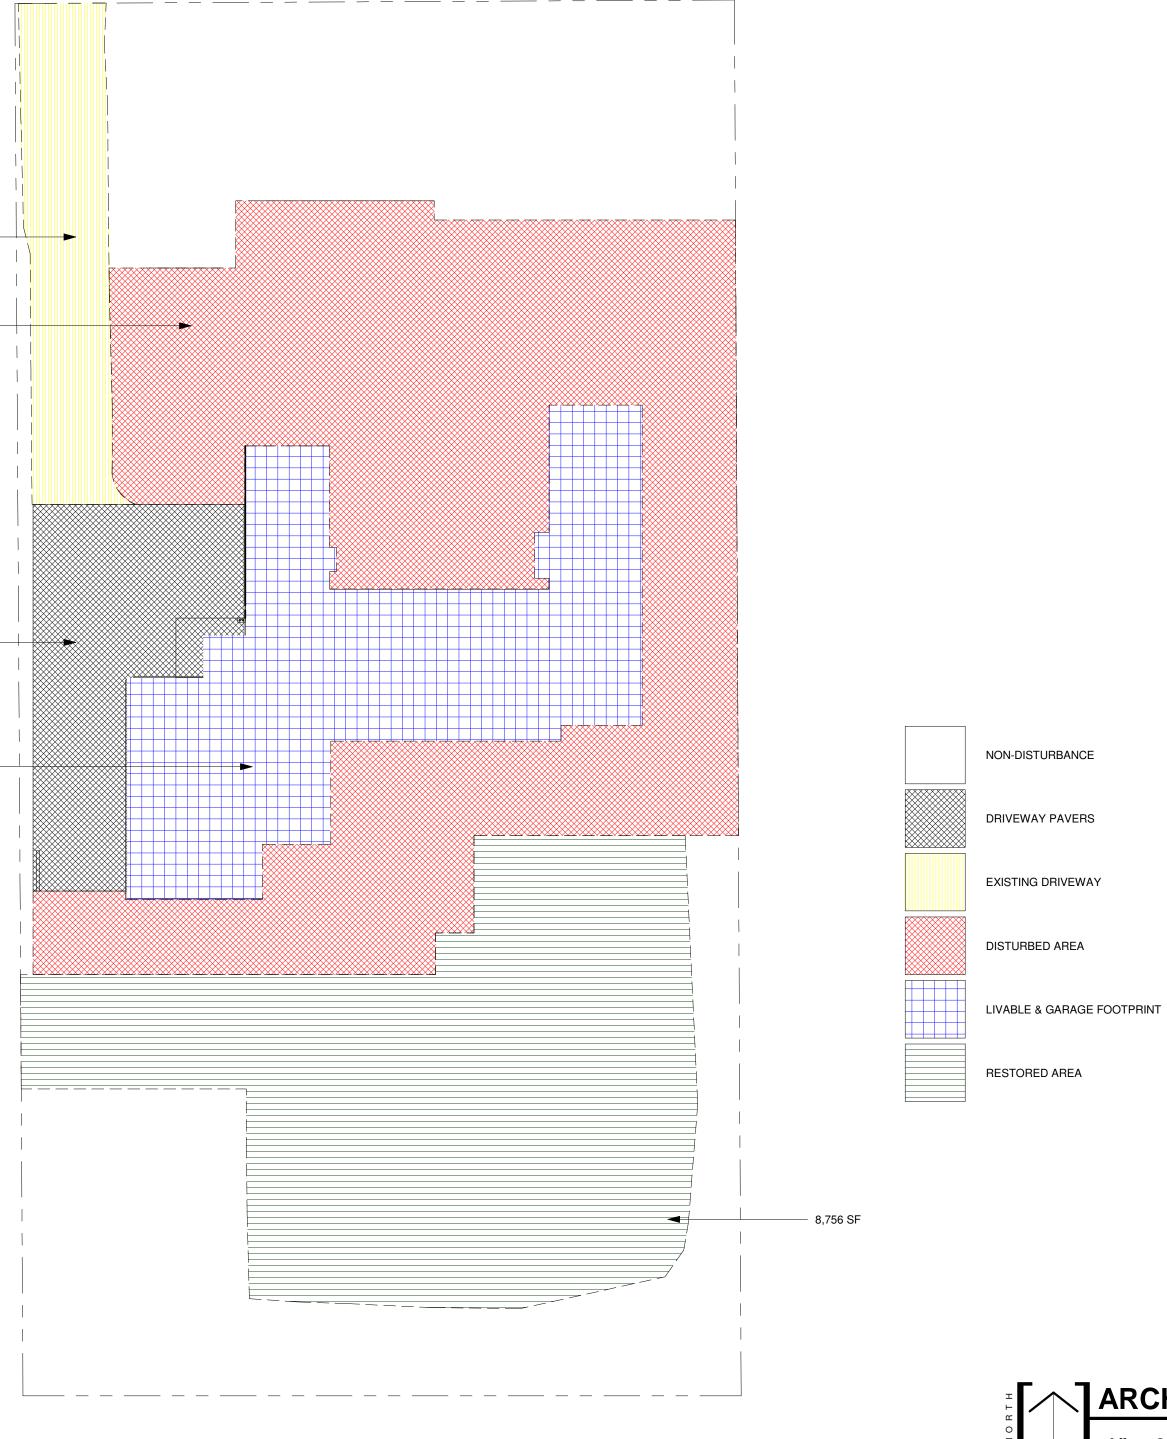

FOR: HILLSIDE REVIEW

REV # DATE

Project number

Date

Scale

Drawn by

Checked by

3% VOLUME OF CUT: 75 CY VOLUME OF FILL: 75 CY HILLSIDE ASSURANCE = 35x/CUBIC YARD OF CUT + FILL: \$6,633 DRIVEWAY: 4,258 SF (EXISTING ASPHALT - TOTAL) 1,814 SF (EXISTING ASPHALT TO REMAIN) 2,444 SF NEW PAVERS AREA MATERIAL EXISTING ASPHALT AND NEW BELGARD PAVERS COLOR & LRV PAVERS = LUEDERS GRAY - APPROX. LRV = 30 MAX. DISTANCE FROM NATURAL GRADE 4 INCHES (DRIVEWAY FOLLOWS SLOPE OF NATURAL GRADE) DISTURBANCE W/EXISTING ASPHALT 1,814 SF x 150% = 2,721 SF CREDIT 57% AND 2,444 SF

$\frac{1}{2} \begin{bmatrix} 1 \end{bmatrix} = 20'-0"$

PERCENT OF LOT STEEPER THAN NATURAL GRADE (5% MAX.)


6,119 / 43,573 = 14.0% 6,119 / 43,573 = 14.0% 13.74% VERTICAL: 40' HORIZONTAL: 291' ALLOWABLE DISTURBED AREA: ALLOWABLE DISTURBED AREA: 38.21% (MAX.) 16,649 SF (MAX.) 37,596 SF (TO BACK FENCE ON LOT - 86.3%) EXISTING DISTURBED AREA: (EXISTING DISTURBED AREA TO BE RE-VEGITATED): (8,756 SF) PROPOSED DISTURBED AREA: 23,718 SF

1.01 ACRES / 43,573 SF

DISTURBED AREA CALCULATIONS: AREA OF LOT: AREA UNDER ROOF: FLOOR AREA RATIO: BUILDING PAD SLOPE:

ARCHITECTURE | PLANNING | DESIGN



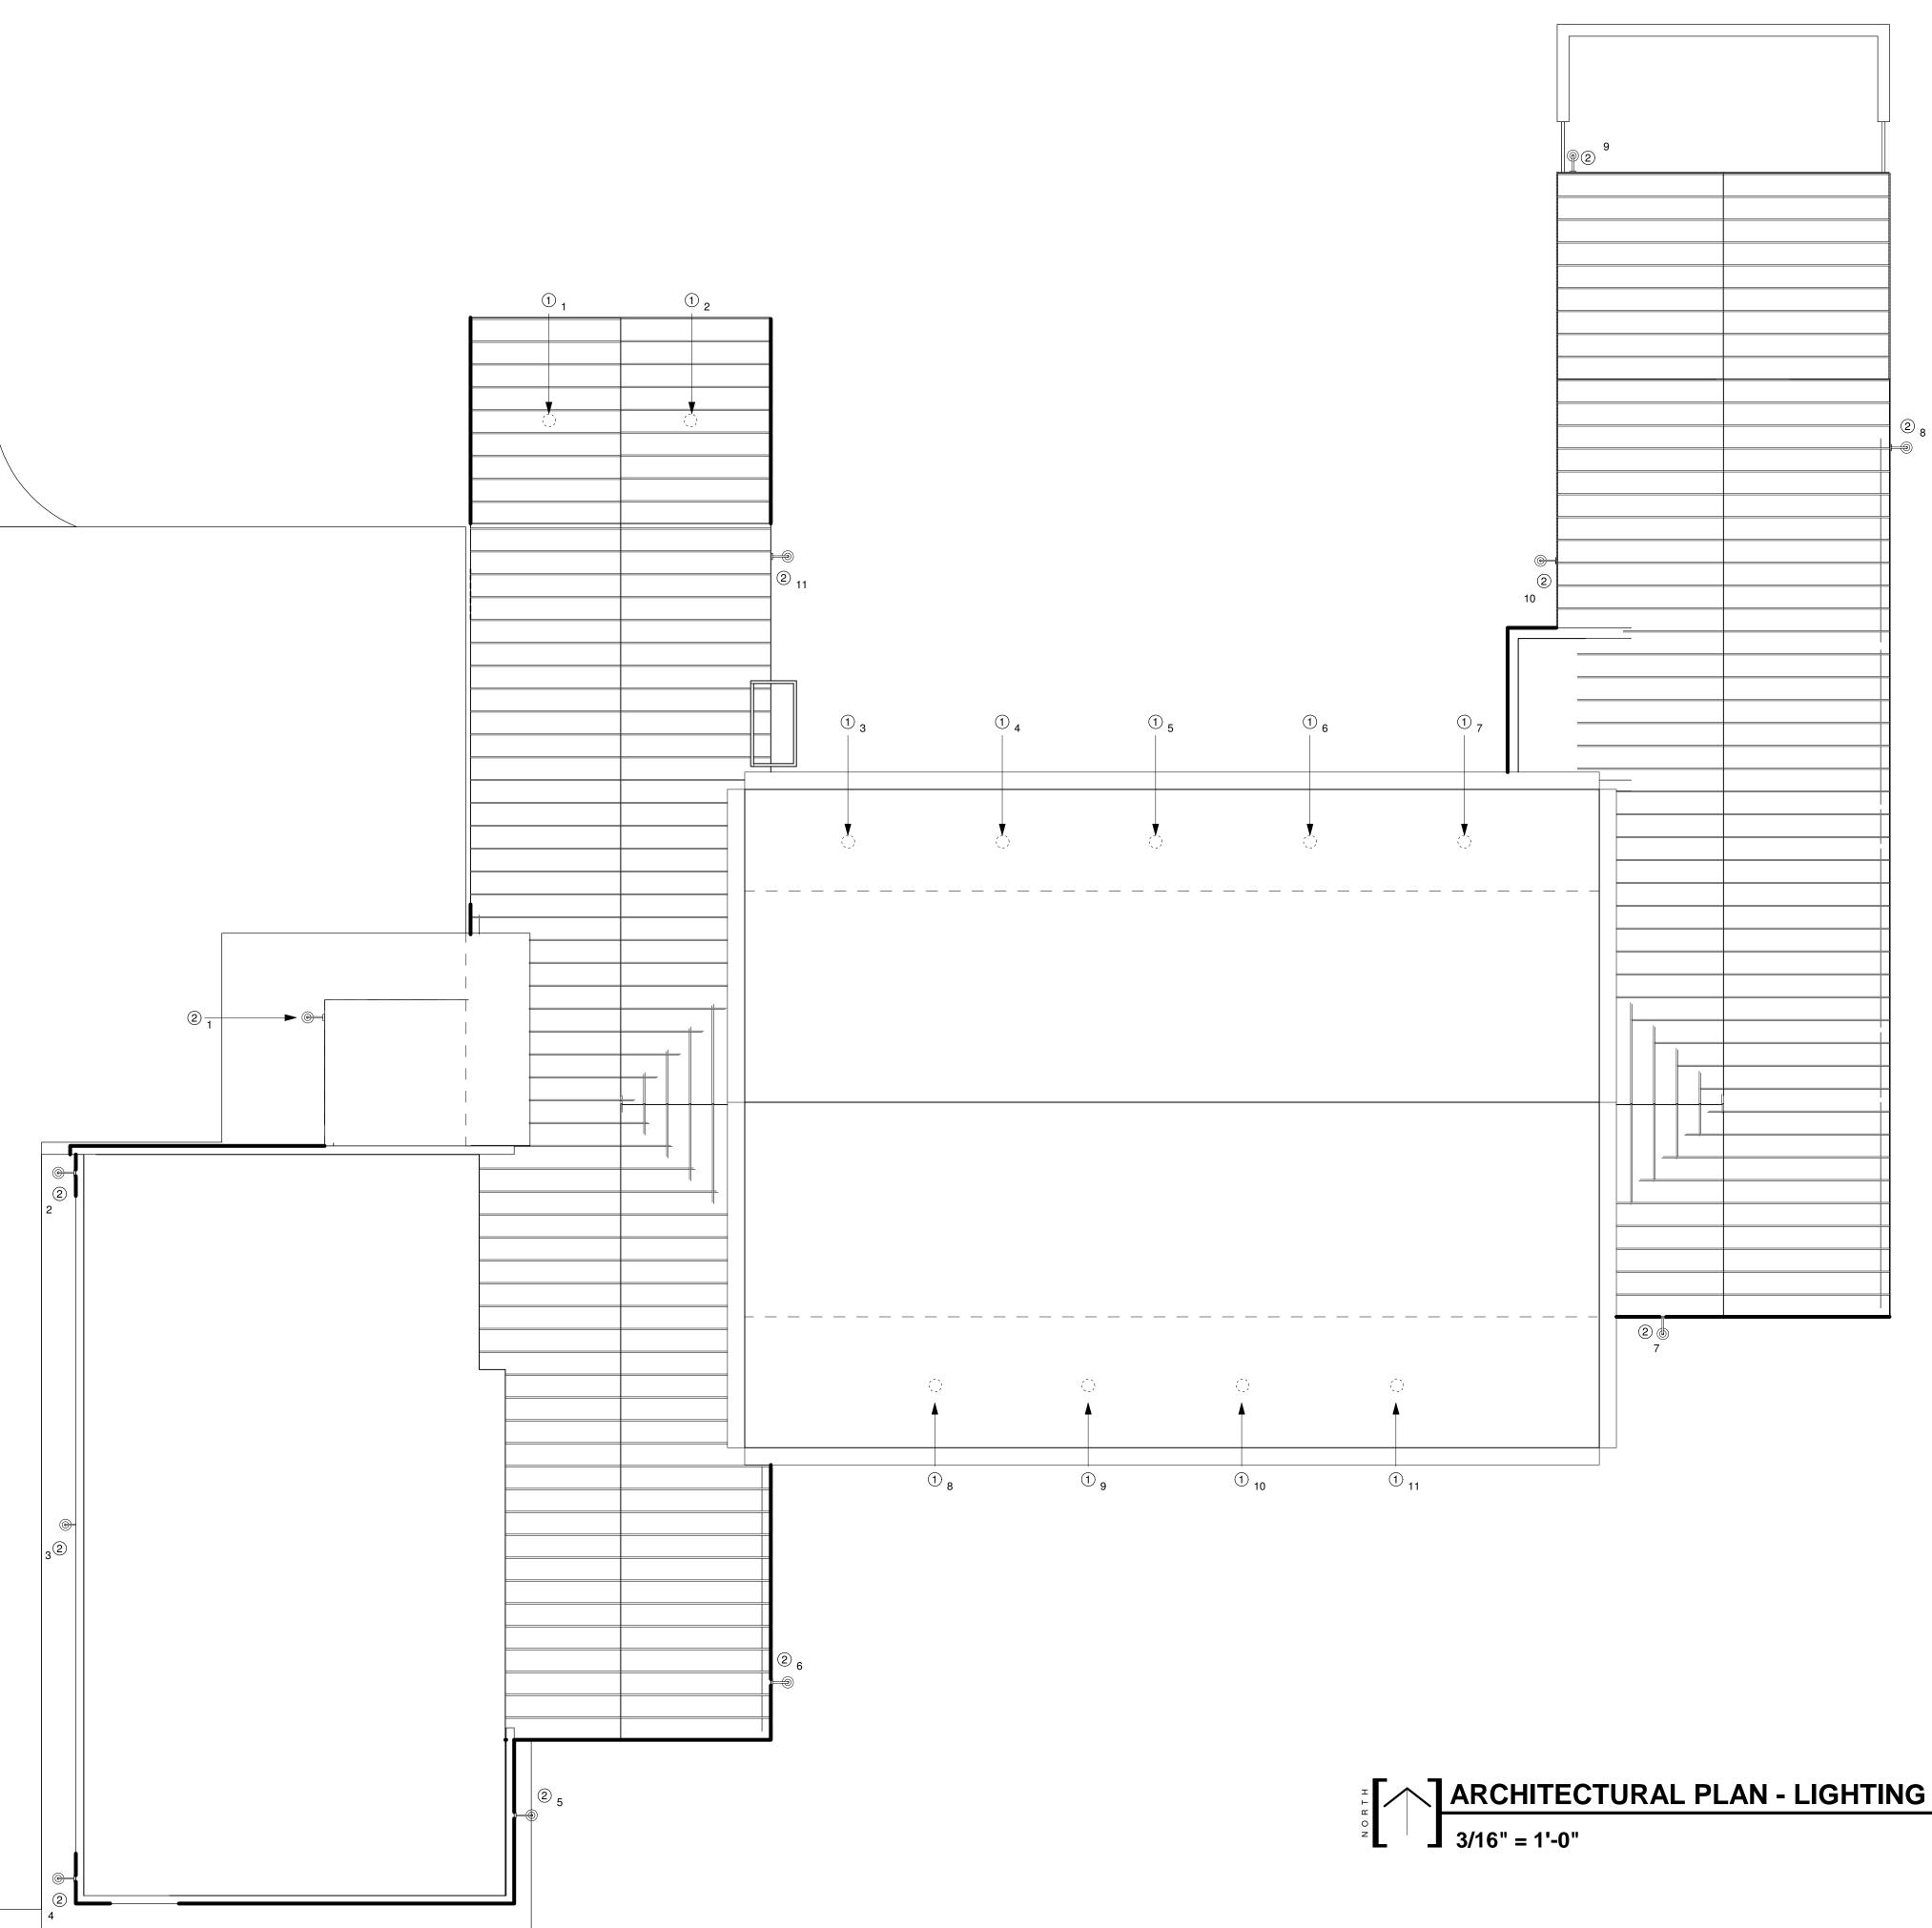

 $[\]frac{1}{2} \int \frac{\text{ARCHITECTURAL PLAN - LIGHTING}}{3/16" = 1'-0"}$


ARCHITECTURE | PLANNING | DESIGN

SYMBOL LEGEND 1 - (11) CAN LIGHT (TYP) - 🗋 (SYMBOL) - EXTERIOR UNDERMOUNT CAN LIGHT AT EXTERIOR COVERED PATIO LOCATIONS - PROGRESS LIGHTING - BLACK FINISH - LRV = 5 (OR EQUIVALENT) - 725 LUMENS - 3000 KELVIN 2 - (11) SCONCE LIGHT - (SYMBOL) - EXTERIOR WALL MOUNTED SCONCE LIGHT AT DOOR LOCATIONS -MODERN FARMS - DOUBLE DOWN OUTDOOR WALL SCONCE -BLACK FINISH - LRV = 5 - 275 LUMENS MAX. - 3000 KELVIN NOTE: SEE MATERIAL BOARD SHEET A0.6 FOR EXTERIOR WALL LIGHT BRAND, COLOR, AND FINISH. LRV = 5. FOR: HILLSIDE REVIEW REV # DATE CAMELBACK ESTATE LIGHTING PLAN 19-12 Project number 4/08/2020 Date DJB Drawn by DJB Checked by A1.1c

3/16" = 1'-0"

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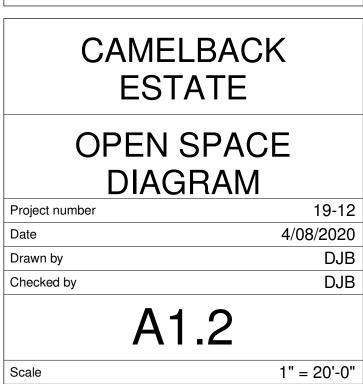
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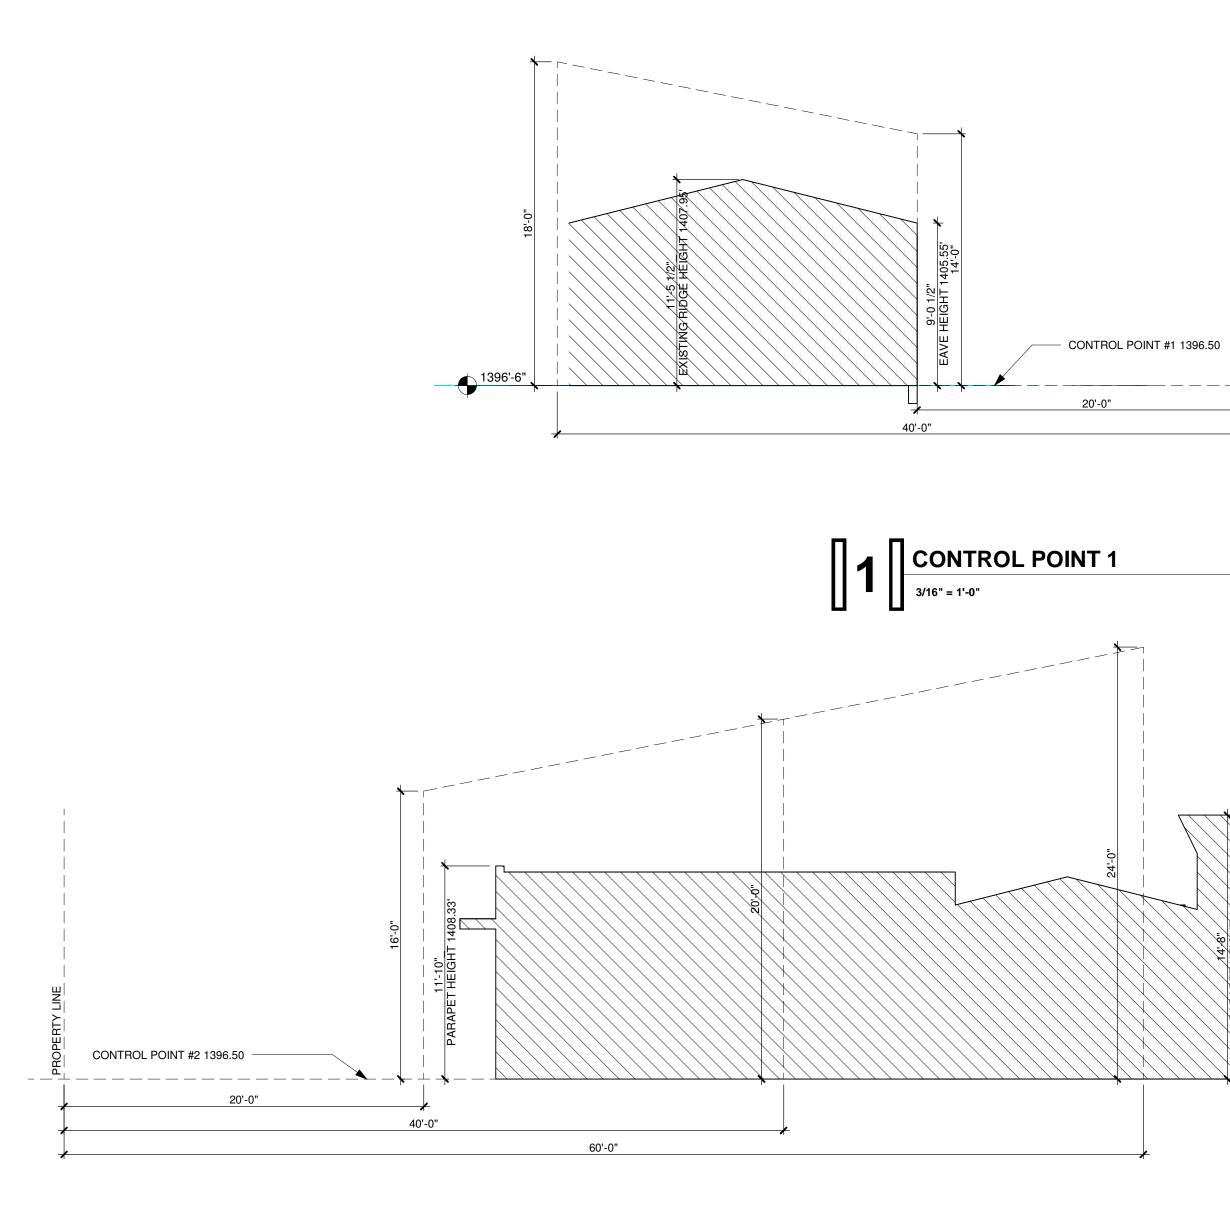


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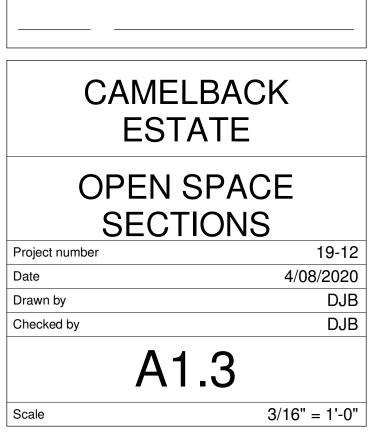


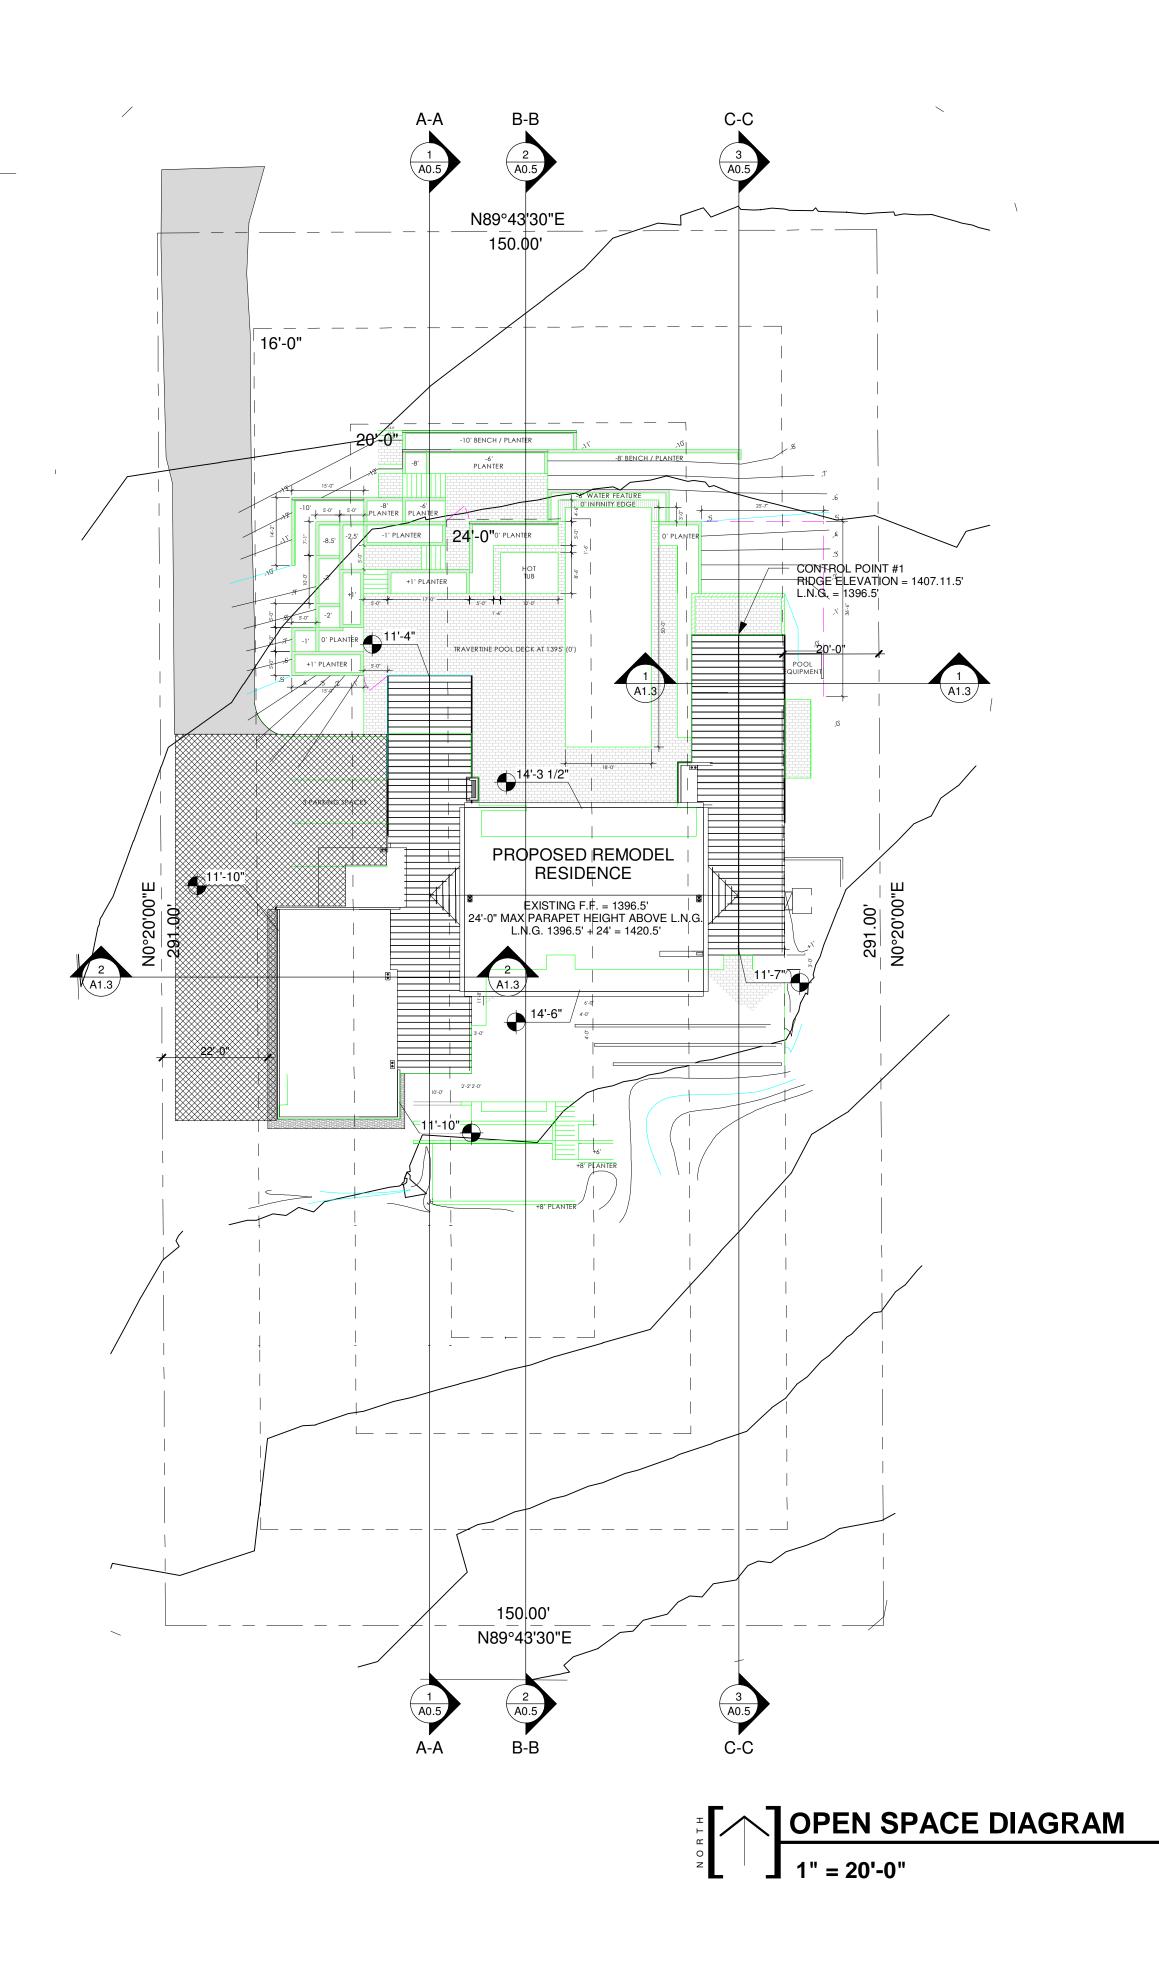
1396'-6"

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WALL LEGEND	
FRAME CONSTRUCTION	
STONE OR TILE VENEER	
EXISTING WALL TO REMAIN SYMBOL LEGEND	
WATER CLOSET. 1.5 GALLONS PER FLUSH MAXIMUM	
LAVATORY, LOW FLOW	

WINDOW NOTES

- W-1 EACH SLEEPING ROOM SHALL HAVE AT LEAST ONE OPENABLE OR EXTERIOR WINDOW OR DOOR FOR EMERGENCY ESCAPE OR RESCUE. THE OPENING SHALL PROVIDE A MIN. OF 5.7 S.F. OF NET CLEAR OPENING. THE OPENING SHALL PROVIDE A MIN. OF 24" CLEAR OPENING HEIGHT AND 20" CLEAR OPENING WIDTH. WHERE
- WINDOWS ARE PROVIDED AS A MEANS OF ESCAPE OR RESCUE, THE FINISH SILL HEIGHT SHALL NOT EXCEED 44" ABOVE FINISH FLOOR. W-2 PRIMARY WINDOWS (BEDROOMS, LIVING, ETC.) SHALL BE
- RECESSED MIN 6" TO FACE OF GLASS W-3 SECONDARY WINDOWS (BATHROOMS, CLOSETS, ETC.)
- SHALL BE RECESSED MIN. 4". W-4 DIVIDED LIGHTS SHALL BE TRUE DIVIDED OR SIMULATED LIGHT W/ EXTERNAL MUNTINS ON EACH SIDE OF GLASS WITH SHADOW BAR BETWEEN PANES. GLAZING SHALL BE LOW-E COATED CLEAR GLASS.

KEYNOTES

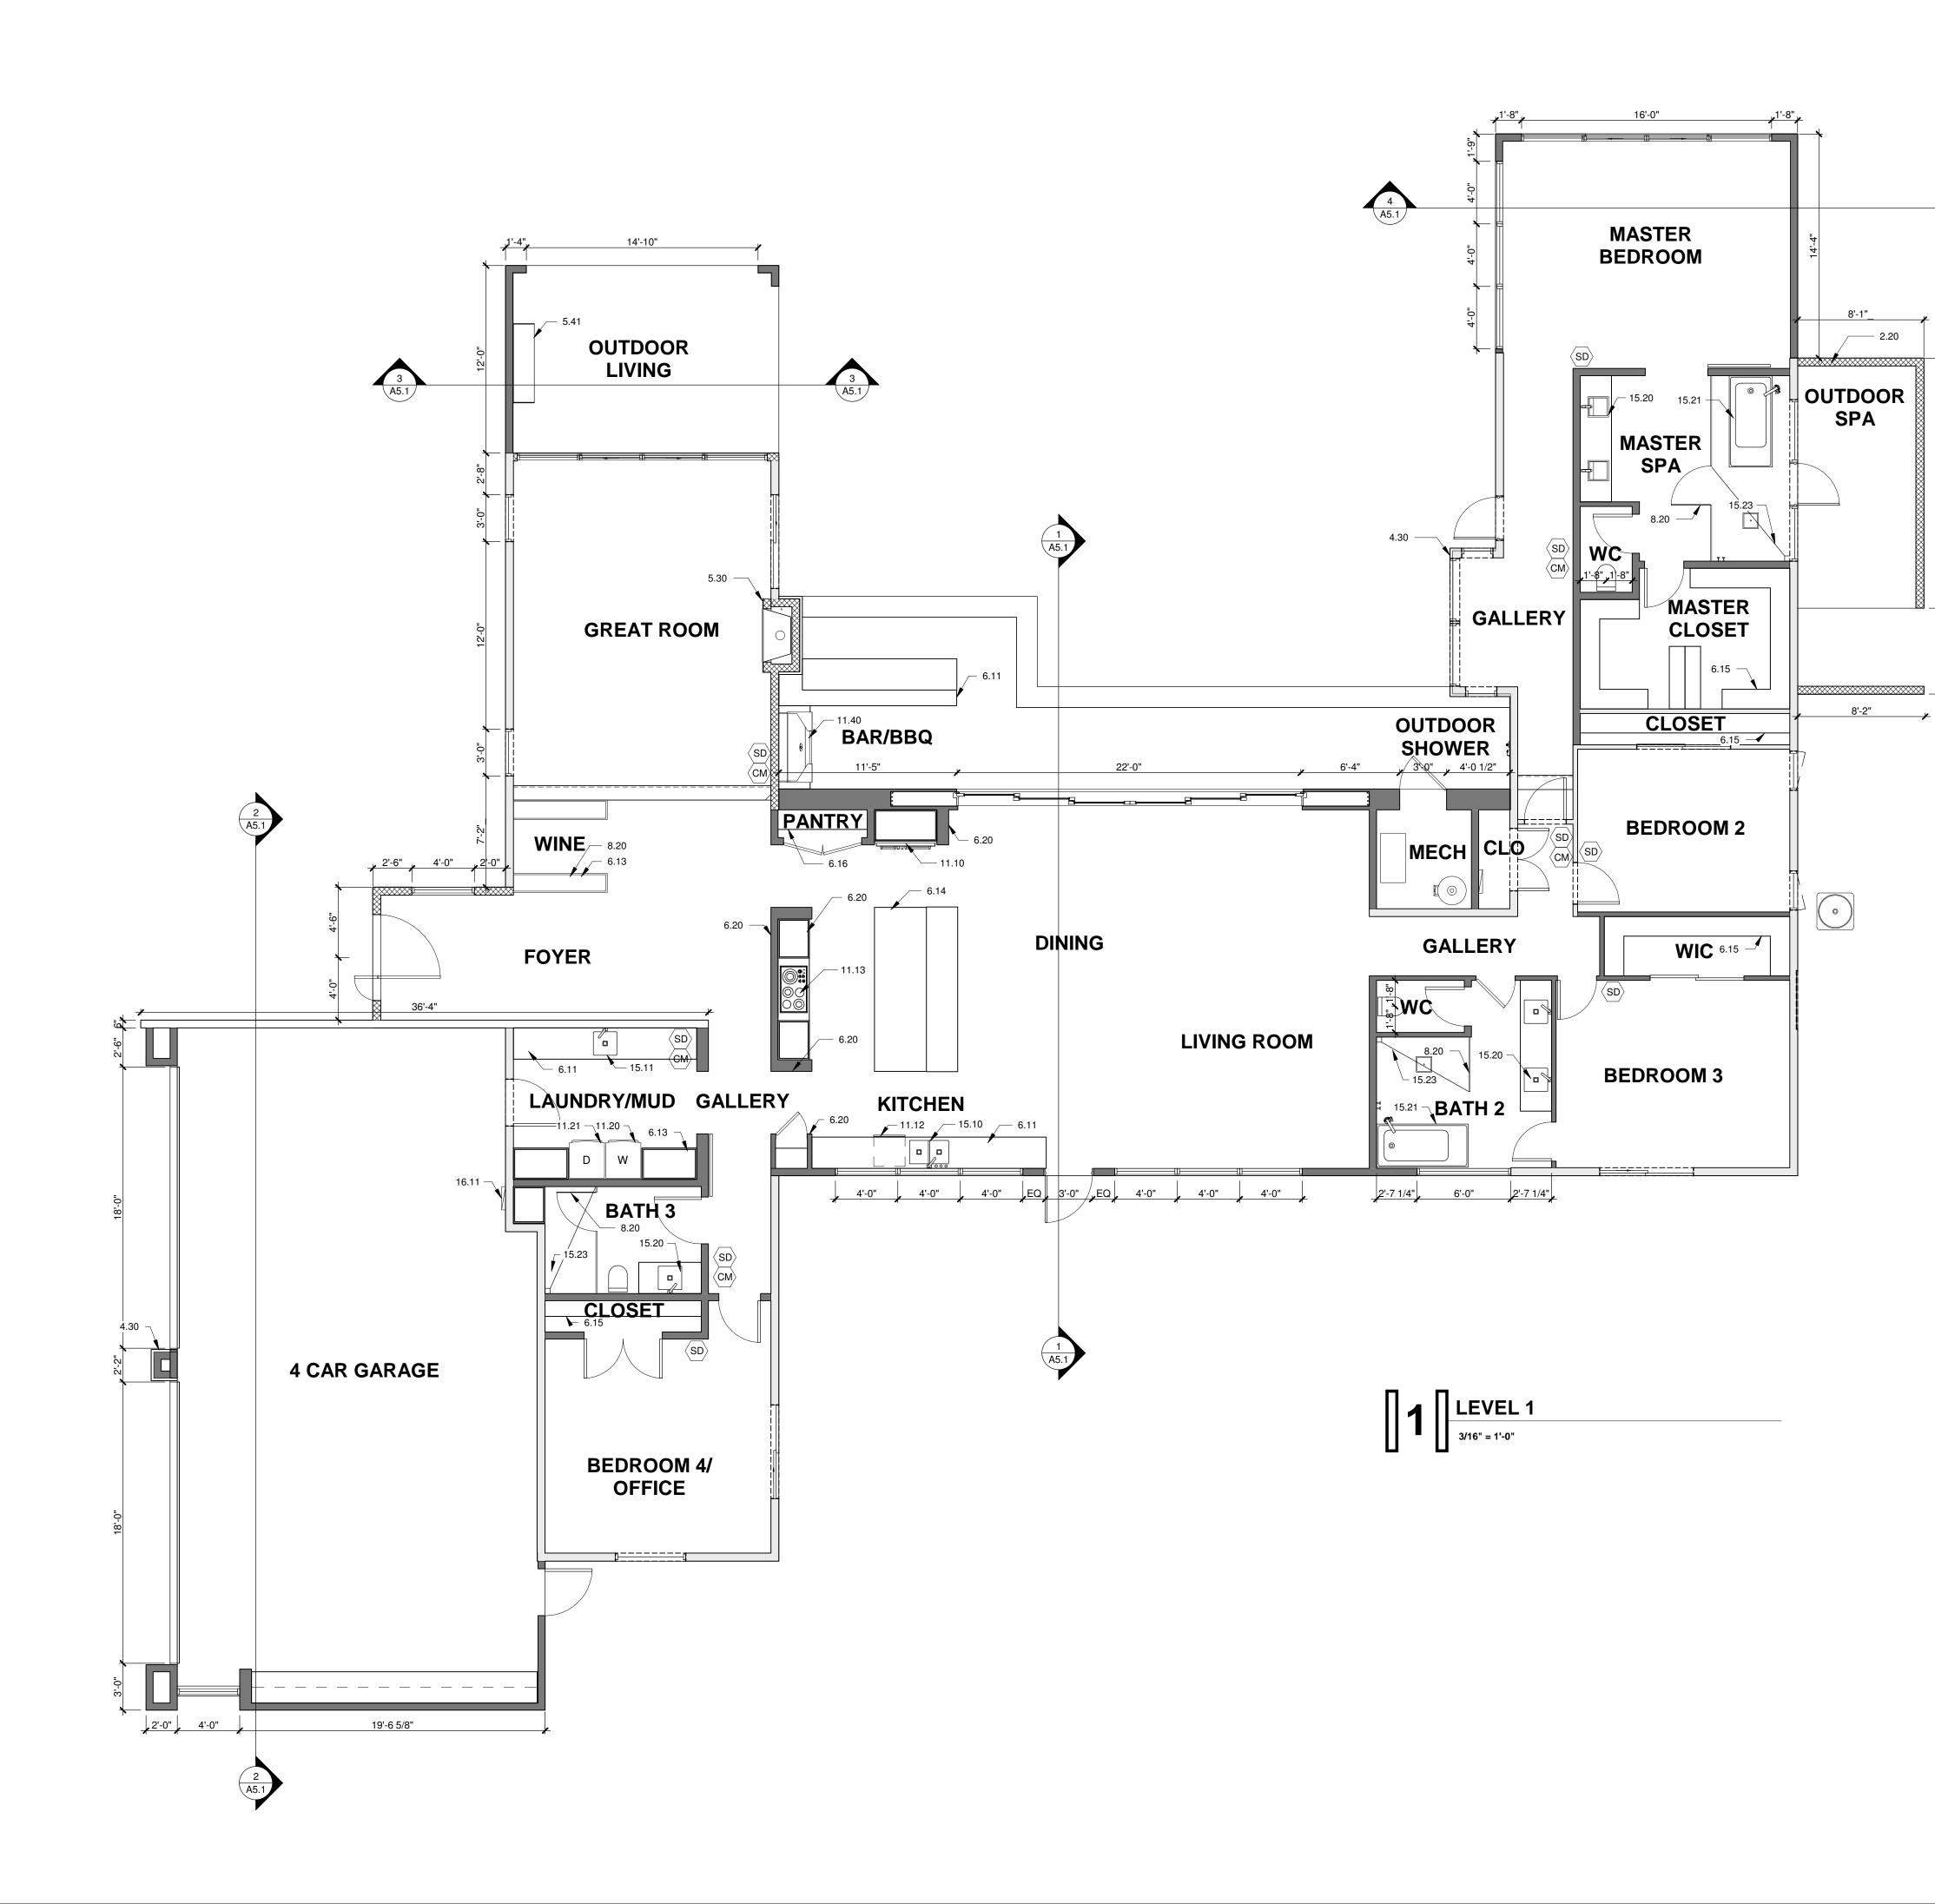	ILL INOTEO
2.20	SITE WALL, VERIFY HEIGHT WITH LANDSCAPE
4.30	STONE VENEER
5.30	ORNAMENTAL METAL
5.41	1/2" PLATE STEEL
6.11	LOWER MILLWORK
6.13	FULL HEIGHT MILLWORK
6.14	FREE STANDING MILLWORK
6.15	WARDROBE MILLWORK
6.16	GENERAL STORAGE MILLWORK
6.20	CUSTOM MILLWORK
8.20	TEMPERED GLASS
11.10	REFRIGERATOR - STUB OUT FOR WATER
11.12	DISHWASHER
11.13	COOKTOP/RANGE
11.20	WASHING MACHINE
11.21	DRYER
11.40	GAS GRILL
15.10	SINK WITH DISPOSAL
15.11	UTILITY SINK
15.20	BATHROOM SINK
15.21	BATHTUB
15.23	SHOWER (WATER RESISTANT FINISH UP TO 72" MINIMUM) SLOPE TO DRAIN, REFER TO INTERIOR DESIGNER SPECIFICATIONS
16.11	ELECTRICAL SUB-PANEL (FLUSH MOUNT)

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GENERAL NOTES G-1 WHERE THE HIGHEST POINT OF A CEILING IN A ROOM THAT OPENS TO THE HALLWAY SERVING THE BEDROOMS EXCEEDS THAT OF THE OPENING INTO THE HALLWAY BY 24" OR MORE, SMOKE DETECTORS SHALL BE INSTALLED IN THE HALLWAY AND IN THE ADJACENT ROOM. PROVIDE ADD'L S.D.'S AS APPLICABLE. G-2 ALL EXITS SHALL BE OPENABLE FROM THE INSIDE WITHOUT A KEY OR SPECIAL KNOWLEDGE. G-3 MANUALLY OPERATED EDGE OR SURFACE MOUNTED FLUSH BOLTS AND SURFACE BOLTS ARE PROHIBITED. G-4 PERP. DISTANCE FROM THE FIREPLACE OPENING TO COMBUSTIBLE WALLS SHALL CONFORM TO THE I.C.C./N.E.R. REPORT. G-5 HEARTH EXTENSIONS: DECORATIVE NONCOMBUSTIBLE COMBUSTIBLE MATERIAL SHALL BE INSTALLED OVER A THERMAL RESISTIVE BARRIER WHICH COMPLIES WITH THE EVALUATION REPORT AND MFR'S WRITTEN INSTALLATION MANUAL. G-6 ALL PRODUCTS LISTED BY I.C.C. NUMBERS SHALL BE INSTALLED PER THE REPORT AND MFR'S WRITTEN WRITTEN INSTRUCTIONS. PRODUCT SUBSTITUTION(S) FOR ITEM(S) LISTED SHALL ALSO HAVE I.C.C. APPROVED EVALUATION REPORT(S) OR BE APPROVED AND LISTED BY OTHER NAT. TESTÈD AGENCIES. G-7 ALL GLASS IN HAZARDOUS LOCATIONS AND ALL GLASS G-7 ALL GLASS IN HAZARDOUS LOCATIONS AND ALL GLASS WITHIN 18" OF FLOOR (EXCEPT SINGLE PANES WITH 9 S.F. OR LESS AREA SHALL BE SAFETY GLASS (SECT. 5406) G-8 GAS LINES: A. NOT ALLOWED UNDER STRUCT(S). B. NOT ALLOWED UNDER SLAB(S). C. SHALL CONFORM TO ALL CURRENT CODES G-9 PROVIDE 5/8" TYPE "X" GYPSUM BOARD AT ALL WALLS AND CEILING OF GARAGE UNLESS SPECIFICALLY G-11 AT OUT-SWINGING DOORS, PROVIDE LANDING NOT LOWER THAN - 4 INCHES BELOW TOP OF DOOR THRESHOLD, PER R311.4.3 AMENDED. THE WIDTH OF EACH LANDING SHALL NOT BE LESS THAN THE DOOR SERVED. EVERY LANDING SHALL HAVE A MIN. DIMENSION OF 36" MEASURED IN THE DIRECTION OF TRAVEL. G-12 ATTIC ACCESS OPENINGS SHALL NOT BE LESS THAN 22"x30" AND SHALL PROVIDE A MIN. OF 30" HEADROOM AND SHALL BE LOCATED IN A HALLWAY OR READILY ACCESSIBLE SPACE PER IRC R807. G-13 ALL MECH. EQUIPMENT (AIR COND., POOL EQUIP., ETC. SHALL BE SCREENED A MIN. OF 1'-0" ABOVE THE HIGHEST PORTION OF THE EQUIP. FROM ALL SIDES AND SHALL BE COMPATIBLE WITH THE ADJACENT BUILDING. SEE FLOOR PLAN AND SITE PLAN FOR LOCATION OF EQUIP. G-14 UNLESS SHOWN OTHERWISE, POSITION DOOR JAMBS 6 OFF THE WALL CONSTRUCTION AND/OR DESIGNATED DETAIL. G-15 WATER RESISTANT GYPSUM BOARD SHALL NOT BE INSTALLED OVER A VAPOR RETARDER IN A SHOWER OR TUB COMPARTMENT. ALSO INCLUDES AREA SUBJECT TO CONT. HIGH HUMIDITY. CEMENT, FIBER-CEMENT OR GLASS MAT GYPSUM BACKERS INSTALLED IN ACCORDANCE WITH MFR'S RECOMMENDATIONS SHALL BE USED AS BACKERS FOR WALL TILE IN TUB AND SHOWER AREAS AND WALL PANELS IN SHOWER AREAS. (R702.4.2) FOR: SCHEMATIC DESIGN REV # DATE CAMELBACK ESTATE FLOOR PLAN


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19-12 4/08/2020 DJB DJB A2.1

As indicated



MATERIAL LEGEND TONGUE & GROOVE - SIZE: T.B.D. SHERWIN WILLIAMS - HAWTHORNE - SW3518 APPROX LRV = 20 (OR EQUIVALENT) GYP. BD. - U.N.O. STUCCO TO COMPLY WITH G1 -SHERWIN WILLIAMS - NOR'EASTER - HGSW1444 LRV = 32 (OR EQUIVALENT) ESR #1607 **NOTE: REFER TO LIGHTING LAYOUT FOR CEILING FIXTURE LOCATIONS

4 A5.1

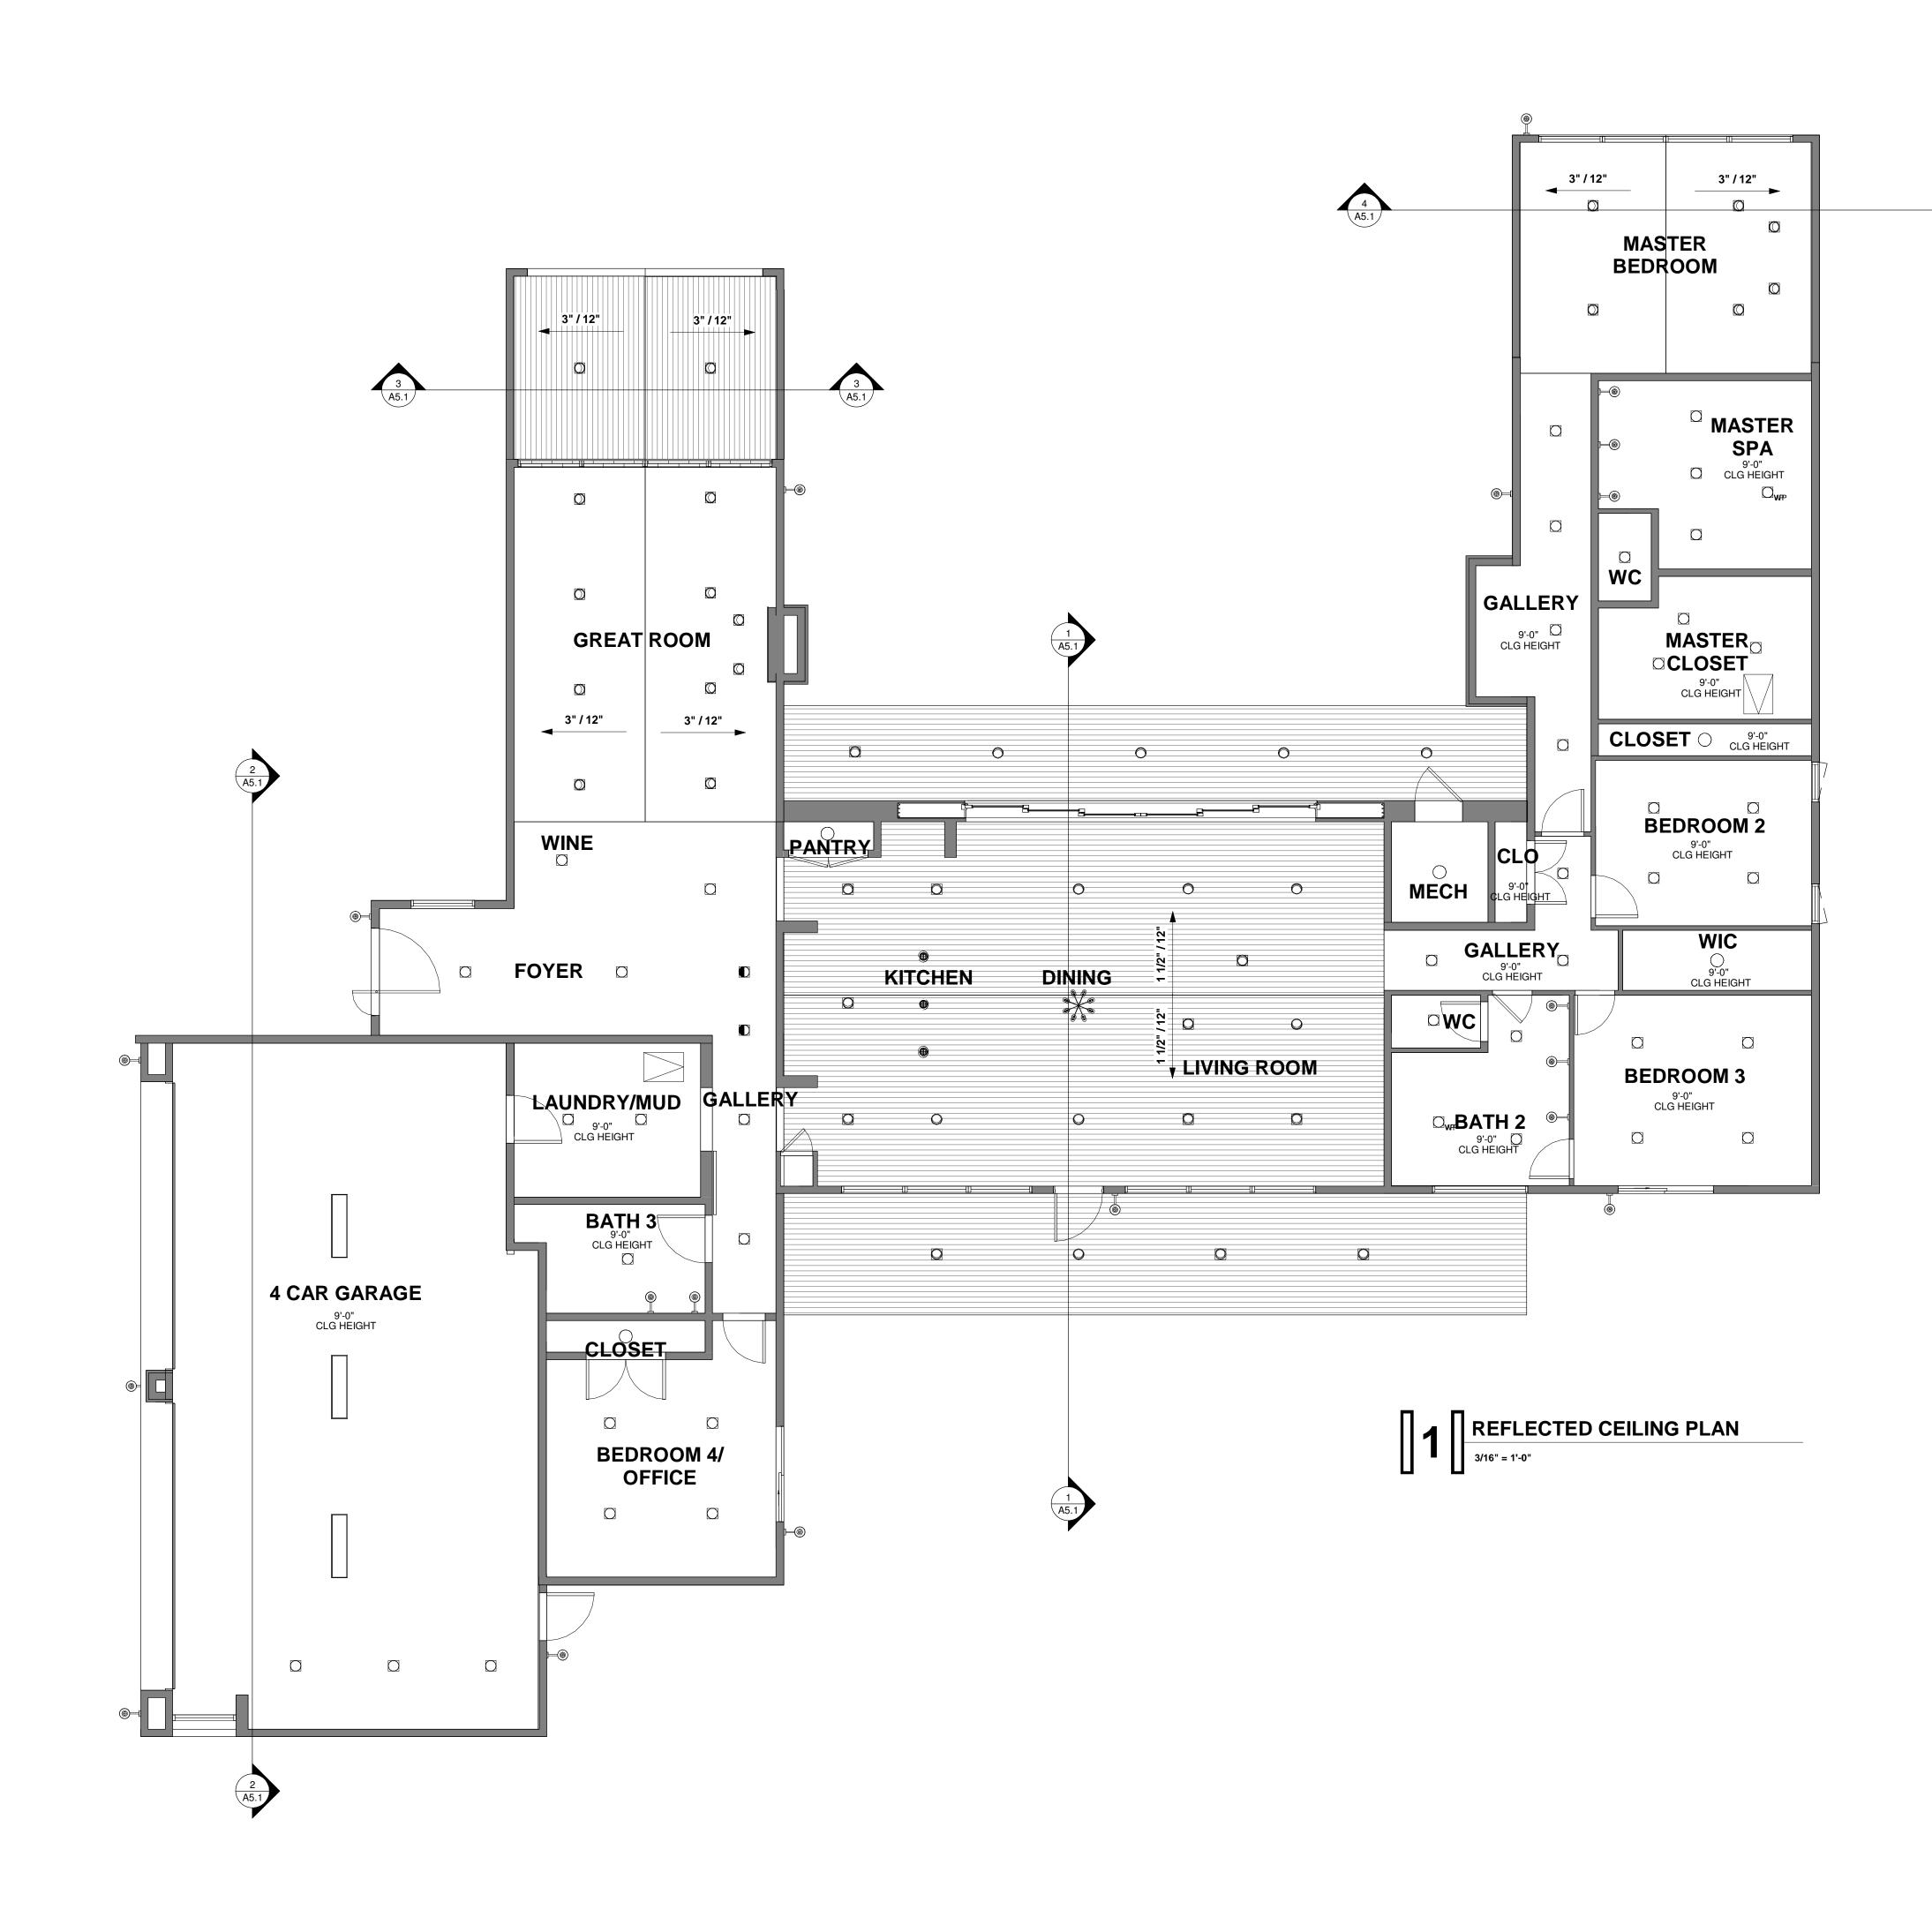
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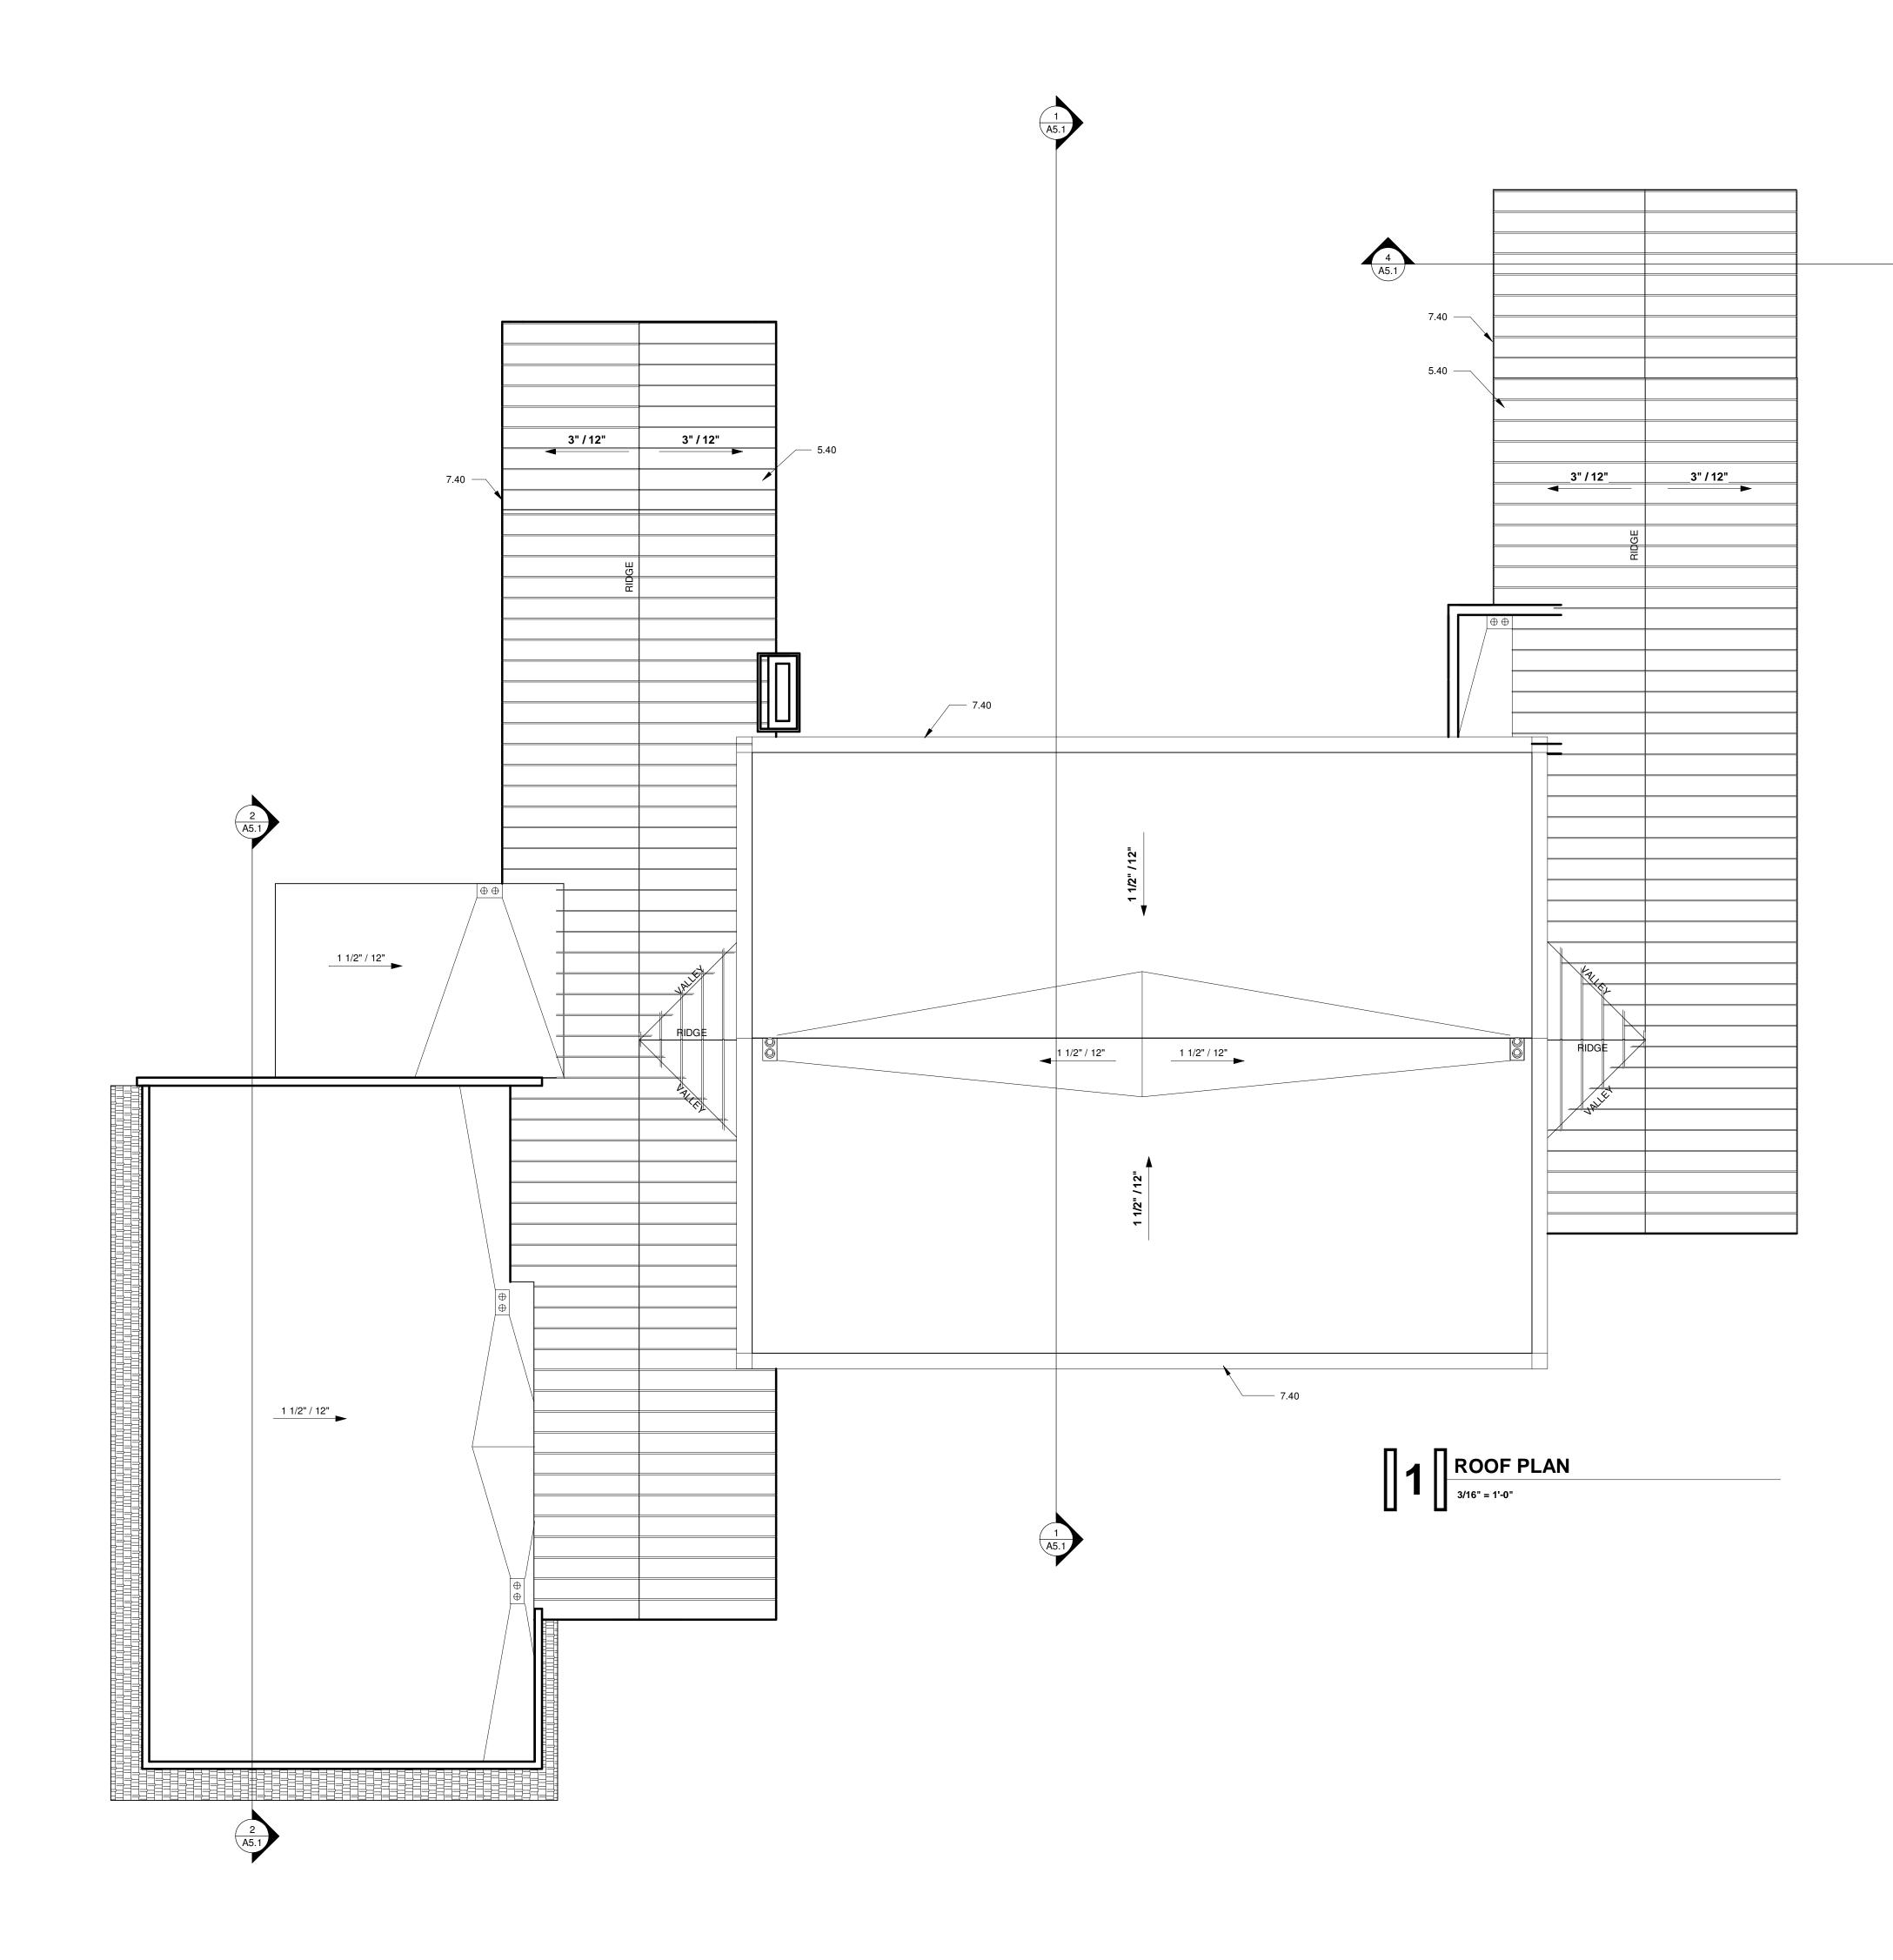
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FOR: HILLSIDE REVIEW



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KEYNOTES

5.40 STEEL ROOFING 7.40 METAL FASCIA -MBCI METAL ROOFING AND METAL FASCIA -MIDNIGHT BRONZE - LRV = 7 (OR EQUIVALENT) NOTE:

> PAINT ALL FLAT AREAS OF ROOF SHERWIN WILLIAMS - NOR'EASTER LRV = 32 (OR EQUIVALENT)
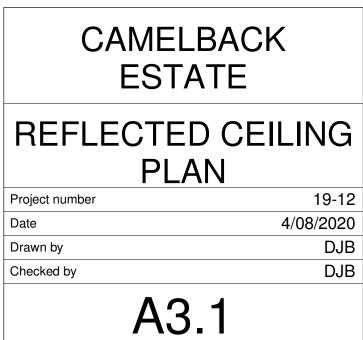
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GENERAL NOTES

- G-1 SEE ROOF FRAMING PLAN FOR SHEATHING REQUIREMENTS.
- G-2 EXTEND FOAM UP VERTICAL WALL SURFACES AS REQUIRED BY MFR.
- G-3 PROVIDE FLASHING AND COUNTER-FLASHING AT ALL EDGES OF EXTERIOR WALL FINISH SYSTEM ADJACENT TO ROOF MATERIAL.

G-4 PROVIDE A 6" OVERFLOW DRAIN (2'-0" MEASURED HORIZONTALLY) AND SHALL DISCHARGE TO AN APPROVED LOCATION AND SHALL NOT BE CONNECTED TO ROOF DRAIN LINES. OVERFLOW DRAIN TO BE 2" ABOVE THE LOWEST ADJACENT ROOF HEIGHT. PROVIDE STRAINERS AT INLETS AS REQUIRED. STRAINERS SHALL EXTEND NOT LESS THAN 4" ABOVE SURFACE OF ROOF AND SHALL HAVE A MINIMUN INLET AREA 1 1/2 TIMES THE PIPE TO WHICH IT IS CONNECTED.

- G-5 GALV. FLASHING IN ALL VALLEYS, 8" EACH WAY AND AT ALL PARAPETS.
- G-6 GALV. FLASH AT WALLS ABOVE ROOF.
- G-7 SINGLE PLY ROOF FINISH COAT SHALL BE COLORED TO MATCH BODY OF HOUSE.
- G-8 ALL ROOF VENTS AND EQUIPMENT MUST BE PAINTED TO MATCH BODY OF HOUSE.

G-9 BITUTHANE AT TOPS OF ALL PARAPETS & ALL HORIZ. STUCCO SURFACES. ATTIC VENTILATION

NOT REQUIRED PER I.R.C. 806.4: CONDITIONED ATTIC REQUIRES NO VENTILATION- FASTEN INSULATION TO INSIDE FACE OF EXTERIOR SHEATHING AT TRUSS & TRUSS FRAMING MEMBERS

SYMBOL LEGEND

 $\stackrel{\oplus}{\oplus}$

6" OVERFLOW DRAIN (2'-0" MEASURED HORIZONTALLY) AND SHALL DISCHARGE TO AN APPROVED LOCATION AND SHALL NOT BE CONNECTED TO ROOF DRAIN LINES. OVERFLOW DRAIN TO BE 2" ABOVE THE LOWEST ADJACENT ROOF HEIGHT. PROVIDE STRAINERS AT INLETS AS REQUIRED. STRAINERS SHALL EXTEND NOT LESS THAN 4" ABOVE SURFACE OF ROOF AND SHALL HAVE A MINIMUN INLET AREA 1 1/2 TIMES THE PIPE TO WHICH IT IS CONNECTED.

MATERIAL LEGEND STUCCO TO COMPLY WITH G1 LRV = 32

ESR #1607 STANDING SEAM METAL ROOFING COLOR = DARK BRONZE ANODIZED LRV = 7

METAL FASCIA COLOR = DARK BRONZE ANODIZED LRV = 7

TONGUE & GROOVE - SIZE: T.B.D. SHERWIN WILLIAMS - HAWTHORNE - SW3518 APPROX LRV = 20 (OR EQUIVALENT)

FOR: HILLSIDE REVIEW REV # DATE

CAMELBACK ESTATE


ROOF PLAN

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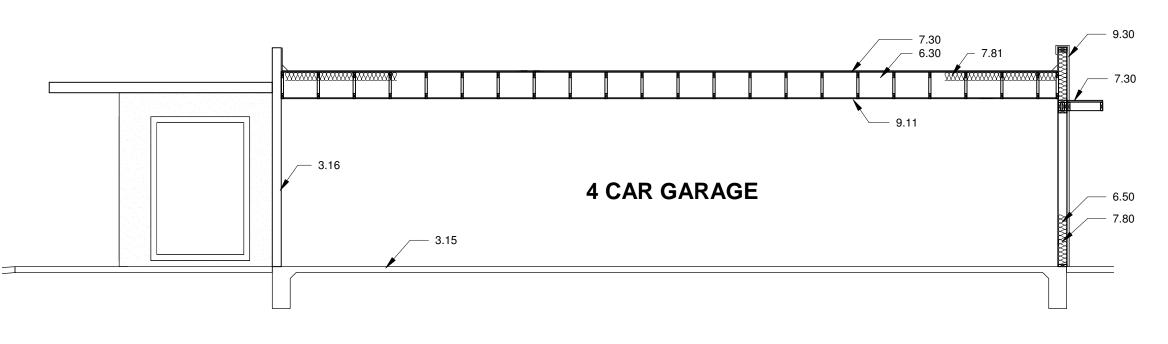
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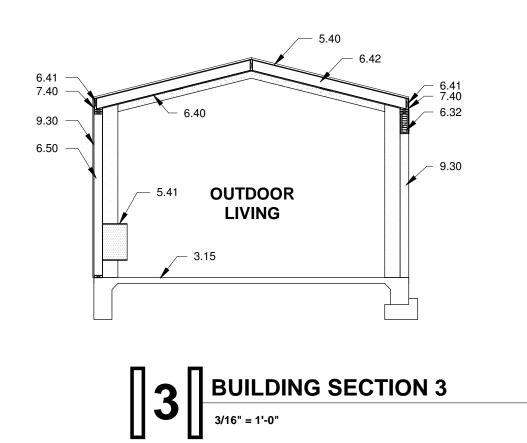
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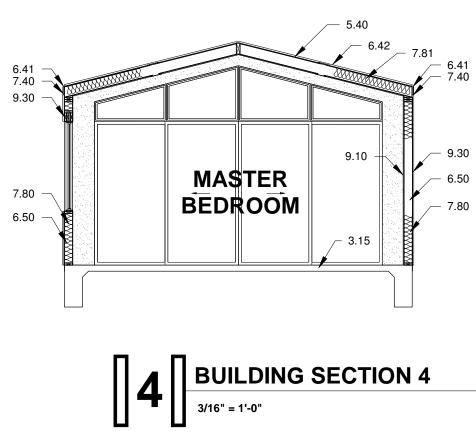








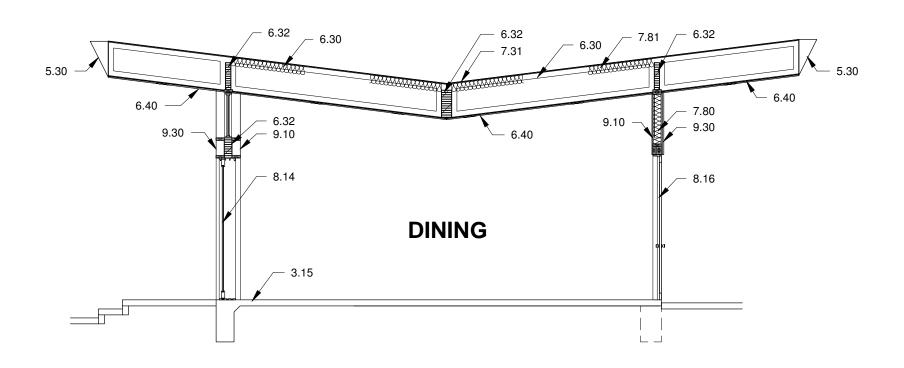





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KEYNOTES


	B PER STRUCTURAL	
	LL PER STRUCTURAL S	
5.40 STEEL ROOFING 5.41 1/2" PLATE STE	G EL	
6.32 LAMINATED BE/	D ROOF TRUSS AM IROOVE WOOD PLANK	
6.41 WOOD FASCIA 6.42 RAFTER 6.50 2X WOOD STUD	WALL	
7.30 CARLISLE TPO INSULATION	ROOFING AND EPS TAPERED	
7.40METAL FASCIA7.80WALL INSULATI	ON (R-19 MINIMUM)	
8.14 SLIDING GLASS 8.16 WOOD DOOR		
9.10GYPSUM BOAR9.11TYPE "X" GYPSU9.30STUCCO APPLIC	JM BOARD	
	MATIC DESIGN	
REV # DATE		
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BUILDING SECTIONS		
Project number	19-12	
Date Drawn by	01/29/2020 DJB	
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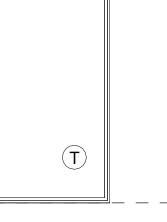



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ARCHITECTURE PLANNING DESIGN
GENERAL NOTES
G-1 MAG ONE-COAT STUCCO COMPLIANCE PROGRAM: ALL ONE-COAT STUCCO SYSTEMS SHALL BE APPLIED BY MFR. APPROVED INSTALLERS. AN APPROVED WEATHER
RESISTIVE BARRIER SHALL BE APPLIED OVER ALL FRAMING AND WOOD BASED SHEATHING. ONE-COAT STUCCO SYSTEM SHALL BE "WESTERN ONE KOTE"
STUCCO SYSTEM (ICC ESR #1607). THIS ONE-COAT STUCCO SYSTEM SHALL BE APPLIED OVER A WEATHER RESISTIVE BARRIER CONFORMING TO IRC R 703.9.
 G-2 PROVIDE WEATHER FLASHING/PROOFING AT EXTERIOR WALL PENETRATIONS, INCLUDING WINDOWS, DOORS AND VENTS PER R703.8 G-3 PAINT ALL UTILITARIAN METAL TO MATCH STUCCO U.N.O.
G-4 WEEP SCREED TO BE INSTALLED PER IRC R703.6.2.1 G-5 STUCCO/PLASTER FINISH MATERIAL TO BE INSTALLED PER IRC R703.6.2.
WINDOW NOTES
W-1 EACH SLEEPING ROOM SHALL HAVE AT LEAST ONE OPENABLE OR EXTERIOR WINDOW OR DOOR FOR EMERGENCY ESCAPE OR RESCUE. THE OPENING SHALL
PROVIDE A MIN. OF 5.7 S.F. OF NET CLEAR OPENING. THE OPENING SHALL PROVIDE A MIN. OF 24" CLEAR OPENING HEIGHT AND 20" CLEAR OPENING WIDTH. WHERE WINDOWS ARE PROVIDED AS A MEANS OF
ESCAPE OR RESCUE, THE FINISH SILL HEIGHT SHALL NOT EXCEED 44" ABOVE FINISH FLOOR. W-2 PRIMARY WINDOWS (BEDROOMS, LIVING, ETC.) SHALL BE
RECESSED MIN 6" TO FACE OF GLASS W-3 SECONDARY WINDOWS (BATHROOMS, CLOSETS, ETC.) SHALL BE RECESSED MIN. 4".
W-4 DIVIDED LIGHTS SHALL BE TRUE DIVIDED OR SIMULATED LIGHT W/ EXTERNAL MUNTINS ON EACH SIDE OF GLASS WITH SHADOW BAR BETWEEN PANES. GLAZING SHALL BE LOW-E COATED CLEAR GLASS.
NOTE: ALL DOOR FRAMES AND WINDOW FRAMES TO BE WESTERN WINDOWS AND DOORS, DARK BRONZE
ANODIZED COLOR WITH AN LRV NOTO TO EXCEED 38%, OR EQUIVALENT.
MATERIAL LEGEND
STUCCO TO COMPLY WITH G1 COLOR : SHERWIN WILLIAMS - NOR'EASTER LRV = 32
ESR #1607 STANDING SEAM METAL ROOFING COLOR = DARK BRONZE ANODIZED
COLOR = DARK BRONZE ANODIZED LRV = 7
TONGUE & GROOVE - SIZE: T.B.D. SHERWIN WILLIAMS - HAWTHORNE - SW3518 APPROX LRV = 20 (OR EQUIVALENT)
FOR: HILLSIDE REVIEW
REV # DATE
CAMELBACK
ESTATE
EXTERIOR
ELEVATIONSProject number19-12
Date 4/08/2020 Drawn by DJB
Checked by DJB
A6.1
Scale As indicated

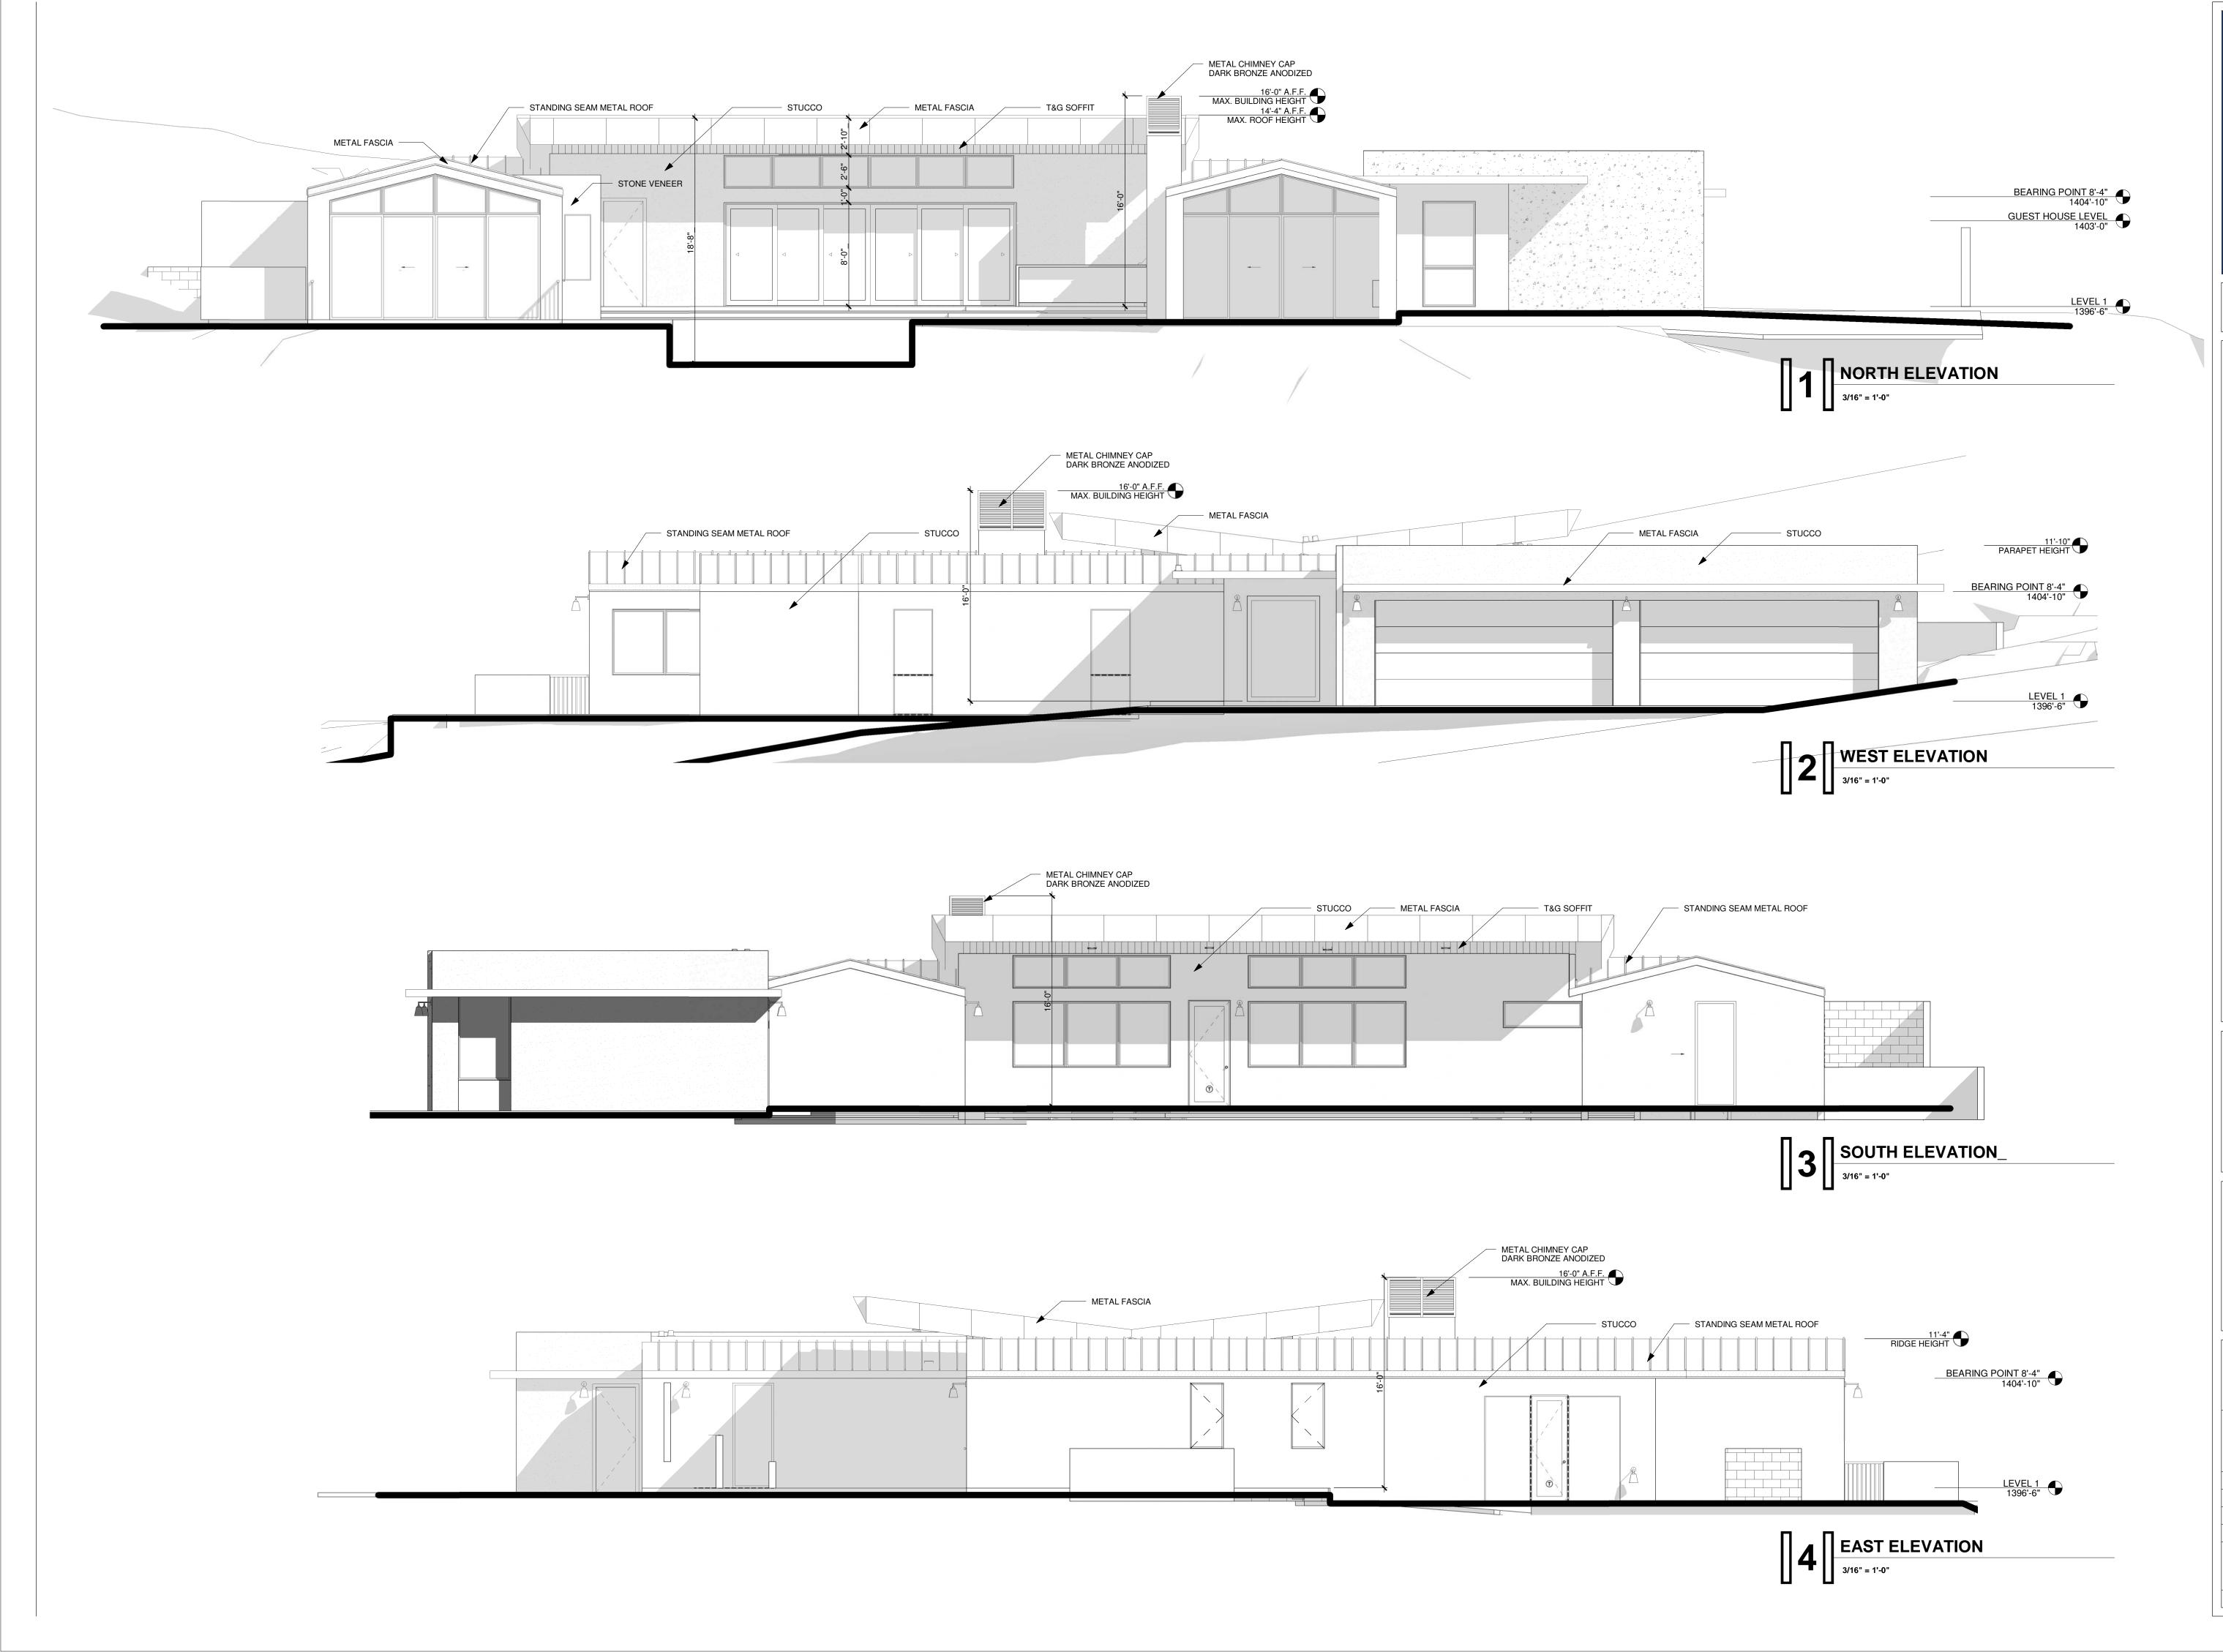


3/8" = 1'-0"

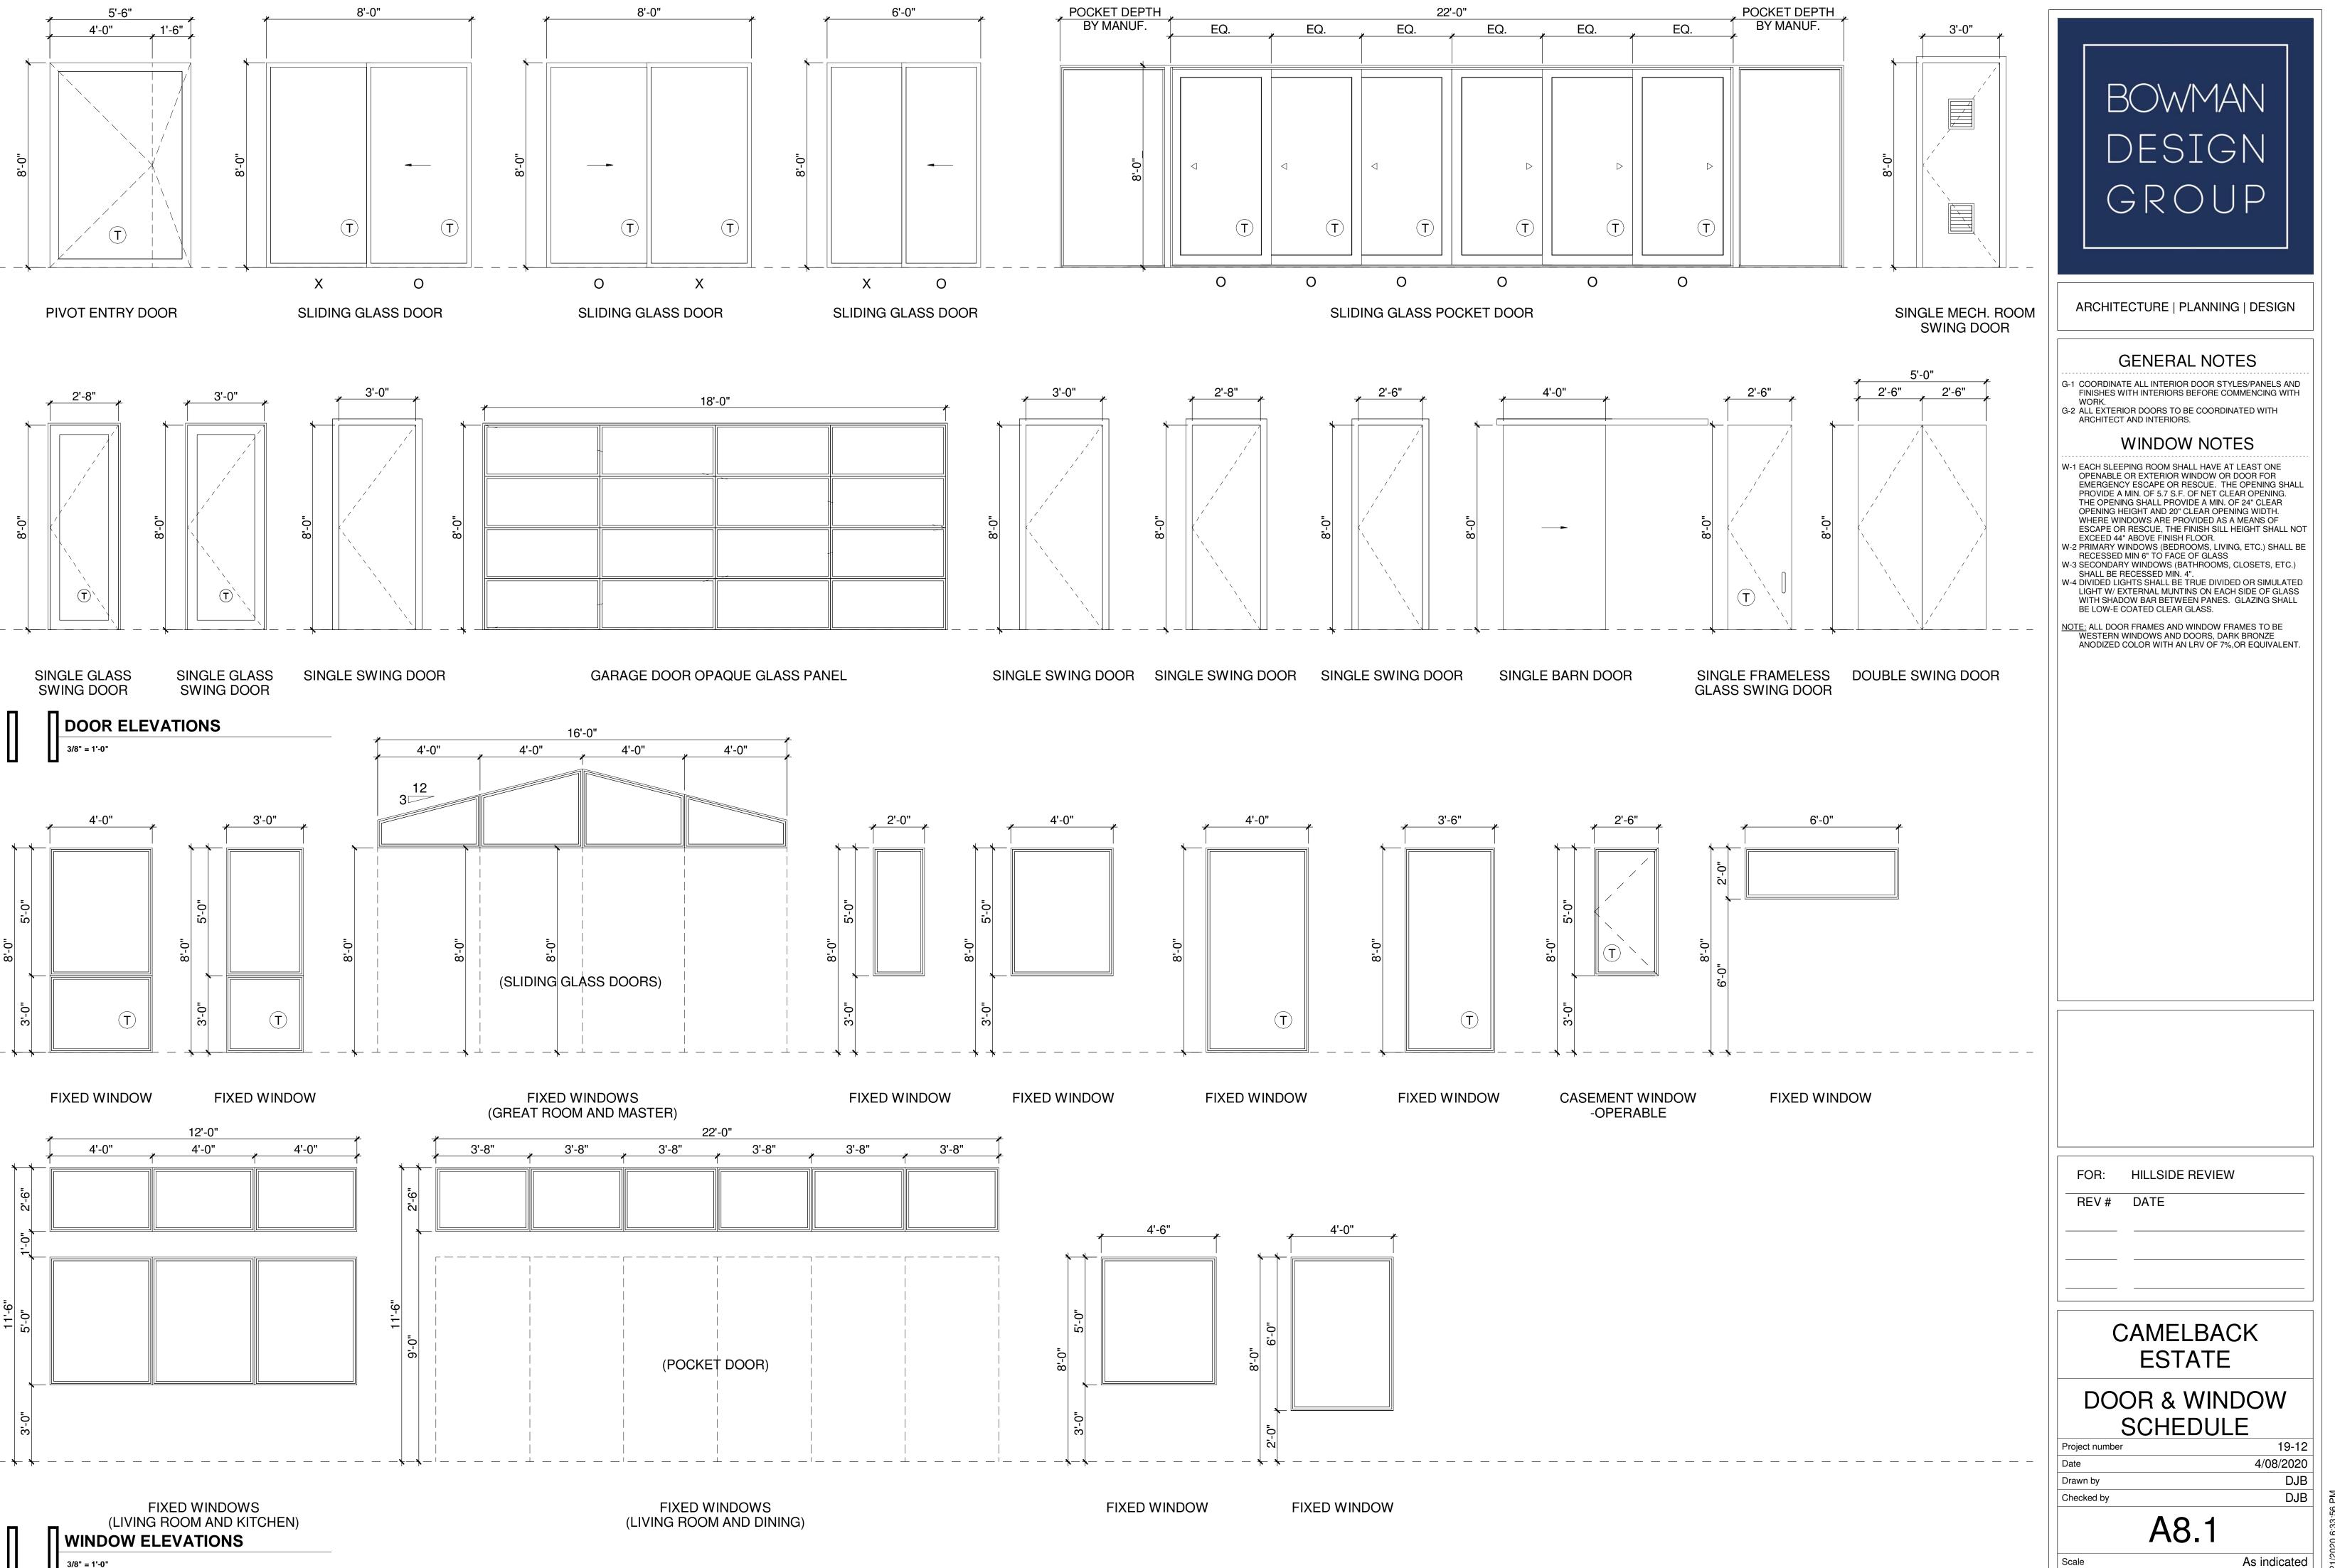


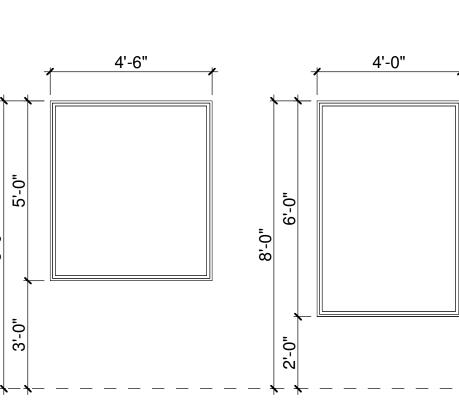


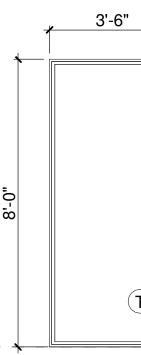

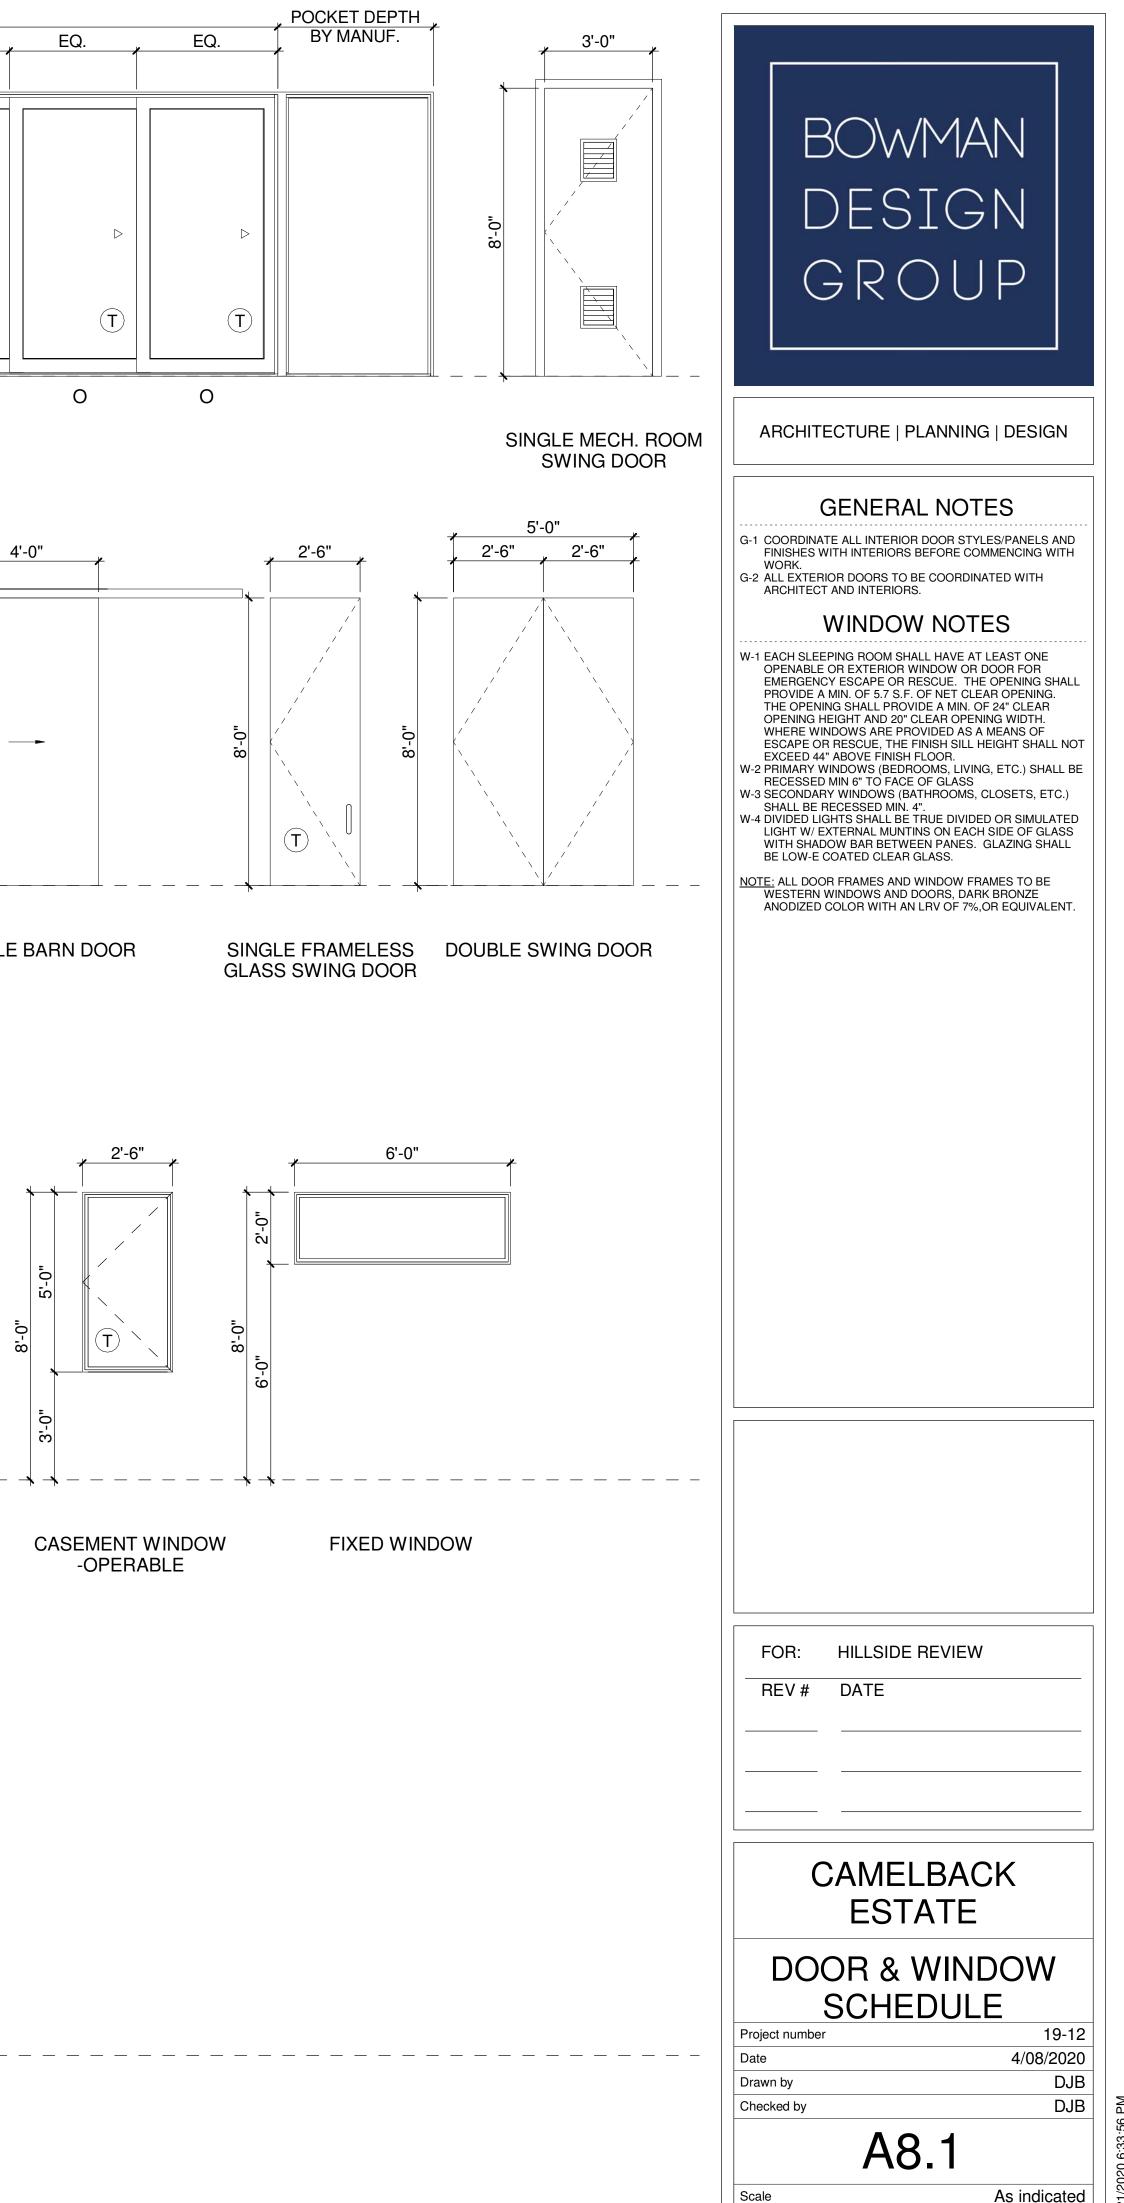

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16.10ELECTRICAL SERVICE ENTRANCE16.11ELECTRICAL SUB-PANEL (FLUSH MOUNT)

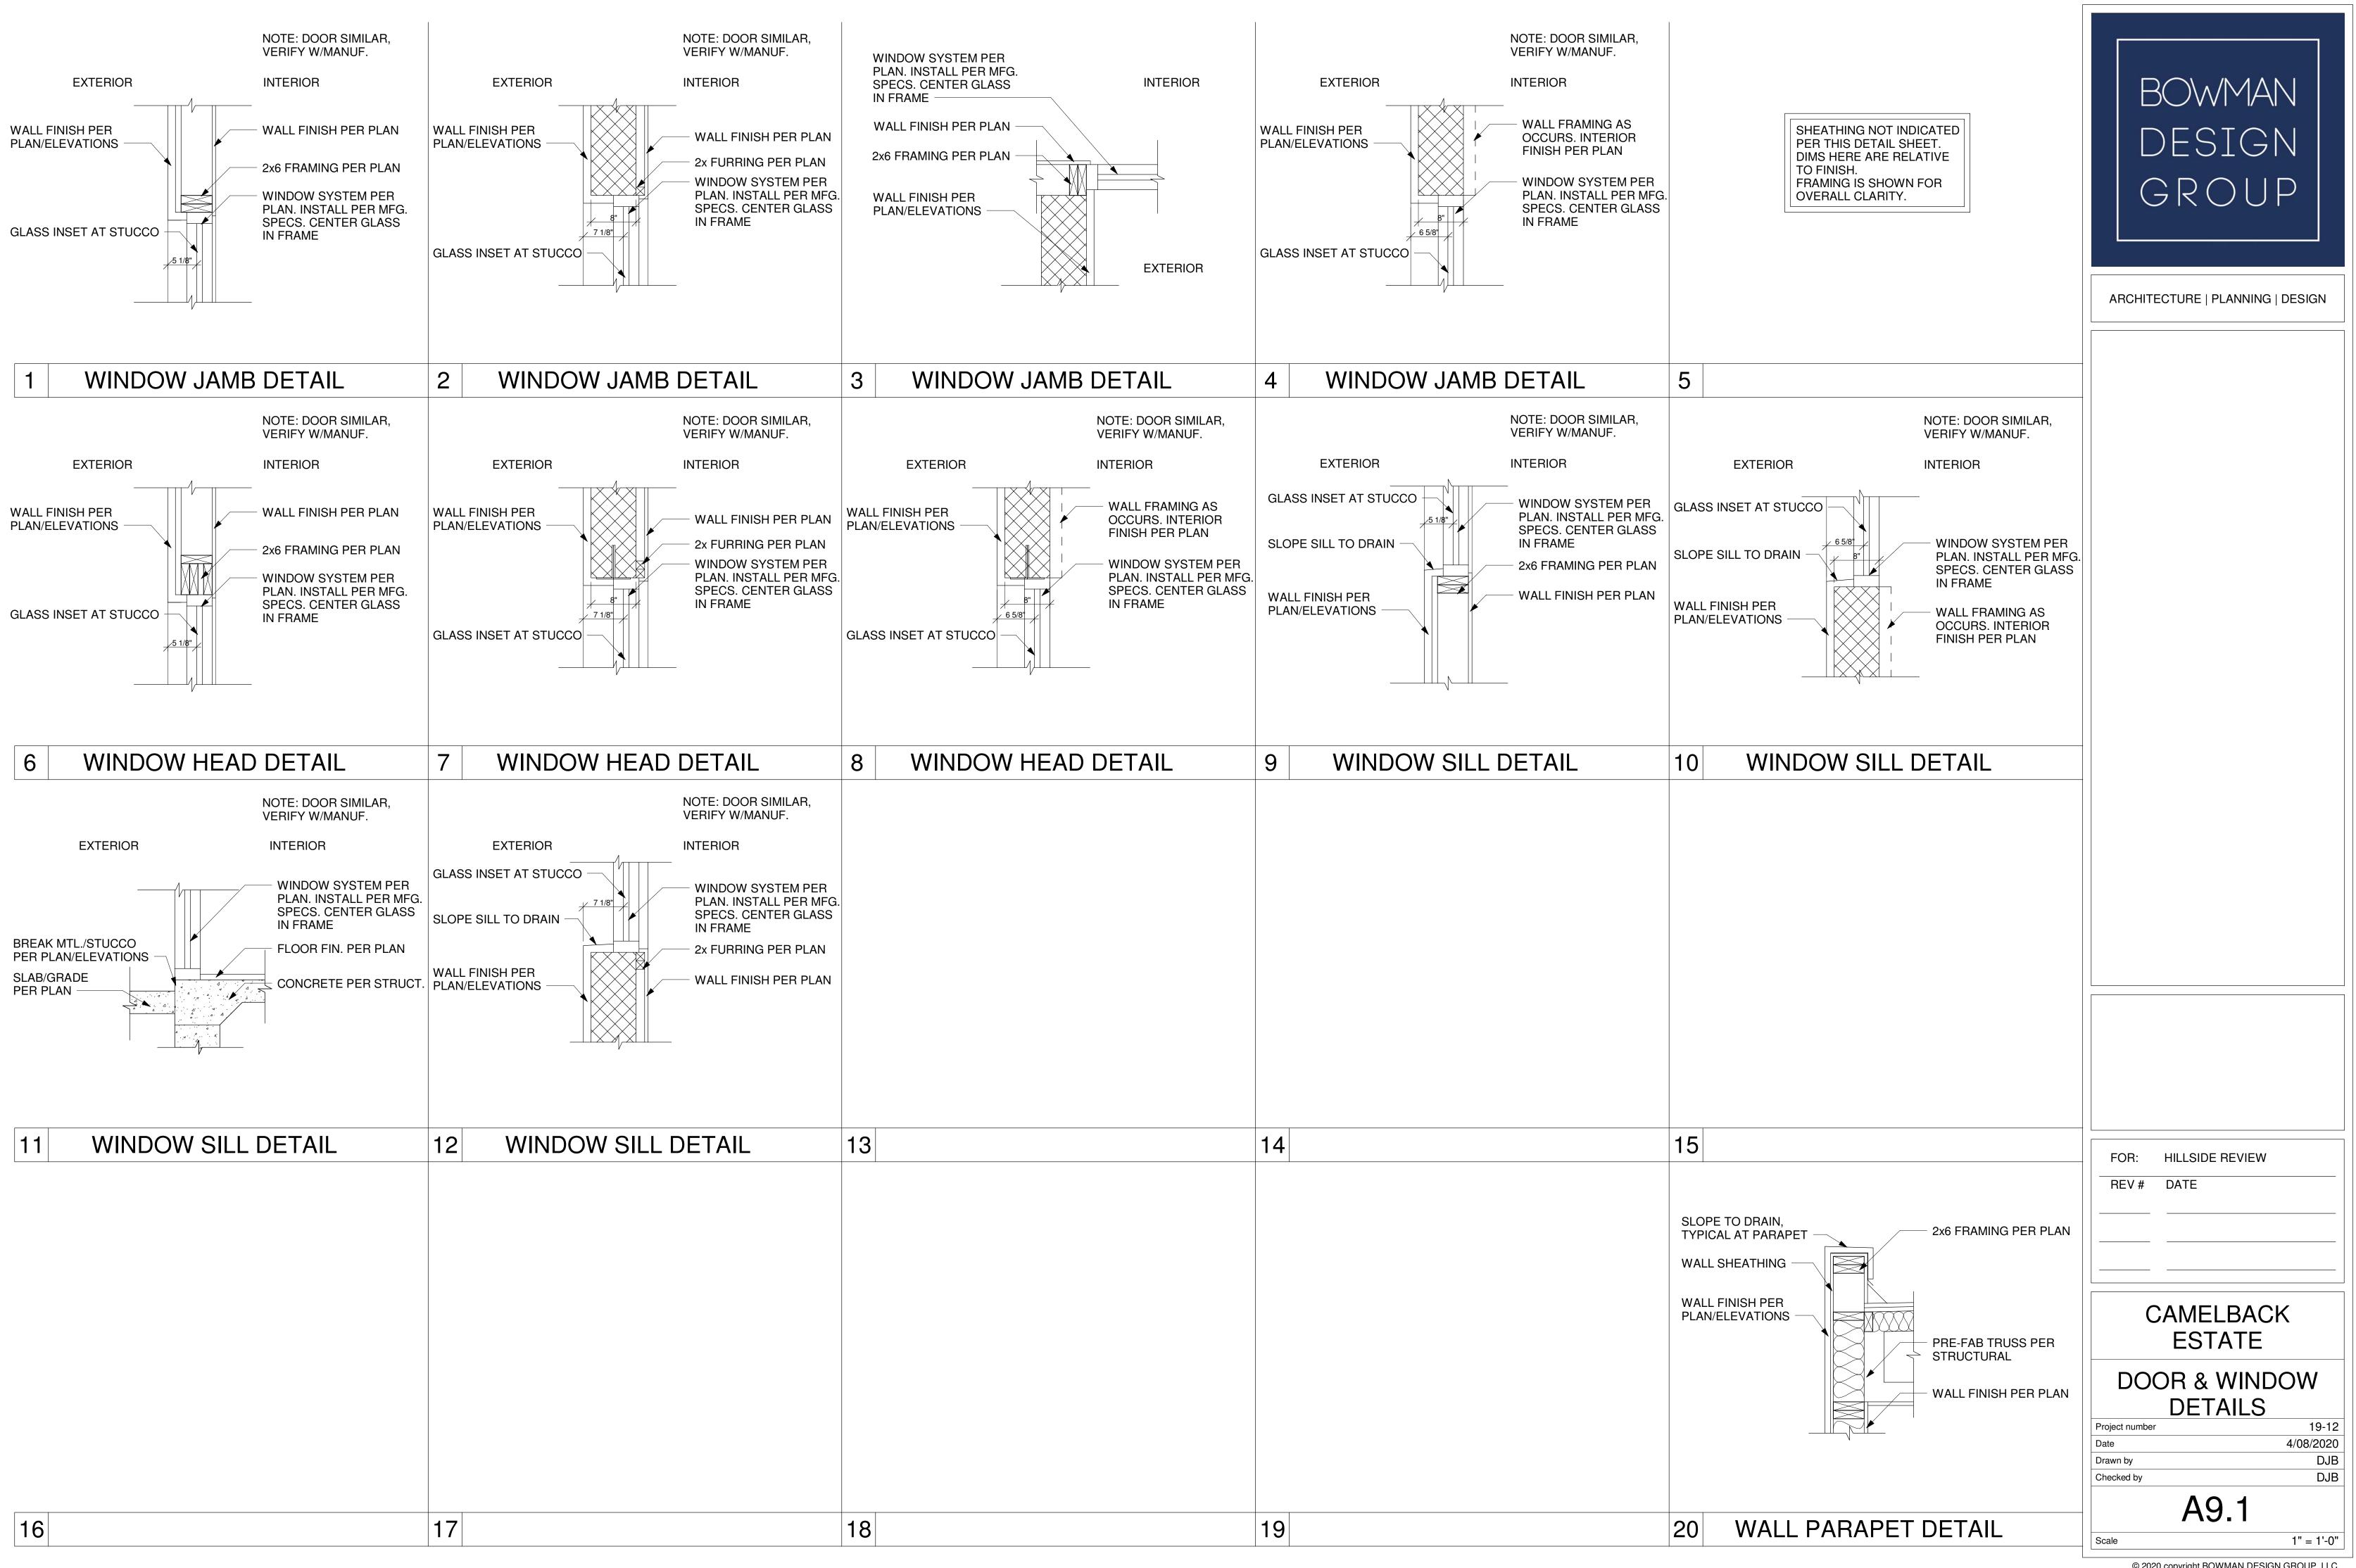
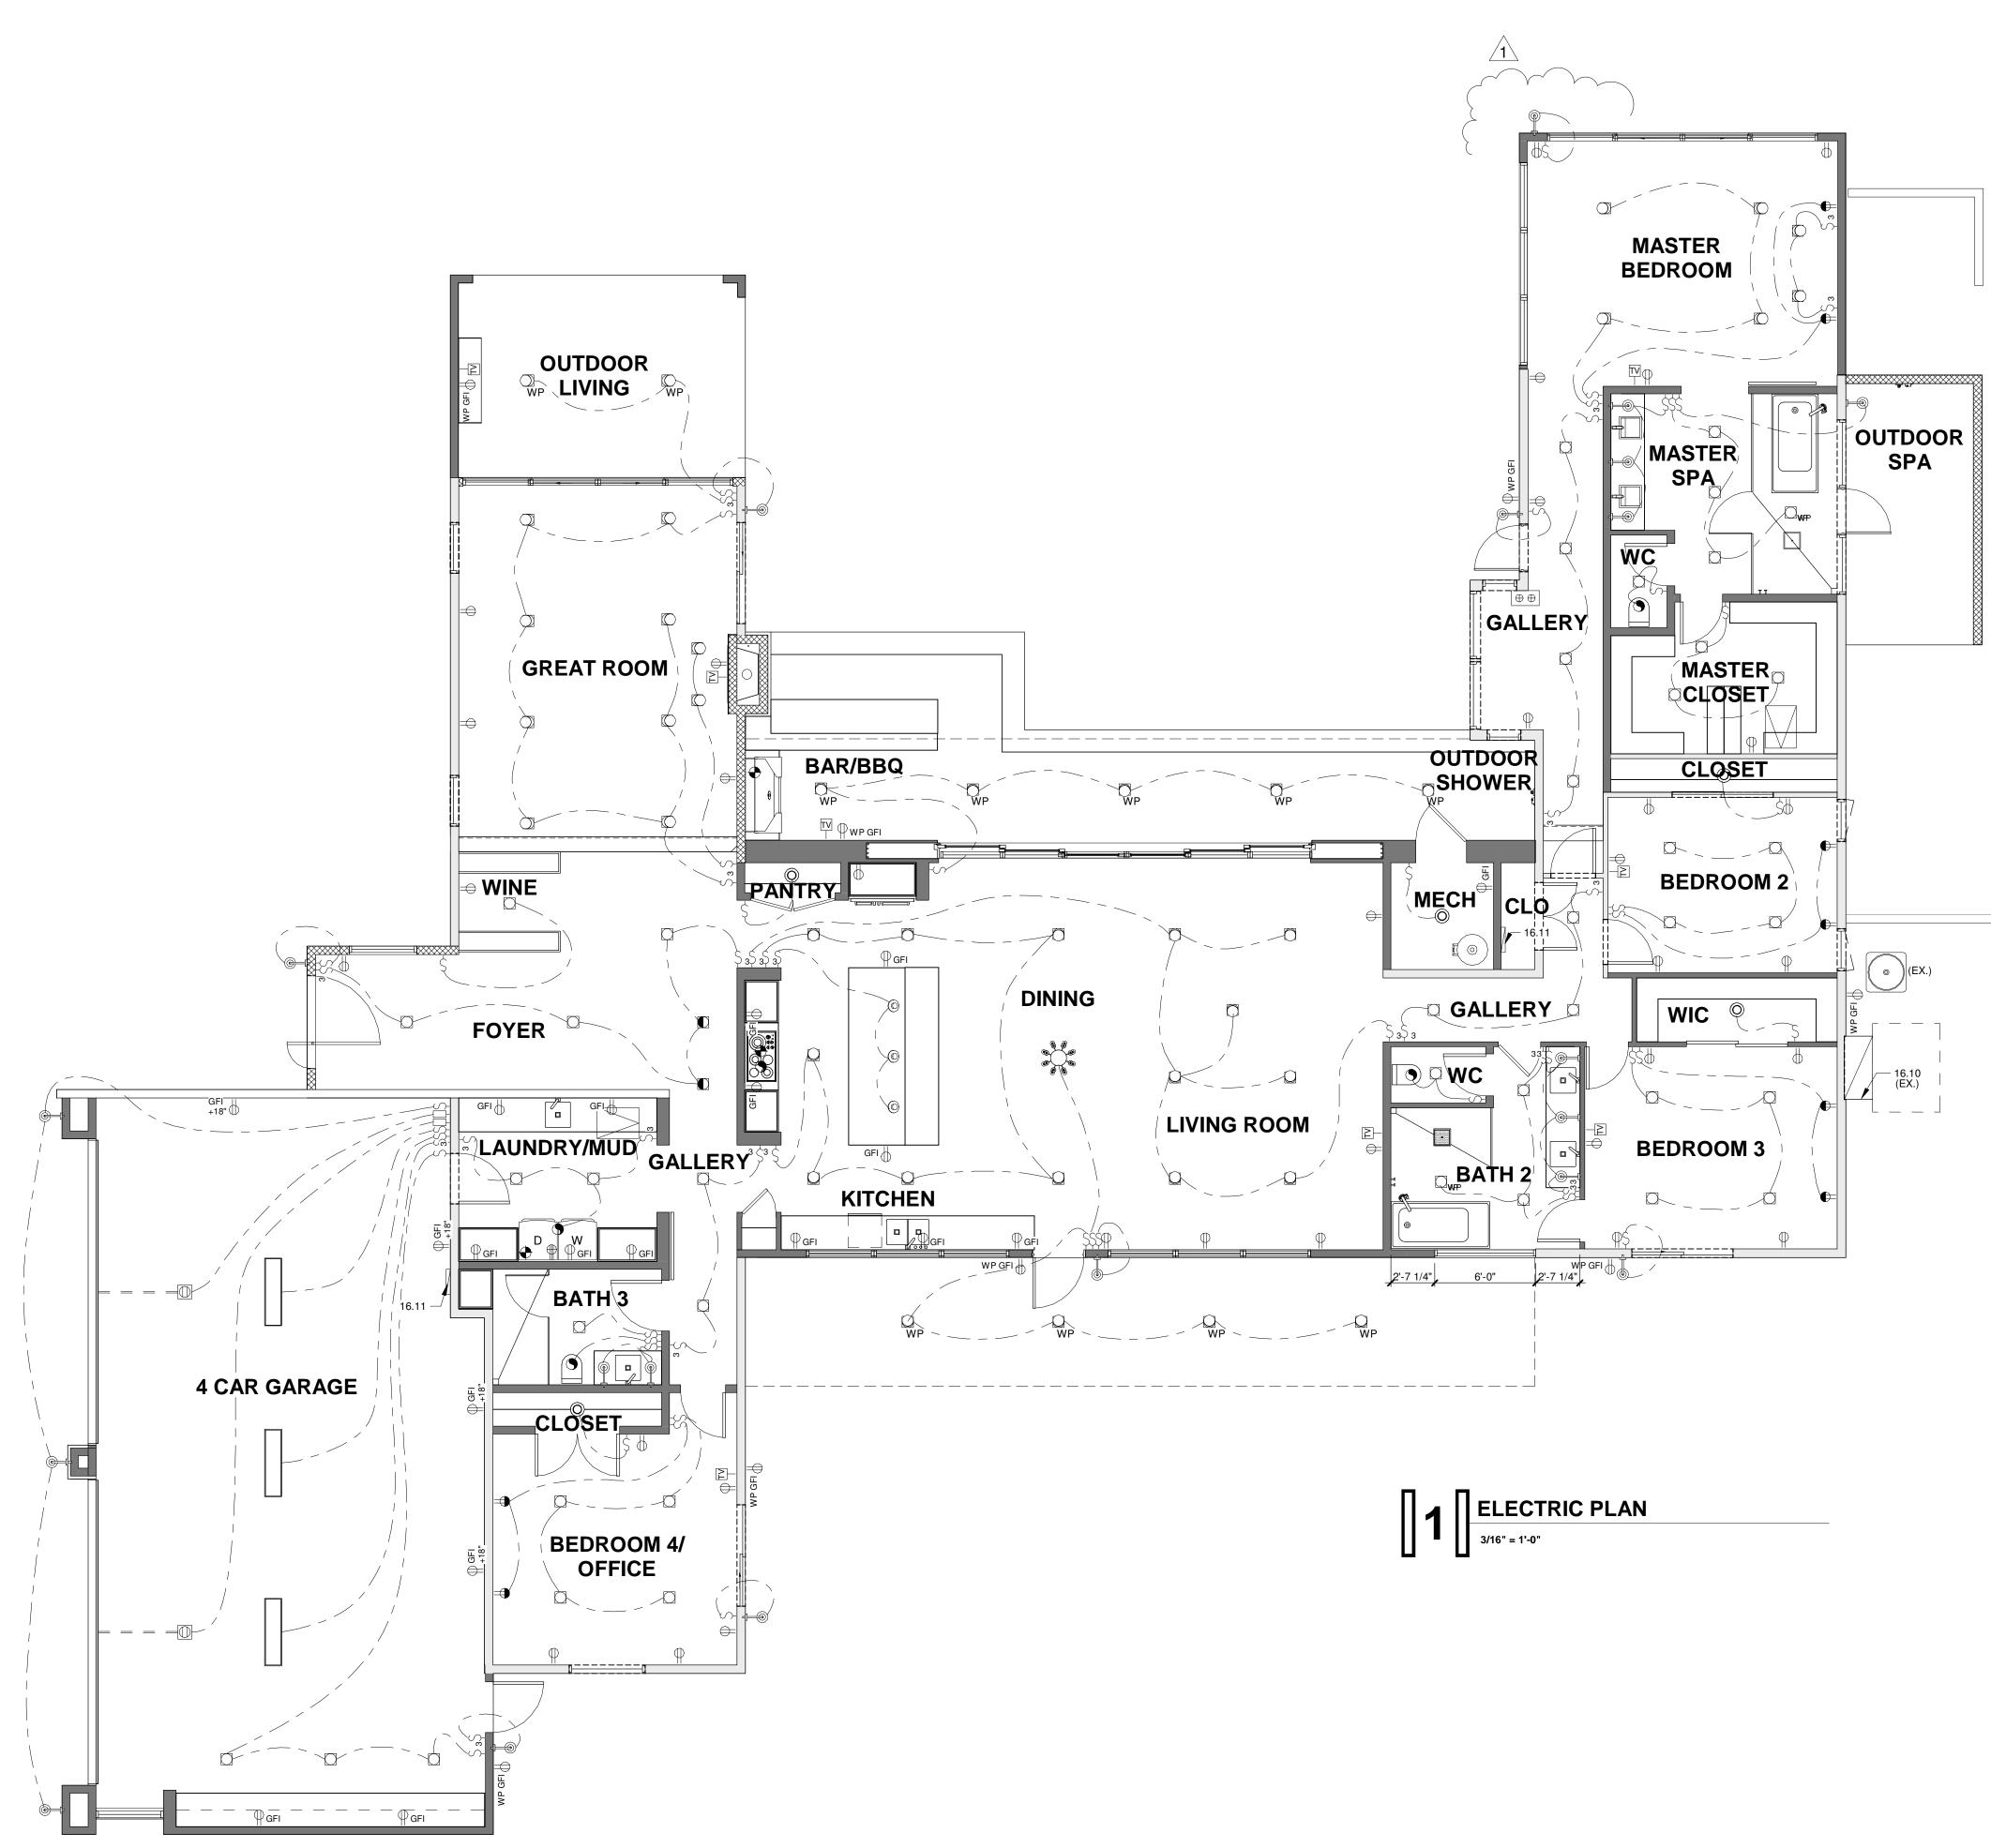
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GENERAL NOTES

G-1. GARAGE TO BE WIRED AND STUB OUT FOR FUTURE ELECTRIC CAR OUTLET. PANEL WILL NEED A DEDICATED CIRCUIT BREAKER WITH A 240V LINE.		
RESIST/ G-3. 75% OF	V RECEPTAQCLES TO BE LISTED TAMPER ANT. ALL LIGHTING TO HAVE HIGH EFFECIENCY LAMPS ECESSED LIGHTS IN BUILDING ENVELOPE TO BE	
SEALED		
 Ş	STANDARD WALL SWITCH	
	3-WAY WALL SWITCH	
	STANDARD DUPLEX OUTLET (SEE GEN. NOTE E)	
	1/2" SWITCHED OUTLET (SEE GEN. NOTE E) FLOOR OUTLET - VERIFY LOCATION WITH OWNER (SEE GEN. NOTE E)	
	220 V. OUTLET (SEE GEN. NOTE E)	
SD	110 V. SMOKE DETECTOR WITH BATTERY BACKUP	
CM	APPROVED CARBON MONOXIDE ALARM	
•	EXHAUST FAN (V.T.O)	
	CAN LIGHT	
	CANNED DIRECTIONAL LIGHT	
	WALL MOUNTED LIGHT	
0	PENDENT CEILING LIGHT	
0	SURFACE MOUNTED LIGHT	
	PUCK.ACCENT LIGHT	
	COMBINATION PHONE / TV	
•	GAS VALVE	
	GARAGE DOOR OPENER	
WP VP	WEATHER PROOF BOX VAPOR PROOF FIXTURE	
GFI 3 4	GROUND FAULT CIRCUIT INTERRUPET 3-WAY CONTROL FOR SWITCH 4-WAY CONTROL FOR SWITCH	
FOR: HILLSIDE REVIEW		
REV # DATE		
	CAMELBACK	
	ESTATE	
ELECTRIC PLAN		
Project num	nber 19-12	
Date	4/08/2020	
Drawn by Checked by	DJB DJB	
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Scale	As indicated	