Charles Drive Residence

4606 E. Charles Dr., Paradise Valley, AZ 85253

General Construction Notes

- 1. All work shall comply with all applicable codes and ordinances.
- 2. The Contractor shall verify all dimensions and conditions in the field. If a dimensional error occurs or a condition not covered in the drawings is encountered, the Contractor shall notify Designer before commencing that portion of the work.
- 3. The Contractor shall notify Designer if discrepancies are noted in these Contract Documents, in sufficient time as to not cause delay.
- 4. Dimensions take precedence over scale on the Construction Documents.
- 5. Details, notes, and finishes shall be applicable to all typical conditions whether or not referenced at all places on these plans. The Contractor is responsible for any standard or special detailing not specified herein.
- 6. The Contractor shall verify all existing grades and shall review all grading conditions prior to commencement of work.
- 7. The Contractor shall take all necessary precautionary measures to protect the public and adjacent properties from damage during construction.
- 8. The Contractor shall verify all equipment loads and notify Designer of any changes in size, weight, and location, or additional load to those indicated on the drawings.
- 9. The Contractor shall supervise and direct the work, using the best skill and attention. He shall be solely responsible for all methods, techniques, sequences, and procedures, and for coordinating all portions of the work under
- 10. All manufactured articles, material, and equipment shall be applied installed, connected, erected, used, cleaned, and conditioned in accordance with the manufacturer's written specifications or instructions unless hereinafter
- 11. The Contractor shall verify and protect the location of existing utilities.

specified to the contrary.

Special Notes

- 12. The starting of work by any Contractor or Subcontractor shall be considered prima facie evidence that he has inspected and accepted all conditions involved in his work and finds them satisfactory.
- 13. The Contractor shall be responsible for safety in the area of work in accordance with all applicable safety codes.
- 14. Each Contractor is responsible for any damage to adjacent work and is responsible for the repair and said damage at his own expense.
- 15. Finish grade shall slope 5% for a distance of 10'-0" to an approved water disposal area or to the drainage requirements per the governing body.
- 16. Flat-roofed areas shall have a minimum slope of 1/4" per liner foot. Slope shall be integral to truss design when truss framing is used or slope with rippers at conventional framing.
- 17. Slope and waterproof all sills and parapets. At C.M.U. use waterproof coating prior to installing finish. Do not penetrate top surface; attach at side.

1. Contractor to stake footprint of entire new construction or addition

Architect, and local authority prior to commencing work.

wall is within 3'-0" of building setback.

and verify layout relating to setbacks, location, etc. w/ Owner,

2. Setback certification is required at footing inspection when proposed

18. Minimum 22" x 30" attic access is required to all attic areas with 30 sf in area and 30" or more vertical clear height. See plan for location. Provide 30" clear headroom above the attic access.

- 19. Gypsum board used on exterior soffits must be approved exterior type.
- 20. Every sleeping room and basements with habitable space shall have at least one window with min. 5.7 sq. ft. net clear opening (5.0 sq. ft. at grade floor), minimum opening width of 20" minimum opening height of 24" and a sill height not more than 44"; or provide exterior door for emergency egress. Provide continuous egress from bedroom window to public way.
- 21. All exterior windows in habitable spaces to be double-paned.
- 22. All glass (with least dimension greater than 3" and bottom edge less than 60" above floor) in door and adjoining window less than 24" from locking device to be tempered.
- 23. All glass in hazardous locations and all glass within 18" of floor (except single panes with 9 sq ft or less area) shall be safety glass (R308.4).
- 24. Glazing located in railings regardless of area or height, adjacent to stairways, landings, or ramps within 36" of walking surface or less than 60" in height, and glazing adjacent to stairways within 60" of the bottom tread and less than 60" above nose of tread to be tempered.
- 25. All glass in French or sliding doors shall be tempered.
- 26. Shower enclosure shall be tempered glass. Glazing in any part of wall enclosing tub/shower/sauna where bottom edge is less than 60" above floor to be tempered.
- 27. Shower walls shall be finished with moisture-resistant sheetrock and ceramic tile to a minimum height of 70" above drain.
- 28. Water closets shall be a minimum of 15" from any vertical side surface to centerline of water closet and a minimum of 21" clear in front of water closet. Space other fixtures in accordance with Figure R307.2.
- 29. General Contractor shall coordinate backing for all accessories (towel bar, toilet paper holders, clothes pegs, etc.) in bathrooms, kitchen and other areas as required.
- 30. Furnish all finish hardware necessary for smooth operation of doors. Include all: flush required doorstops, thresholds, and weather-stripping bolts. In order to determine appropriate hardware function for each door consult a hardware
- 31. Joints, penetrations, and all other such openings in the building envelope that are sources of air leakage shall be sealed. Seal all voids around penetrations through floor slabs. Recessed lights are to be Type IC, or, if non-IC, installed inside an air-tight assembly.
- 32. No gas piping shall be installed in or on the ground under any building or structure. Provide combustion air for gas appliances.

Section # / Sheet #

Ceiling height, above finished floor

33. Hose bibs are to be equipped with integral backflow preventers.

10'-0" C.H.

Project Symbols

Section Marker

Detail Marke

Room Tag

Abbreviations

O.C. ON CENTER

PTD. PAINTED

PR. PAIR

PL. PLATE

PLBG. PLUMBING

R. RADIUS

REQ'D REQUIRED

REV. REVISION

RD. ROUND

SEC. SECTION

SIM. SIMILAR

TYP. TYPICAL

UR. URINAL

W/O

WD.

T.O.C. TOP OF CHIMNEY

T.O.P. TOP OF PARAPET

T.O.W.P. TOP OF WALL PLATE

W.C. WATER CLOSET

WITH

WITHOUT

WOOD

TOP OF SLAB

TOP OF SUBFLOOR

U.N.O. UNLESS NOTED OTHERWISE

V.C.T. VINYL COMPOSITION TILE

- ADD. ADDENDUM M.O. MASONRY OPENING AGGREGATE BASE COURSE MAT'L MATERIAL AIR CONDITIONING MAX. MAXIMUM ABOVE FINISHED FLOOR M.C.J. MASONRY CONTROL JOINT MECHANICAL ANCHOR BOLT
- ALUMINUM METAL MIN. MINIMUM BASEMENT N.I.C. NOT IN CONTRACT **BLOCKING** BLKG. BOARD N.T.S. NOT TO SCALE
- B.O. BOTTOM OF BLDG. BUILDING CAB. CABINET CAST IN PLACE
- CEILING HEIGHT CENTERLINE CL CLR. CLEAR CLO. CLOSET
- COLUMN COL. CONCRETE CONC. CONTROL JOINT C.J. CONTINUOUS CONT.
- CONCRETE MASONRY UNIT DIMENSION

ELEV.

EXP.

LAV.

OWNER:

CONTRACTOR:

ARCHITECT:

STRUCTURAL:

- DISPENSER DOWN DRINKING FOUNTAIN
 - ELECTRIC DRINKING FOUNTAIN **ELEVATION** EXPANSION
- **EXPANSION JOINT** EXISTING EXST. EXTERIOR
- INSULATION / INSULATED LAMINATE LAM.

LAVATORY

Project Directory

PROPERTY ADDRESS: 4606 E. Charles Dr., Paradise Valley, AZ 85253

Project Data

Livable -

PARCEL NUMBER: 168-69-022 **ZONING: R-43**

CONSTRUCTION TYPE: V-B **BUILDING SIZE:**

Garage / Mech -2111 sf 1285 sf Covered Patios / Overhangs 174 sf (521 sf X 1/3 for lumber) Trellis Patio -

5054 sf (2000 sf min.)

8624 sf Total Footprint -

FLOOR AREA RATIO: 8,586/41,453 = 20.7% (25% max.)

BUILDING SETBACKS:

LOT SIZE: 41,453 sf

Front - 40'-0" Side - 20'-0" / 40'-0" (with Frontage)

Rear - 40'-0"

Project Narrative

The existing home, built in 1960, is to be demolished. A new 5000 SF \pm /home will be constructed within the existing disturbed area, preserving the existing vegetation on the east side of the property. The new residence will have a contemporary style, with patios on front and rear to take advantage of the views. The garage portion of the house will be several steps lower than the main livable area to respond to the site slope of the site. Colors are

Sheet Index - Formal Review

Vicinity Map N.T.S.

To Shea Blvd.

Sunset Dr.

Mockingbird Ln.

- Cover Sheet / Project Info
- Site Photographs Α2 Architectural Renderings
- Aerial Photo with Improvements
- C1
- Grading & Drainage Plan
- Grading & Drainage Plan
- Civil Details, Sections
- Architectural Site Plan Α5 Floor Plan
- Elevations North & South
- Elevations East & West
- **Cross Sections**
- Building & Landscape Lighting Plan A10 Lighting Cut Sheets

Governing Building Codes

to be subtle desert tones, with LRV < 38%.

fitdesigns@live.com 480-205-4515

- 2015 International Building Code 2015 National Electrical Code
- 602-524-7877 Daryl Young / Ambassador Engineering, LLC
- 619 E. Orchid Lane, Gilbert, AZ 85296 dyoung@ambassadorengineering.com 602-690-3994

18223 W. Orchid Ln., Waddell, AZ 85355

ELECTRICAL: William Bethurum / VoltaUS

Bernie Fritz / ABF Investments, LLC

berniefritz@q.com

602-430-6930

TBD

16202 S. 31st Way, Phoenix, AZ 85048

Jennifer Lamoreaux / Fit Designs, PLLC 15459 S. 44th Way, Phoenix, AZ 85044

Geoff Markowski / G-Mar, LLC

geoff@g-mareng.com

3666 N. Miller Rd., Suite 100, Scottsdale, AZ 85251 wb@voltaus.com

480-695-0511

All work shall comply with the following codes & Town amendments:

- 2015 International Residential Code 2015 International Mechanical Code
- 2015 International Plumbing Code 2015 International Fuel Gas Code

DATE: **SCALE:** DRAWN:

designs

Fit Designs, PLLC 15459 S. 44th Way Phoenix, Arizona 85044 480.205.4515 fitdesigns@live.com

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<u>0</u>

To Lincoln Dr.

1/28/19 As Noted JPL JOB: 18-99

SHEET:

Project Info



























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Rear Yard / Pool Area - Facing Northwest .4



Front View - Facing North .1



Side View - Facing Southeast .5



Side View - Facing West .6



Driveway - Facing Northwest .7




Front Yard From Above - Facing Northeast .2



Rear Yard From Above - Facing Southwest .3

Exterior Notes

- A. Structure will not exceed 24'-0" max height above natural grade.
- B. Exterior finishes are stucco and block, with an LRV of <38%.
- C. Pool barrier is achieved with retaining walls and a gate at the mechanical screen wall.
- Existing vegetation will remain wherever possible. New plants are to be desert type with low water consumption. Lawn areas shown are artificial.

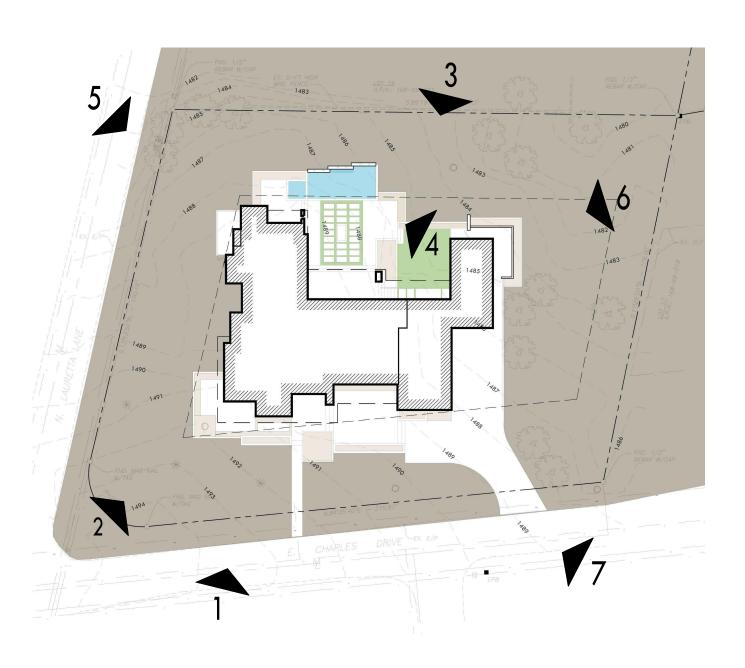

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les Drive Residence 4606 E. Charles Dr.

DATE: 1/7/19


SCALE: As Noted

DRAWN: JPL

JOB: SHEET:

A2

3D Renderings

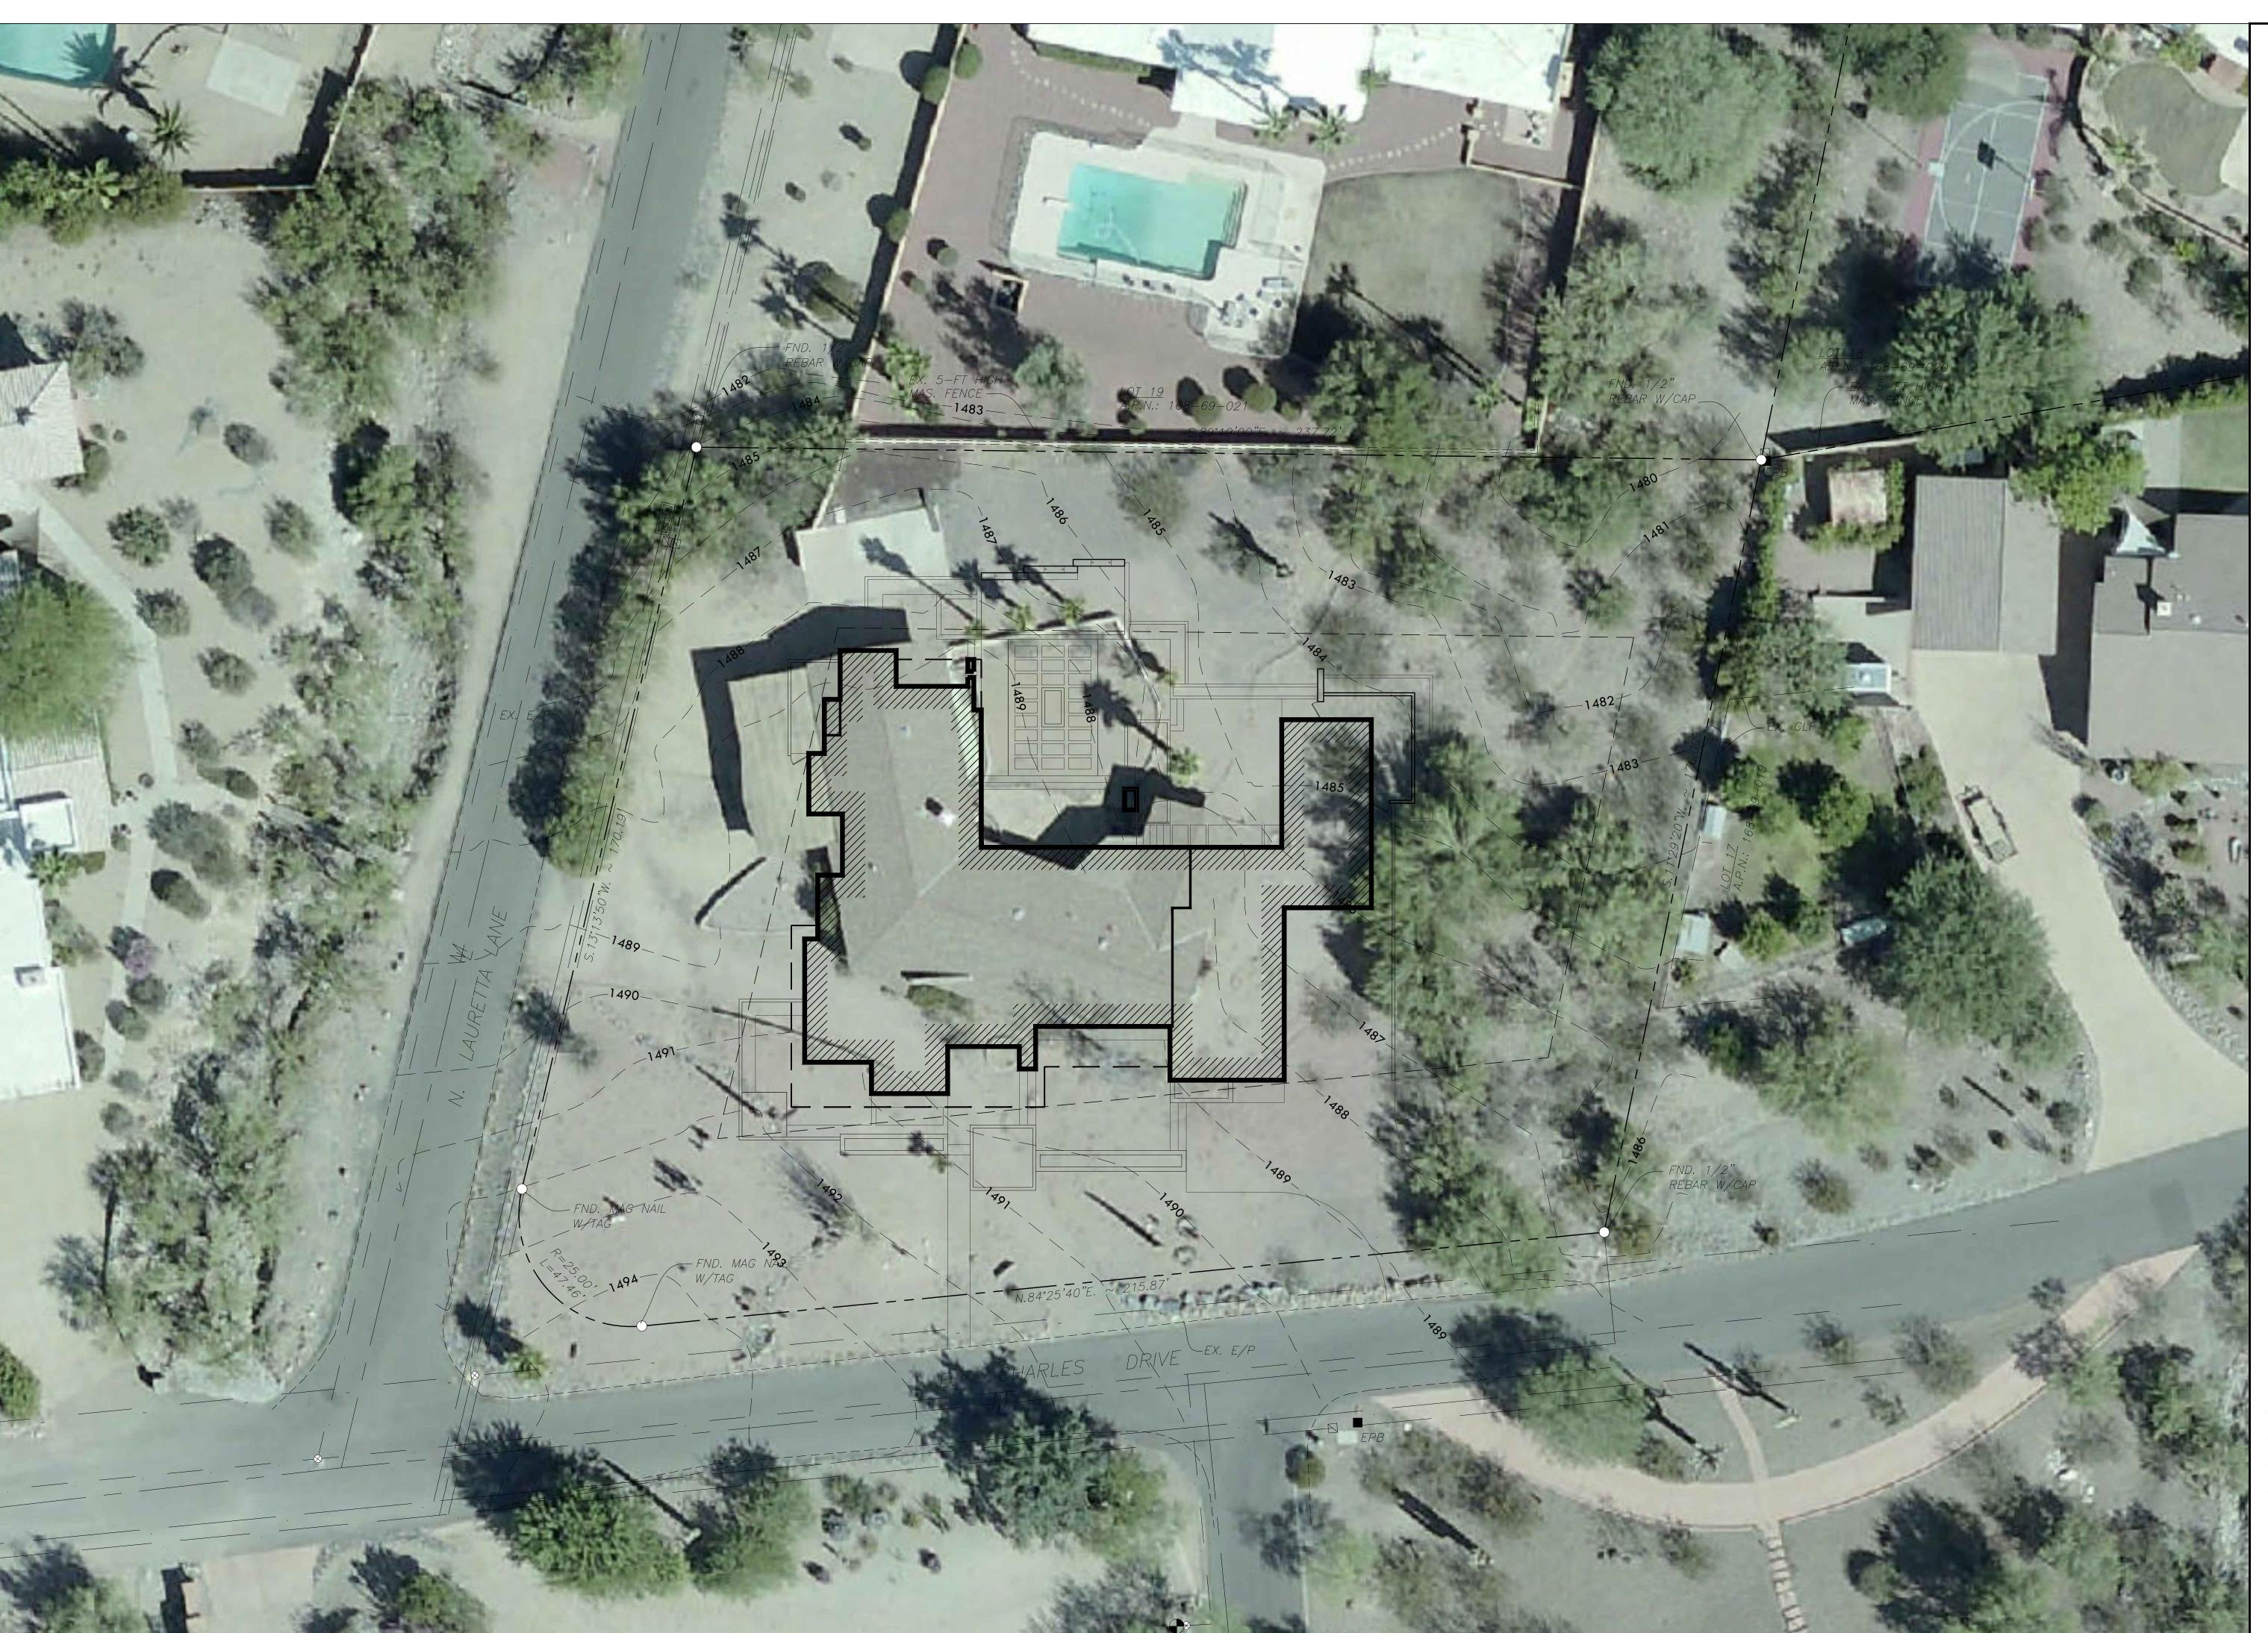



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PARADISE VALLEY GRADING AND DRAINAGE NOTES:

1. PRIOR TO THE FIRST INSPECTION OF STRUCTURES WITHIN 3 FEET OF A SETBACK LINE, THE PROPERTY PINS SHALL BE PLACED BY A REGISTERED CIVIL ENGINEER OR LAND SURVEYOR OF THE STATE OF ARIZONA. AND THE PROPERTY LINE(S) IDENTIFIED.

2. WHERE EXCAVATION IS TO OCCUR THE TOP 4" OF EXCAVATED NATIVE SOIL SHALL REMAIN ON THE SITE AND SHALL BE REUSED IN A MANNER THAT TAKES ADVANTAGE OF THE NATURAL SOIL SEED BANK IT CONTAINS. 3. ALL WORK REQUIRED TO COMPLETE THE CONSTRUCTION COVERED BY THIS PLAN SHALL BE IN ACCORDANCE WITH THE MARICOPA ASSOCIATION OF

GOVERNMENTS (M.A.G.) STANDARD SPECIFICATIONS AND DETAILS AND CURRENT SUPPLEMENTS THEREOF PER THE LOCAL MUNICIPALITY UNLESS SPECIFIED OTHERWISE IN THESE PLANS OR ELSEWHERE IN THE CONTRACT DOCUMENTS 4. THE CONTRACTOR IS TO COMPLY WITH ALL LOCAL STATE, AND FEDERAL LAWS AND REGULATIONS APPLICABLE TO THE CONSTRUCTION COVERED BY THIS

5. THE CONTRACTOR IS RESPONSIBLE FOR OBTAINING AND COMPLYING WITH ALL PERMITS REQUIRED TO COMPLETE ALL WORK COVERED BY THIS PLAN. 6. ALL EXTERIOR SITE LIGHTING SHALL COMPLY WITH THE APPLICABLE REQUIREMENTS FOR TYPE, LOCATION, HEIGHT, WATTAGE, AND LUMEN BASED UPON THE FIXTURES INSTALLED PURSUANT TO SECTION 1023 OF THE TOWN OF PARADISE VALLEY ZONING ORDINANCE FOR NON-HILLSIDE PROPERTIES, SECTION 2208 OF THE TOWN OF PARADISE VALLEY ZONING ORDINANCE FOR HILLSIDE PROPERTIES, OR AS SPECIFIED IN THE SPECIAL USE PERMIT FOR SPECIAL USE

7. A DUST CONTROL PLAN AND PERMIT MEETING THE REQUIREMENTS OF RULE 310 OF THE MARICOPA COUNTY AIR POLLUTION CONTROL REGULATIONS, AS AMENDED, IS REQUIRED.

8. A SEPARATE RIGHT-OF-WAY PERMIT IS NECESSARY FOR ANY OFF-SITE CONSTRUCTION 9. AN APPROVED GRADING AND DRAINAGE PLAN SHALL BE ON THE JOB SITE AT

ALL TIMES. DEVIATIONS FROM THE PLAN MUST BE PRECEDED BY AN APPROVED

PLAN REVISION. 10. EAVE PROJECTIONS INTO REQUIRED SETBACKS ARE LIMITED TO A MAXIMUM OF 24" PURSUANT TO SECTION 1008 OF THE TOWN OF PARADISE VALLEY ZONING ORDINANCES. 11. ALL STRUCTURES AND LANDSCAPING WITHIN THE SIGHT VISIBILITY TRIANGLE SHALL HAVE A 2 FOOT MAXIMUM HEIGHT.

12. ALL NEW AND EXISTING ELECTRICAL SERVICE LINES SHALL BE BURIED PER THE TOWN OF PARADISE VALLEY REQUIREMENTS. 13. IT SHALL BE THE RESPONSIBILITY OF THE PERMITTEE TO ARRANGE FOR THE RELOCATION AND RELOCATION COSTS OF ALL UTILITIES, AND TO SUBMIT A UTILITY RELOCATION SCHEDULE PRIOR TO THE ISSUANCE OF AN ENGINEERING CONSTRUCTION PERMIT

14. EXISTING AND/OR NEW UTILITY CABINETS AND PEDESTALS SHALL BE LOCATED A MINIMUM OF 4' BEHIND ULTIMATE BACK OF CURB LOCATION. 15. POOL, SPA, BARBECUE AND ANY PROPOSED STRUCTURES OVER 8" ABOVE GRADE REQUIRE SEPARATE PERMIT APPLICATIONS. 16. POOLS SHALL BE CONSTRUCTED BY SEPARATE PERMIT AND SECURED FROM UNWANTED ACCESS PER TOWN CODE, ARTICLE 5-2. 17. ALL FILL MATERIAL UNDER SLABS AND WALKS SHALL BE COMPACTED TO NOT LESS THAN 95%. 18. SETBACK CERTIFICATION IS REQUIRED AND SHALL BE PROVIDED TO TOWN

INSPECTOR PRIOR TO STEM WALL INSPECTION. 19. FOR BUILDING PADS THAT HAVE 1' OR MORE OF FILL MATERIAL, SOILS COMPACTION TEST RESULTS ARE REQUIRED AND SHALL BE PROVIDED TO TOWN

INSPECTOR PRIOR TO PRE-SLAB INSPECTION. 20. FINISHED FLOOR ELEVATION CERTIFICATION IS REQUIRED AND SHALL BE PROVIDED TO TOWN INSPECTOR PRIOR TO FRAMING INSPECTION. 21. MAIL BOXES SHALL COMPLY WITH THE TOWN OF PARADISE VALLEY STANDARDS FOR MAIL BOXES IN THE RIGHTOF-WAY FOR HEIGHT, WIDTH AND BREAK AWAY FEATURES. 22. ALL PATIOS, WALKS, AND DRIVES TO SLOPE AWAY FROM BUILDING AND

GARAGES AT A MINIMUM SLOPE OF 1/4" PER FOOT UNLESS SPECIFIED OTHERWISE. 23. TRENCH BEDDING AND SHADING SHALL BE FREE OF ROCKS AND DEBRIS. 24. THE TOWN ONLY APPROVES THE SCOPE OF WORK AND NOT THE

ENGINEERING DESIGN. ANY CONSTRUCTION QUANTITIES SHOWN ARE NOT VERIFIED BY THE TOWN. 25. THE APPROVAL OF THE PLANS IS VALID FOR 180 DAYS. IF A PERMIT FOR CONSTRUCTION HAS NOT BEEN ISSUED WITHIN 180 DAYS, THE PERMIT MUST BE

26. A TOWN INSPECTOR WILL INSPECT ALL WORK WITHIN THE TOWN'S RIGHTS-OF-WAY. NOTIFY TOWN INSPECTION SERVICES TO SCHEDULE A PRECONSTRUCTION MEETING PRIOR TO STARTING CONSTRUCTION. 27. WHENEVER EXCAVATION IS NECESSARY, CALL ARIZONA811 BY DIALING 811 or 602-263-1100. TWO (2) WORKING DAYS BEFORE EXCAVATION BEGINS 28. EXCAVATIONS SHALL COMPLY WITH REQUIREMENTS OF OSHA EXCAVATION STANDARDS (29 CFR, PART 1926, SUBPART P). UNDER NO CIRCUMSTANCES WILL THE CONTRACTORS BE ALLOWED TO WORK IN A TRENCH LOCATED WITHIN THE TOWN'S RIGHT-OF-WAY WITHOUT PROPER SHORING OR EXCAVATION METHODS. 29. PERMIT HOLDER SHALL POST A 6 SQUARE FOOT (2'X3') IDENTIFICATION SIGN, MADE OF DURABLE MATERIAL, IN THE FRONT YARD OF SUBJECT PROPERTY AND NOT IN THE TOWN'S RIGHT-OF-WAY. THE SIGN MAY NOT EXCEED A MAXIMUM OF 6 FEET IN HEIGHT FROM GRADE TO TOP OF THE SIGN. THE SIGN MUST INCLUDE THE PERMITTEE OR COMPANY NAME, PHONE NUMBER. TYPE OF WORK, ADDRESS OF PROJECT AND TOWN CONTACT NUMBER. 480-348-3556.

30. WHEN DEEMED NECESSARY, A 6-FOOT HIGH CHAIN LINK FENCE MUST BE INSTALLED AROUND THE CONSTRUCTION AREA TO PREVENT ANY POTENTIAL SAFETY HAZARD FOR THE PUBLIC. THE FENCE SHALL BE SETBACK AT LEAST 10 FEET FROM ALL RIGHTS-OF-WAY AND HAVE A 50-FOOT STREET CORNER SITE TRIANGLE WHERE APPLICABLE

31. CLEAR ACCESS FOR NEIGHBORING PROPERTIES AND EMERGENCY VEHICLES MUST BE MAINTAINED AT ALL TIMES. CONSTRUCTION RELATED VEHICLES MUST BE LEGALLY PARKED ONLY ON ONE SIDE OF THE STREET OR JOB SITE

32. ALL CONSTRUCTION DEBRIS AND EQUIPMENT MUST BE CONTAINED ON SITE AT ALL TIMES. CONTRACTOR AND PROPERTY OWNER MUST MAINTAIN THE JOB SITE FREE OF LITTER AND UNSIGHTLY MATERIALS AT ALL TIMES. CONSTRUCTION MATERIALS ARE PROHIBITED IN THE TOWN'S RIGHT-OF-WAY. 33. CONSTRUCTION ACTIVITIES ARE PERMITTED BETWEEN THE HOURS OF 7 AM AND 5 PM MONDAY THROUGH FRIDAY. CONSTRUCTION ACTIVITIES MAY START ONE (1) HOUR EARLIER DURING THE SUMMER (MAY 1ST THROUGH SEPTEMBER

34. THE USE AND OPERATION OF FUEL-FIRED GENERATORS IS PROHIBITED UNLESS DUE TO A HARDSHIP. TOWN APPROVAL SHALL BE REQUIRED. 35. THE CONTRACTOR AND PROPERTY OWNER SHALL BE LIABLE FOR ANY DAMAGE DONE TO ANY PUBLIC PROPERTY

AS A RESULT OF ANY CONSTRUCTION OR CONSTRUCTION RELATED ACTIVITIES. NO CERTIFICATE OF OCCUPANCY WILL BE ISSUED UNTIL ALL AFFECTED RIGHTS-OF-WAY ARE CLEANED AND/OR REPAIRED TO THEIR ORIGINAL CONDITION AND UNTIL ANY AND ALL DAMAGES TO AFFECTED PROPERTIES ARE

RESTORED TO ORIGINAL CONDITION. 36. A KEYED SWITCH SHALL BE REQUIRED ON ALL NEW AND EXISTING ELECTRIC ENTRY GATES. THE KEYED SWITCH SHALL BE INSTALLED IN A LOCATION THAT IS READILY VISIBLE AND ACCESSIBLE. KNOX BOX ORDER FORMS ARE AVAILABLE AT THE TOWN'S BUILDING SAFETY DEPARTMENT

37. PROPERTY OWNER, BUILDER, OR GENERAL CONTRACTOR WILL BE RESPONSIBLE FOR CONTROLLING DUST FROM THE SITE AT ALL TIMES. ALL MEANS NECESSARY SHALL BE USED BY THE BUILDER OR GENERAL CONTRACTOR TO CONTROL THE EXISTENCE OF DUST CAUSED BY ANY EARTHWORK, SPRAY APPLICATION OF MATERIALS, OR OTHER DUST-CAUSING PRACTICES REQUIRED BY THE CONSTRUCTION PROCESS.

38. APPROVAL OF THESE PLANS ARE FOR PERMIT PURPOSES ONLY AND SHALL NOT PREVENT THE TOWN FROM REQUIRING CORRECTION OF ERRORS IN THE PLANS WHERE SUCH ERRORS ARE SUBSEQUENTLY FOUND TO BE IN VIOLATION OF ANY LAW, ORDINANCE, HEALTH, SAFETY, OR OTHER DESIGN ISSUES. 39. ALL DRAINAGE PROTECTIVE DEVICES SUCH AS SWALES, INTERCEPTION DITCHES, PIPES PROTECTIVE BERMS, CONCRETE CHANNELS OR OTHER MEASURES DESIGNED TO PROTECT PROPOSED AND EXISTING IMPROVEMENTS FROM RUNOFF OR DAMAGE FROM STORM WATER, MUST BE CONSTRUCTED PRIOR TO THE CONSTRUCTION OF ANY IMPROVEMENTS.

CIVIL ENGINEERING GENERAL NOTES

1. IF THE CONTRACTOR FINDS ANY DISCREPANCY OR OMISSION, THE ENGINEER SHALL BE NOTIFIED BEFORE ANY INTERPRETATION IS MADE.

2. QUANTITIES SHOWN ARE FOR PERMIT PURPOSES ONLY AND ARE NOT FOR BIDDING OR CONTRACTING PURPOSES. THE CONTRACTOR IS RESPONSIBLE FOR BIDDING HIS OWN QUANTITY TAKE-OFF. 3. THE BUILDING MATERIALS CONTAINING ASBESTOS WILL NOT BE USED ON

THIS PROJECT 4. THE CONTRACTOR SHALL MAKE NO CLAIM FOR QUANTITY ADJUSTMENT UNLESS

ALL CONSTRUCTION SURVEY STAKES ARE MAINTAINED FOR VERIFICATION. NOTHING IN THE CONTRACT DOCUMENTS SHALL CREATE ANY CONTRACTURAL RELATIONSHIP BETWEEN THE ENGINEER AND THE CONTRACTOR OR THE

ENGINEER AND THE SUBCONTRACTOR. THE ENGINEER WILL NOT BE RESPONSIBLE FOR CONSTRUCTION OR SAFTEY MEANS, METHODS, TECHNIQUES, SEQUENCES OR PROCEDURES UTILIZED IN CONNECTION BY THE CONTRACTOR OR SUBCONTRACTORS.

CHANGE ORDERS SHALL BE EXECUTED IN WRITING BY THE OWNER OR HIS REPRESENTATIVE. VERBAL CHANGES WILL NOT BE HONORED. 8. SEE ARCHITECTURAL DRAWINGS FOR ALL ON-SITE:

A. HORIZONTAL CONTROL & BUILDING LOCATIONS. B. DETAILS AND HORIZONTAL LOCATION OF CURBS AND SIDEWALKS. . PARKING LOT LAYOUT.

IT WILL BE THE CONTRACTOR'S RESPONSIBILITY TO LOCATE ALL EXISTING UNDERGROUND UTILITY FACILITIES BOTH HORIZONTALLY AND VERTICALLY PRIOR TO CONSTRUCTION AND TAKE ALL NECESSARY PRECAUTIONS TO AVOID ANY DAMAGE TO EXISTING UNDERGROUND FACILITIES. CALL BLUE STAKE CENTER (602) 263-1100 OR A PRIVATE UNDERGROUND UTILITY LOCATION COMPANY 48 HOURS PRIOR TO EXCAVATING. THE ENGINEER AND/OR OWNER CANNOT GUARANTEE ANY ELEVATIONS OR LOCATIONS OF EXISTING

UNDERGROUND UTILITIES SHOWN ON THESE PLANS. UNDERGROUND INFORMATION AND UTILITIES SHOWN HAVE BEEN OBTAINED FROM INFORMATION PROVIDED ON QUARTER SECTION MAPS FROM THE UTILITY COMPANIES LOCATED WITHIN THE AREA. THUS. UNDERGROUND INFORMATION MUST BE FIELD VERIFIED BEFORE

11. UTILITY COMPANIES SERVING THIS AREA ARE: WATER: PRIVATE WATER COMPANY - EPCOR SFWFR: PRIVATE SEPTIC TELEPHONE: CENTURYLINK ELECTRIC: ARIZONA PUBLIC SERVICE

GAS: SOUTHWEST GAS CABLE TV: COX COMMUNICATIONS THE TOPO INFORMATION SHOWN ON THIS DRAWING WAS OBTAINED FROM A TOPOGRAPHIC SURVEY PERFORMED BY G-MAR, LLC, DATED, AUGUST 22, 2018.

13. BOUNDARY INFORMATION SHOWN WAS TAKEN THE PLAT OF "SUNSET HILLS" A SUBDIVISION PLAT RECORDED IN BOOK 68 OF MAPS, PAGE 2, RECORDS OF MARICOPA COUNTY, ARIZONA, AS WELL AS MARICOPA COUNTY GIS. THE CIVIL ENGINEER OF RECORD DOES NOT CERTIFY THE BOUNDARY INFORMATION SHOWN ON THIS PLAN.

GRADING & DRAINAGE PLAN FOR

"4606 E. CHARLES DRIVE" A PORTION OF THE SOUTHWEST QUARTER OF SECTION 31.

CIVIL NOTES (APPLY UNLESS OTHERWISE NOTED ON CIVIL DRAWINGS)

TOWNSHIP 3 NORTH, RANGE 4 EAST OF THE GILA AND SALT RIVER

BASE AND MERIDIAN, MARICOPA COUNTY, ARIZONA

LEGAL DESCRIPTION

LOT 20 OF "SUNSET HILLS" A SUBDIVISION PLAT RECORDED IN BOOK 68 OF MAPS, PAGE 2, RECORDS OF MARICOPA COUNTY, ARIZONA.

SHEET INDEX

SHEET NO.

COVER SHEET & CIVIL NOTES C2 GRADING & DRAINAGE PLAN

SECTIONS AND DETAILS

RETENTION REQUIREMENTS - PRE VS POST DEVELOPMENT

per Paradise Valley

PER TOWN OF PARADISE VALLEY REQUIREMENTS FOR SINGLE FAMILY RESIDENCE DRAINAGE DESIGN STANDARDS & MCDDM, VOL II AND VOL III.

V = Volume of retention required (cubic feet or acre-feet) Cw = Weighted Runoff factor for tributary areas P = 100—year, 2—hour storm event precipitation depth (inches)

A = Drainage area (square feet or acres)

PRE DEVELOPMENT RETENTION REQUIREMENTS

A = 41,453 S.F.P = 2.24 INCHES C = 0.7 PRE

Vpre = 5,417 CUBIC FEET

RETENTION REQUIREMENTS - AREA OF DISTURBANCE

V = A(P/12)C V = Volume of retention required (cubic feet or acre-feet)C = Runoff factor for tributary areas P = 100-year, 2-hour rainfall (in inches)

A = Drainage area (square feet or acres)

WEIGHTED RUN-OFF COEFFICIENT CALCULATIONS

AREA TYPE	AREA (SQ.F.T)	<u>C</u>	<u>C*A</u>
ASPHALT/ROOF CONCRETE DESERT LANDSCAPE GRAVEL DRIVEWAY TURF	8,916 7,137 24,697 0 703	0.90 0.95 0.70 0.35 0.35	8,024 6,780 17,288 0 <u>246</u> 32,339

A = 41,453 S.F.D = 2.24 INCHES C = 0.78 WEIGHTED

EXCESS VOLUME =

Vpost = 6,037 CUBIC FEET Vr = Vpost - Vpre = 6,037 - 5,417 = 620 CUBIC FEET

ON-SITE RETENTION PROVIDED

Volume = $((1/3)h)*(A1+A2+Sqrt(A1*A2))$						
Retention B						
Elevation (ft.)	Area (sq.ft.)		Depth (feet)	Volume (cu.ft.)		
(16.)	(34.14.)		(1001)	(cu.i)		
1481.0	2,241		0.5	928		
1480.5	1,496		0.5	920		
VOLUME PRO VOLUME REC		928 620	CUBIC FEET CUBIC FEET			

308 CUBIC FEET

OWNER/DEVELOPER ABF INVESTMENTS, LLC 16202 S. 31ST WAY PHOENIX, AZ 85048 PH: 602-430-6930

ARCHITECT/DESIGNER

FIT DESIGNS 15459 S. 44TH WAY PHOENIX, ARIZONA 85044 PH: 480-205-4515 CONTACT: JENNIFER LAMOREAUX

CONTACT: BERNIE FRITZ

PROJECT BENCHMARK GDACS PT. #26100-1

FOUND 3" PARADISE VALLEY BRASS CAP IN HAND HOLE NEAR THE INTERSECTION OF MOCKINGBIRD AND TATUM ROAD WITH AN ELEVATION OF 1435.620 (NAVD '88 DATUM).

ABBREVIATIONS

BOTT. BOTTOM

B/C

C.F.

CLF

CONC.

C.Y.

D.E.

D/W

ESMT.

EXIST.

F.F.

FND.

FT.

PVMT.

P.U.E.

R/W

(SOME ABBREVIATIONS MAY

BACK OF CURB

CHAIN LINK FENCE

DRAINAGE EASEMENT

CUBIC FEET

CONCRETE

DRIVEWAY

EASEMENT

EXISTING

FOUND

FEET

MASONRY

PAVEMENT

PROPOSED

SIDEWALK

TYPICAL

FINISHED FLOOR

MONUMENT LINE

NOT TO SCALE

PROPERTY LINE

RIGHT OF WAY

U.N.O. UNLESS NOTED OTHERWISE

8,586 S.F

PUBLIC UTILITY EASEMENT

CUBIC YARD

BASIS OF BEARING

N.13°13'50"E. ALONG THE MONUMENT FOR LAURETTA LANE AS SHOWN IN THE PLAT OF RECORD FOR "SUNSET HILLS" AS RECORDED IN BOOK 68 OF MAPS, PAGE 2, RECORDS OF MARICOPA COUNTY, ARIZONA.

SITE AREA DATA

41,453 S.F. (NET) BLDG. SITE SLOPE: 5.3%

ALLOWABLE DIST.: 60% (24,872 S.F.) EXIST. AREA DISTURBED: 39,100 S.F. NEW AREA DISTRUBED: 33,724 S.F.

PER TOPV HILLSIDE ORDINANCE, TABLE 1:

ZONING R - 43

SITE.

SETBACKS:

FRONT: 40-FT REAR: 40-FT SIDES: 20-FT

CUT / FILL QUANTITIES

CUT 15 C.Y. FILL 2,000 C.Y. NEW FILL 1,985 C.Y. QUANTITIES ARE SHOWN FOR PERMIT PURPOSES ONLY. CONTRACTOR SHALL PERFORM THEIR OWN QUANTITY TAKE-OFF

HILLSIDE ASSURANCE AMOUNT: \$1,947.00

FOR ACCURACY OF CUT AND FILL ON THE

PROJECT DESCRIPTION

GRADING AND DRAINAGE RELATED IMPROVEMENTS AS THEY APPLY TO THE NEW SINGLE FAMILY RESIDENCE TO THE SITE, ALONG WITH ASSOCIATED DRIVEWAYS, WALKWAYS AND LANDSCAPING. THE EXISTING HOUSE WILL BE DEMOLISHED AND REMOVED. THE NEW FINISHED FLOOR ELEVATION OF THE HOUSE IS AT LEAST 12-INCHES ABOVE NEAREST ADJACENT GRADE. SINCE THIS SITE IS NOT IN A FLOOD PLAIN AND NO OFF-SITE FLOWS IMPACT THE SITE, HIGH WATER ELEVATION OF RETENTION BASIN 'A' IS 1381.0 PER REFERENCED BENCHMARK.

SOLIARE FOOTAGE

SQUARE FOUTAGE	
LIVABLE	5,054 S.F.
GARAGE / MECH.	2,111 S.F.
COVERED PATIOS / ENTRY	1,247 S.F.
TRELLIS / PATIO	174 S.F.

LOT COVERAGE

TOTAL UNDER ROOF:

TOTAL LOT AREA 8,586 / 41,453 = 20.7 % (25% MAX.)

DRAINAGE STATEMENT

PER TOWN OF PARADISE VALLEY GRADING AND DRAINAGE STANDARDS, THE PRE VS. POST VOLUME WILL BE PROVIDED, ON-SITE, FOR THE 100-YEAR, 2-HOUR STORM EVENT.

4. EXTREME STORM FLOWS OUTFALL THE SITE (ESO) AT THE NORTHEAST

- THIS PARCEL IS <u>NOT</u> IN A SPECIAL FLOOD HAZARD.
 OFF-SITE FLOWS DO IMPACT THIS SITE. RETENTION PROVIDED IS FOR THE PRE VS. POST STORM EVENT.
- CORNER OF THE PROPERTY INTO ITS EXISTING WATERCOURSE AT AN ELEVATION OF 1480.2 PER REFERENCED BENCHMARK. THE LOWEST FINISHED FLOOR ELEVATION OF 1492.50 IS SAFE FROM INUNDATION DURING THE 100-YEAR PEAK RUN-OFF EVENT IF CONSTRUCTED IN ACCORDANCE WITH THESE APPROVED PLANS. THE 100-YEAR WATER

SURFACE ELEVATION IS BASED ON THE RETENTION BASIN AT 1481.00.

	FEMA SITE INFORMATION						
COMMUNITY PANEL # SUFFIX DATE OF FIRM FIRM (IN AO)						BASE FLOOD ELEV. (IN AO ZONE, USE DEPTH)	
	040049	1755 10/16/13	L	10/16/13	Х	1 FOOT	

DOUBLETREE CANYON SQUAW PEAK ESTATES NOT APPLY TO THESE DRAWINGS) TRIAD E Tomahawk Trail TATUM MOUNTAIN ESTATES E Sunset D 06 East Charles Drive WEEKS ESTATES MOCK PARADISE

VICINITY MAP

◑ *GM*

 \square TR

→ → →

 \square WM

 \otimes AS

____ C ____

——— DH ———

——— F ———

——— GAS ———

(SOME ITEMS MAY NOT APPLY TO THESE DRAWINGS) BOUNDARY LINE MONUMENT LINE — — — EASEMENT LINE **EXISTING PROPOSED**

VERT. CURB & GUTTER CONCRETE CURB

VISTA ESTATES

CONCRETE BRASSCAP IN HANDHOLE

BRASSCAP FLUSH GAS METER TELEPHONE RISER

CABLE RISER POWER POLE ELECTRICAL GUY DOWN STREET LIGHT OR LIGHT POLE

WATER METER

BACK FLOW PREVENTION ASSEMBLY DRYWELL/CATCH BASIN SPRINKLER CONTROL BOX

ANTI-SIPHON LANDSCAPE VALVE OVHERHEAD CABLE TV OVERHEAD TELEPHONE

UNDERGROUND TELEPHONE OVERHEAD ELECTRICAL UNDERGROUND ELECTRICAL

— — SD STORM DRAIN

NATURAL GROUND ELEV. (ADD 1400) TOP OF CURB ELEV. (ADD 1400) PAVEMENT ELEV. (ADD 1400) GUTTER ELEV. (ADD 1400)

FINISHED FLOOR ELEV. CONCRETE ELEV. (ADD 1400) RIM ELEV. (ADD 1400) INVERT ELEV. (ADD 1400)

TOP OF RETAINING WALL ELEV. (ADD 1400) TOP OF FOOTING ELEV. (ADD 1400) DRAINAGE SLOPE

BOTTOM OF EMBANKMENT

EXTREME SITE OUTFALL (ESO) TOP OF EMBANKMENT

AS-BUILT CERTIFICATION

REGISTRATION NUMBER

I HEREBY CERTIFY THAT THE "RECORD DRAWING" MEASUREMENTS AS SHOWN HEREON WERE MADE UNDER MY SUPERVISION OR AS NOTED AND ARE CORRECT TO THE BEST OF MY KNOWLEDGE AND BELIEF.

REGISTERED ENGINEER/LAND SURVEYOR


CALL TWO WORKING DAYS BEFORE YOU DIG 1-800-STAKE-I

DATE

SIDENCE CHA

DATE ISSUED: 22 AUG 18 DRAWN BY: GM/AD CHECKED BY: GM

SHEET DESCRIPTION: GRADING DRAINAGE PLAN

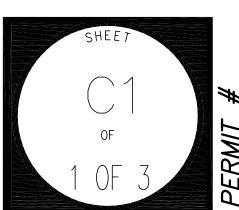

JOB NO. 18-08-015-00

TOWN OF PARADISE VALLEY


APPROVAL THIS SET OF PLANS HAS BEEN REVIEWED FOR COMPLIANCE WITH TOWN OF PARADISE VALLEY REQUIREMENTS PRIOR TO ISSUANCE OF PERMITS. THE TOWN NEITHER ACCEPTS NOR ASSUMES ANY LIABILITY FOR ERRORS OR OMISSIONS. THIS COMPLIANCE APPROVAL SHALL NOT PREVENT THE CITY ENGINEER FROM REQUIRING CORRECTIONS OF ERRORS OR OMISSIONS IN PLANS FOUND TO BE IN VIOLATION OF LAWS OR ORDINANCES.

DATE

GRADING & DRAINAGE PLAN

FOR "4606 E. CHARLES DRIVE"

A PORTION OF THE SOUTHWEST QUARTER OF SECTION 31,
TOWNSHIP 3 NORTH, RANGE 4 EAST OF THE GILA AND SALT RIVER

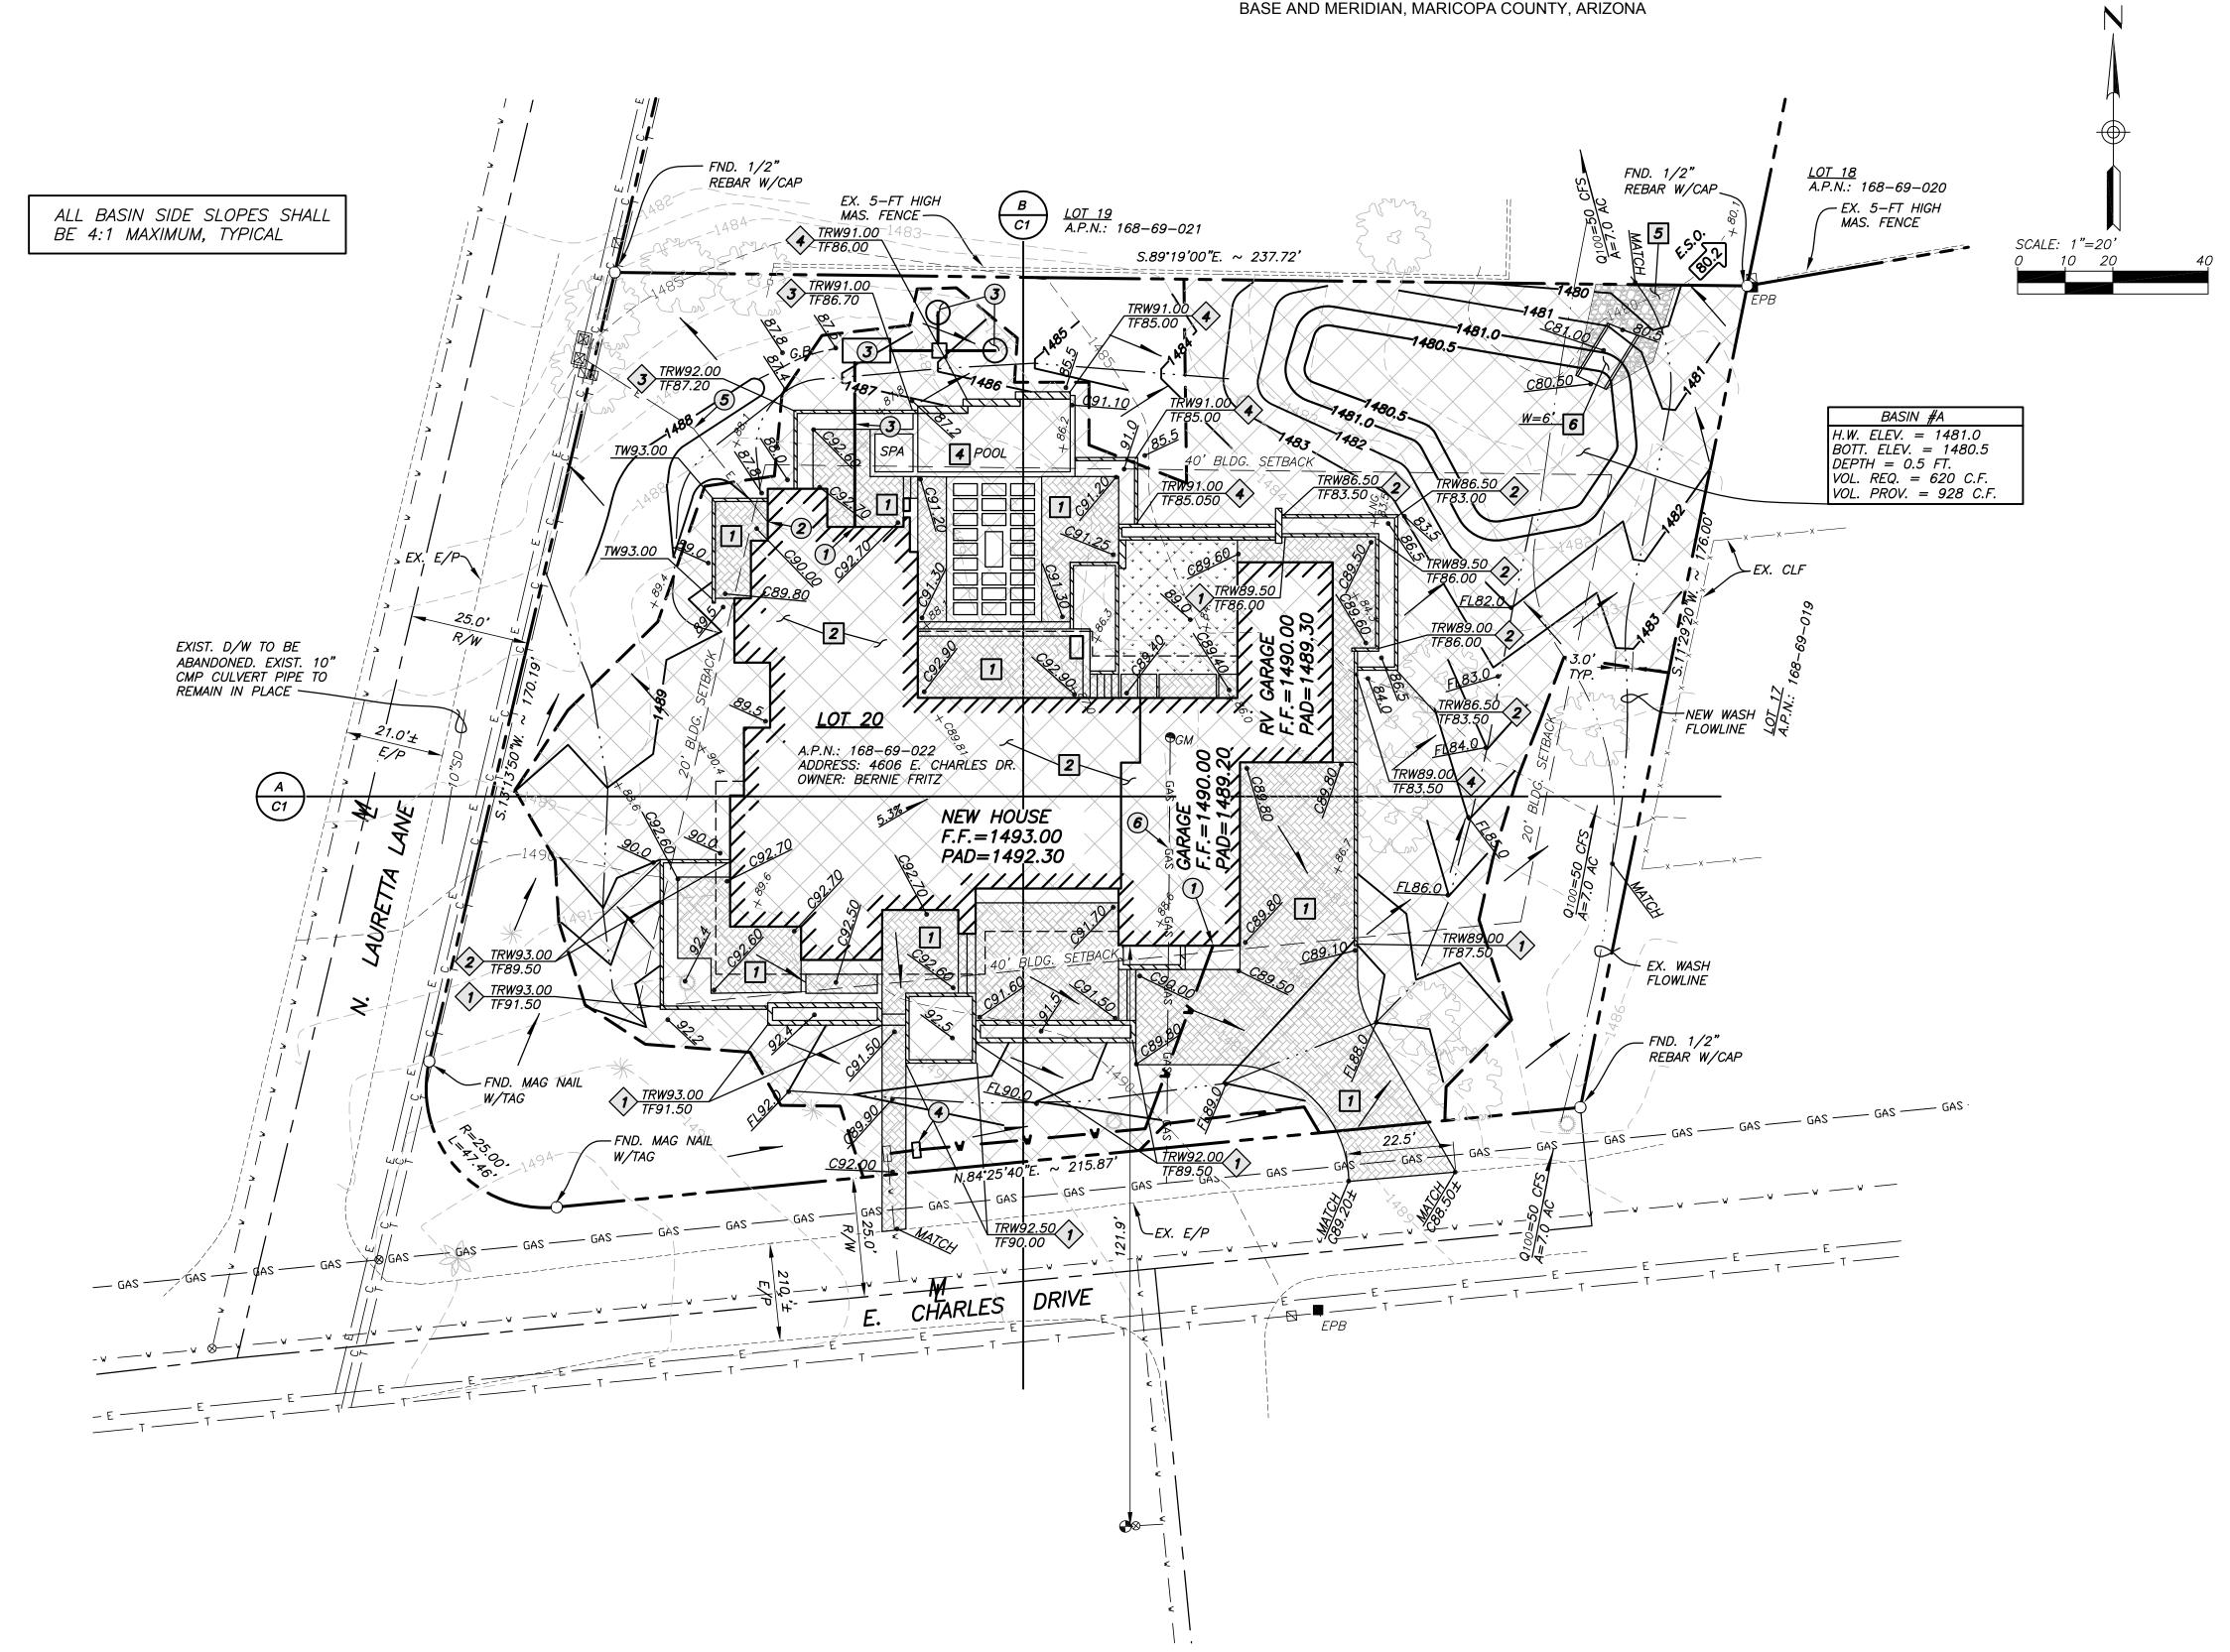

ON-SITE GRADING & DRAINAGE NOTES

1 4" THICK CONCRETE DRIVEWAY AND WALKWAY PER ARCHITECTURAL DRAWINGS AND SPECS.

2 CONSTRUCT BUILDING ON EXISTING CONCRETE SLAB PER ARCH'L AND STRUCTURAL DRAWINGS.

ARCH'L AND STRUCTURAL DRAW

3 NOT USED.

4 POOL AND SPA PER SEPARATE PERMIT.

INSTALL D50 RIP—RAP: 3" TO 6" DIAMETER, ANGULAR GRANITE, HAND PLACED AND INTERLOCKING. OVER NON—WOVEN FILTER FABRIC. RIP—RAP SHALL BE PLACED AT MIN. 8—INCHES BELOW FINISHED GRADE.


6 CONSTRUCT CONCRETE SPILLWAY PER DET. 1/C3.

ON-SITE UTILITY CONSTRUCTION NOTES

- SEE PLUMBING PLANS FOR WATER AND SEWER CONNECTION TO NEW INTERIOR/EXTERIOR PLUMBING FIXTURES.
- PROVIDE NEW 400 AMP ELECTRICAL SERVICE. COORDINATE LOCATION AND UNDERGROUND SERVICES WITH UTILITY CO.
- NEW 4" PVC SANITARY SEWER LINE AND SEPTIC SYSTEM PER SEPARATE PERMIT.
- NEW 3/4" WATER METER AND 1-1/4" DOMESTIC WATER
 SERVICE LINE. REFER TO PLUMBING PLANS FOR APPROVED AND
 TIE-IN LOCATION AT HOUSE.
- APPROXIMATE LOCATION OF NEW UNDERGROUND ELECTRIC
 SERVICE TO PANEL. SEE ELECTRICAL PLANS FOR CONTINUATION
- 6 APPROXIMATE LOCATION OF EXISTING GAS LINE. NEW SERVICE AND LOCATION PROVIDED BY UTILITY COMPANY. REFER TO UTILITY COMPANY PLANS FOR APPROVED LOCATION.

AREA OF NEW LIMITS OF DISTURBANCE

LIMITS OF DISTURBANCE - 32,617 S.F.

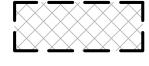

SITE RETAINING WALL SCHEDULE

SITE RETAINING WALL PER ARCH'L DRAWINGS. SEE PLAN FOR TOP OF RETAINING WALL, TOP OF FOOTING ELEVATIONS.

WALL TYPE	RET. WALL HEIGHT (FT.)	SCREEN FENCE	LENGTH (L.F.)
$\langle 1 \rangle$	1'-0" TO 2'-6"	PER ARCH'L	240
2	2'-7" TO 3'-6"	PER ARCH'L	135
3	3'-7" TO 4'-11"	PER ARCH'L	66
4	5'-0" TO 6'-0"	PER ARCH'L	111

TOTAL = 552 L.F.

NOTES:

REFER TO ARCHITECTURAL PLANS FOR SPECIFICATIONS
FOR POOL BARRIER FENCING AROUND THE POOL AREA


TYPICAL.

FOR POOL BARRIER FENCING AROUND THE POOL AREA AND FOR CONNECTION TO TOP OF RETAINING WALLS.

2. TOP OF RETAINING WALL HEIGHTS SHALL NOT EXCEED 6—INCHES ABOVE FINISHED GRADE OF RETAINED SOIL,

Consulting engineers, IIC

18223 westorchid lane
RESTROTED TO THE PREPARED AND THE PREPARED

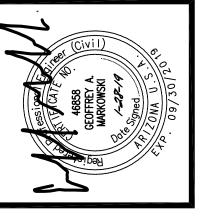

CHARLES DRIVE RESIDENCE

4606 E. CHARLES DRIVE, PARADISE VALLEY, ARIZONA

OWNER:

ABF INVESTMENTS, LLC

16202 S. 31ST WAY, PHOENIX, ARIZONA 85048


CD 11-21-18 1ST CITY SUBMITTAL	2ND CITY SUBMITTAL	3RD CITY SUBMITTAL		
11-21-18	CD 01-08-19	CD 01–28–19		
аэ	аэ	аэ		

DATE ISSUED: 22 AUG 18
DRAWN BY: GM/AD
CHECKED BY: GM

SHEET DESCRIPTION:


GRADING
&


DRAINAGE PLAN

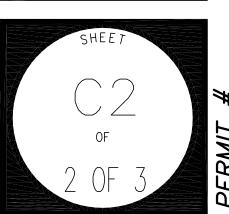


ALL NATIVE PLANTS IMPACTED BY CONSTRUCTION SHALL BE RELOCATED ON—SITE. SEE LANDSCAPE PLANS AND NATIVE INVENTORY & SALVAGE PLAN.



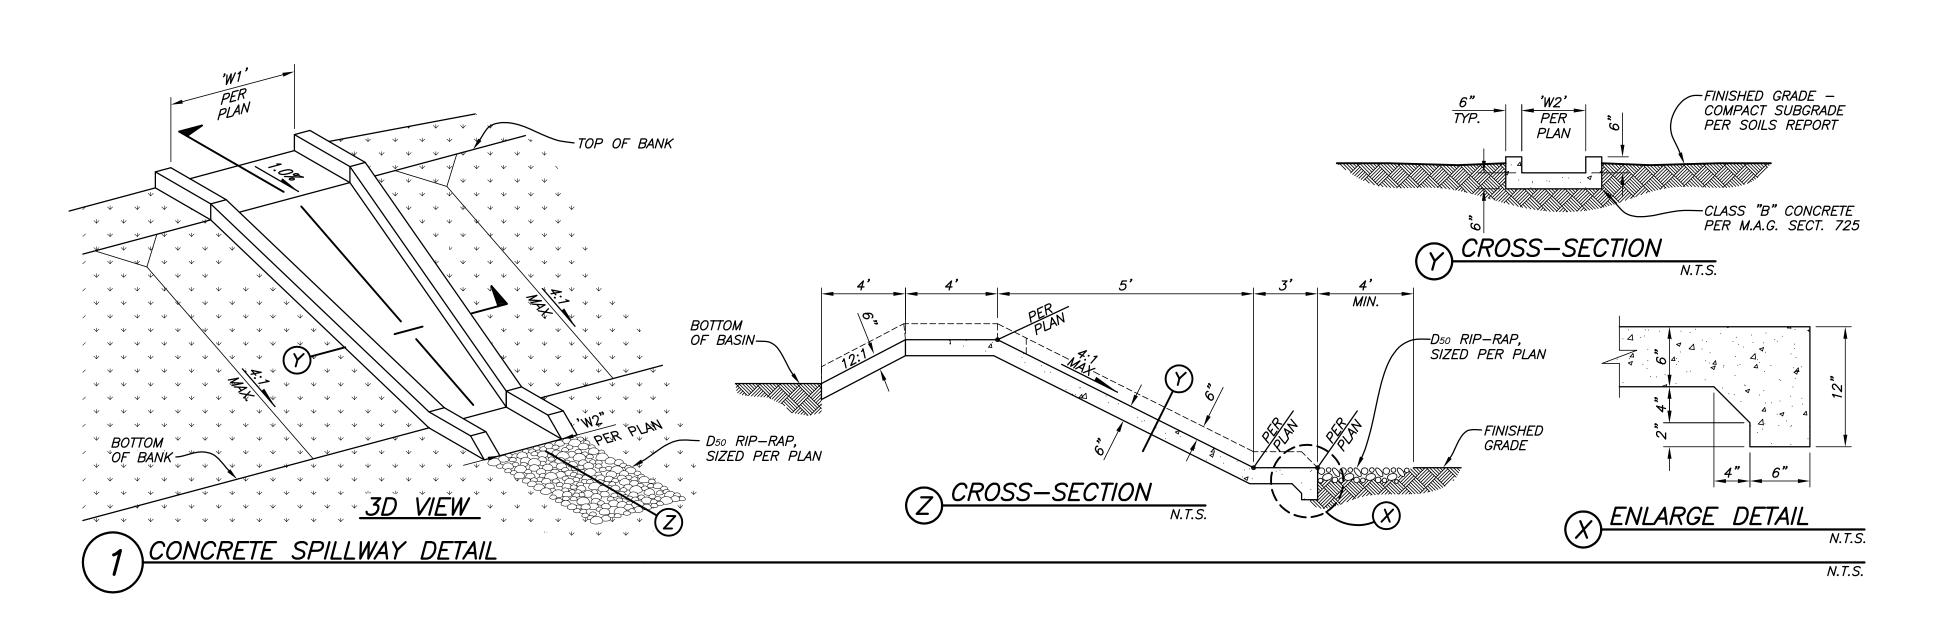

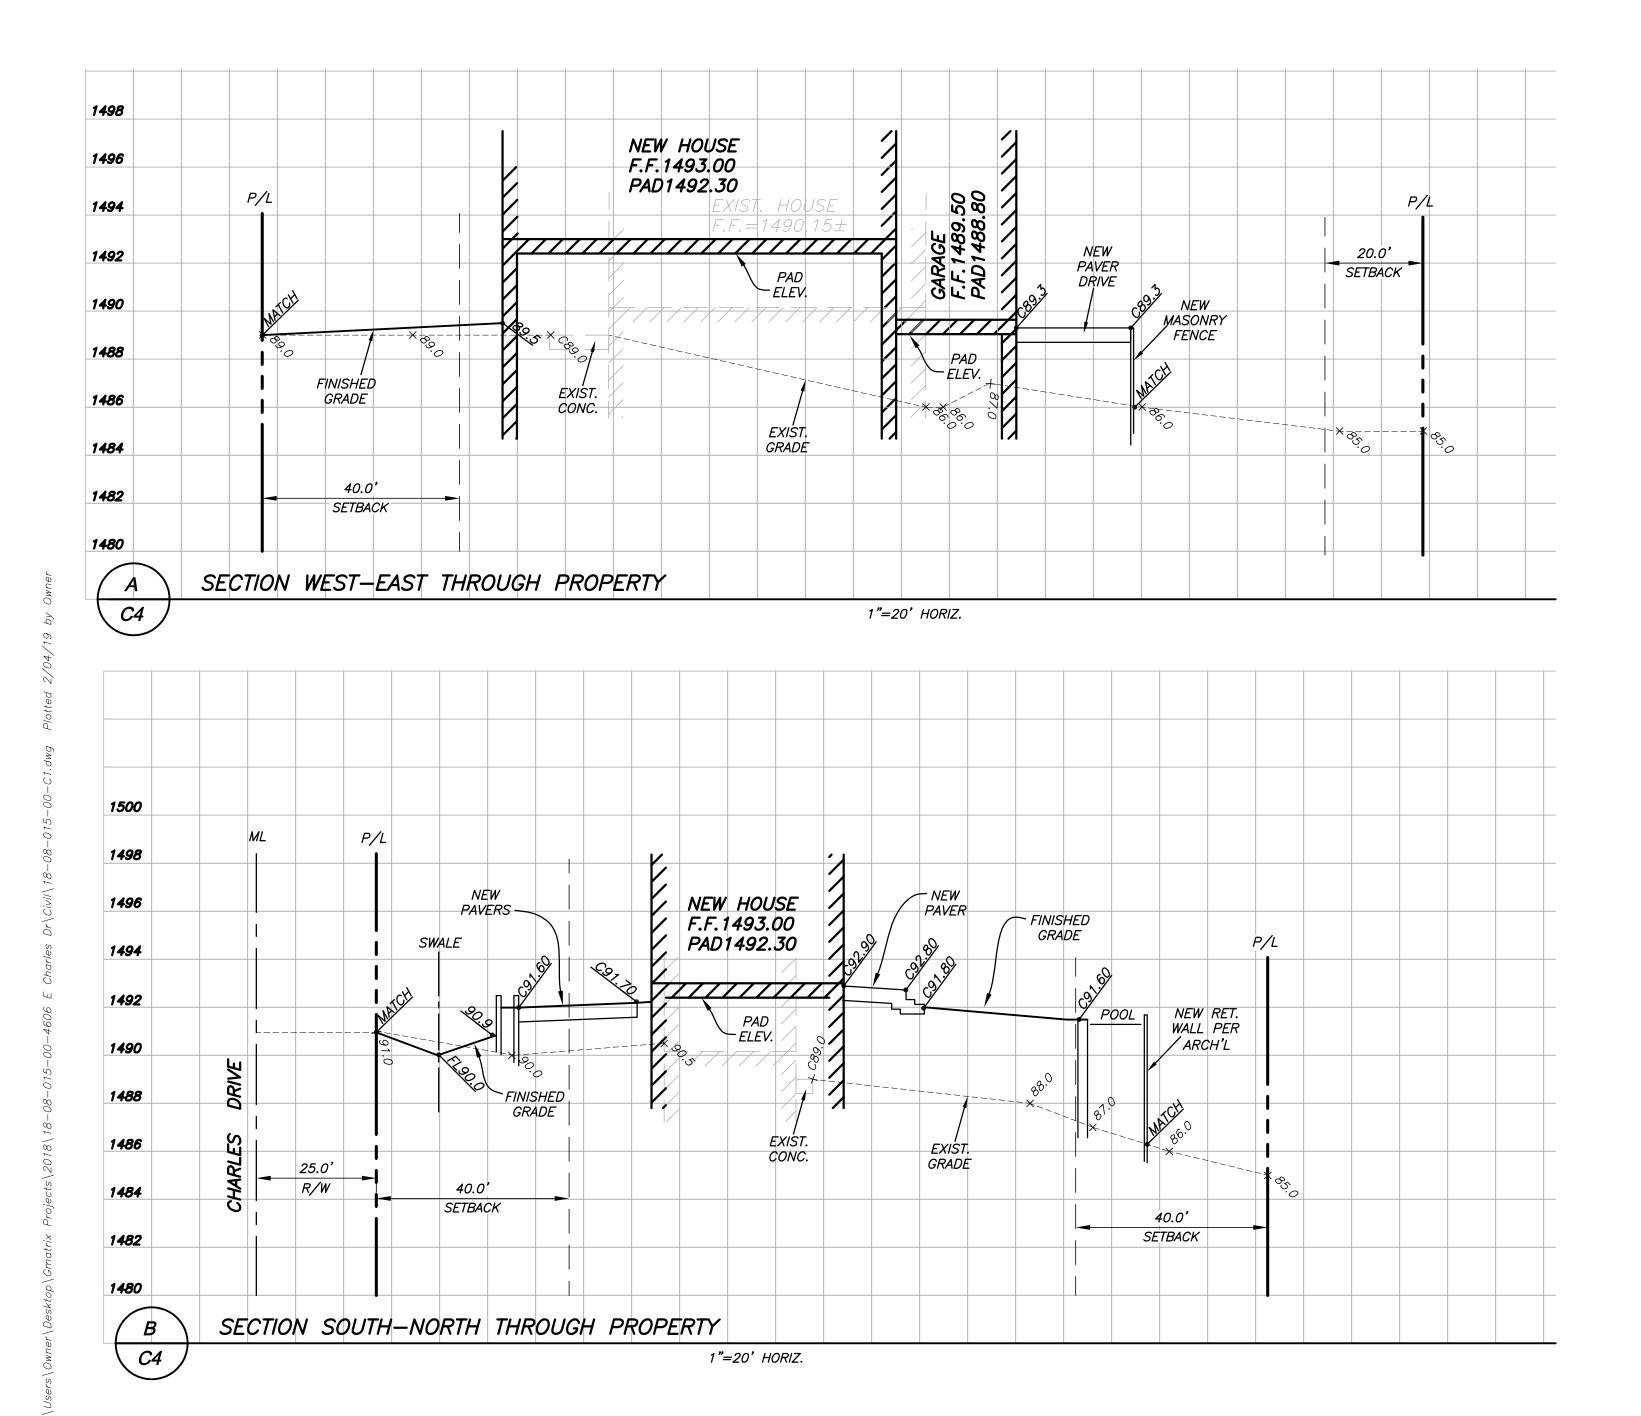



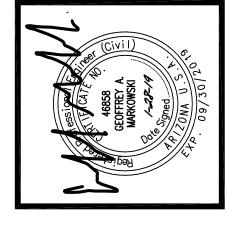

CD 11-21-18 1ST CITY SUBMITTAL	2ND CITY SUBMITTAL	3RD CITY SUBMITTAL		
11-21-18	01-08-19	CD 01-28-19		
аэ	СО	СО		


DATE ISSUED: 22 AUG 18
DRAWN BY: GM/AD
CHECKED BY: GM


SHEET DESCRIPTION:

SECTIONS

AND

DETAILS

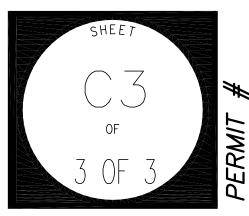

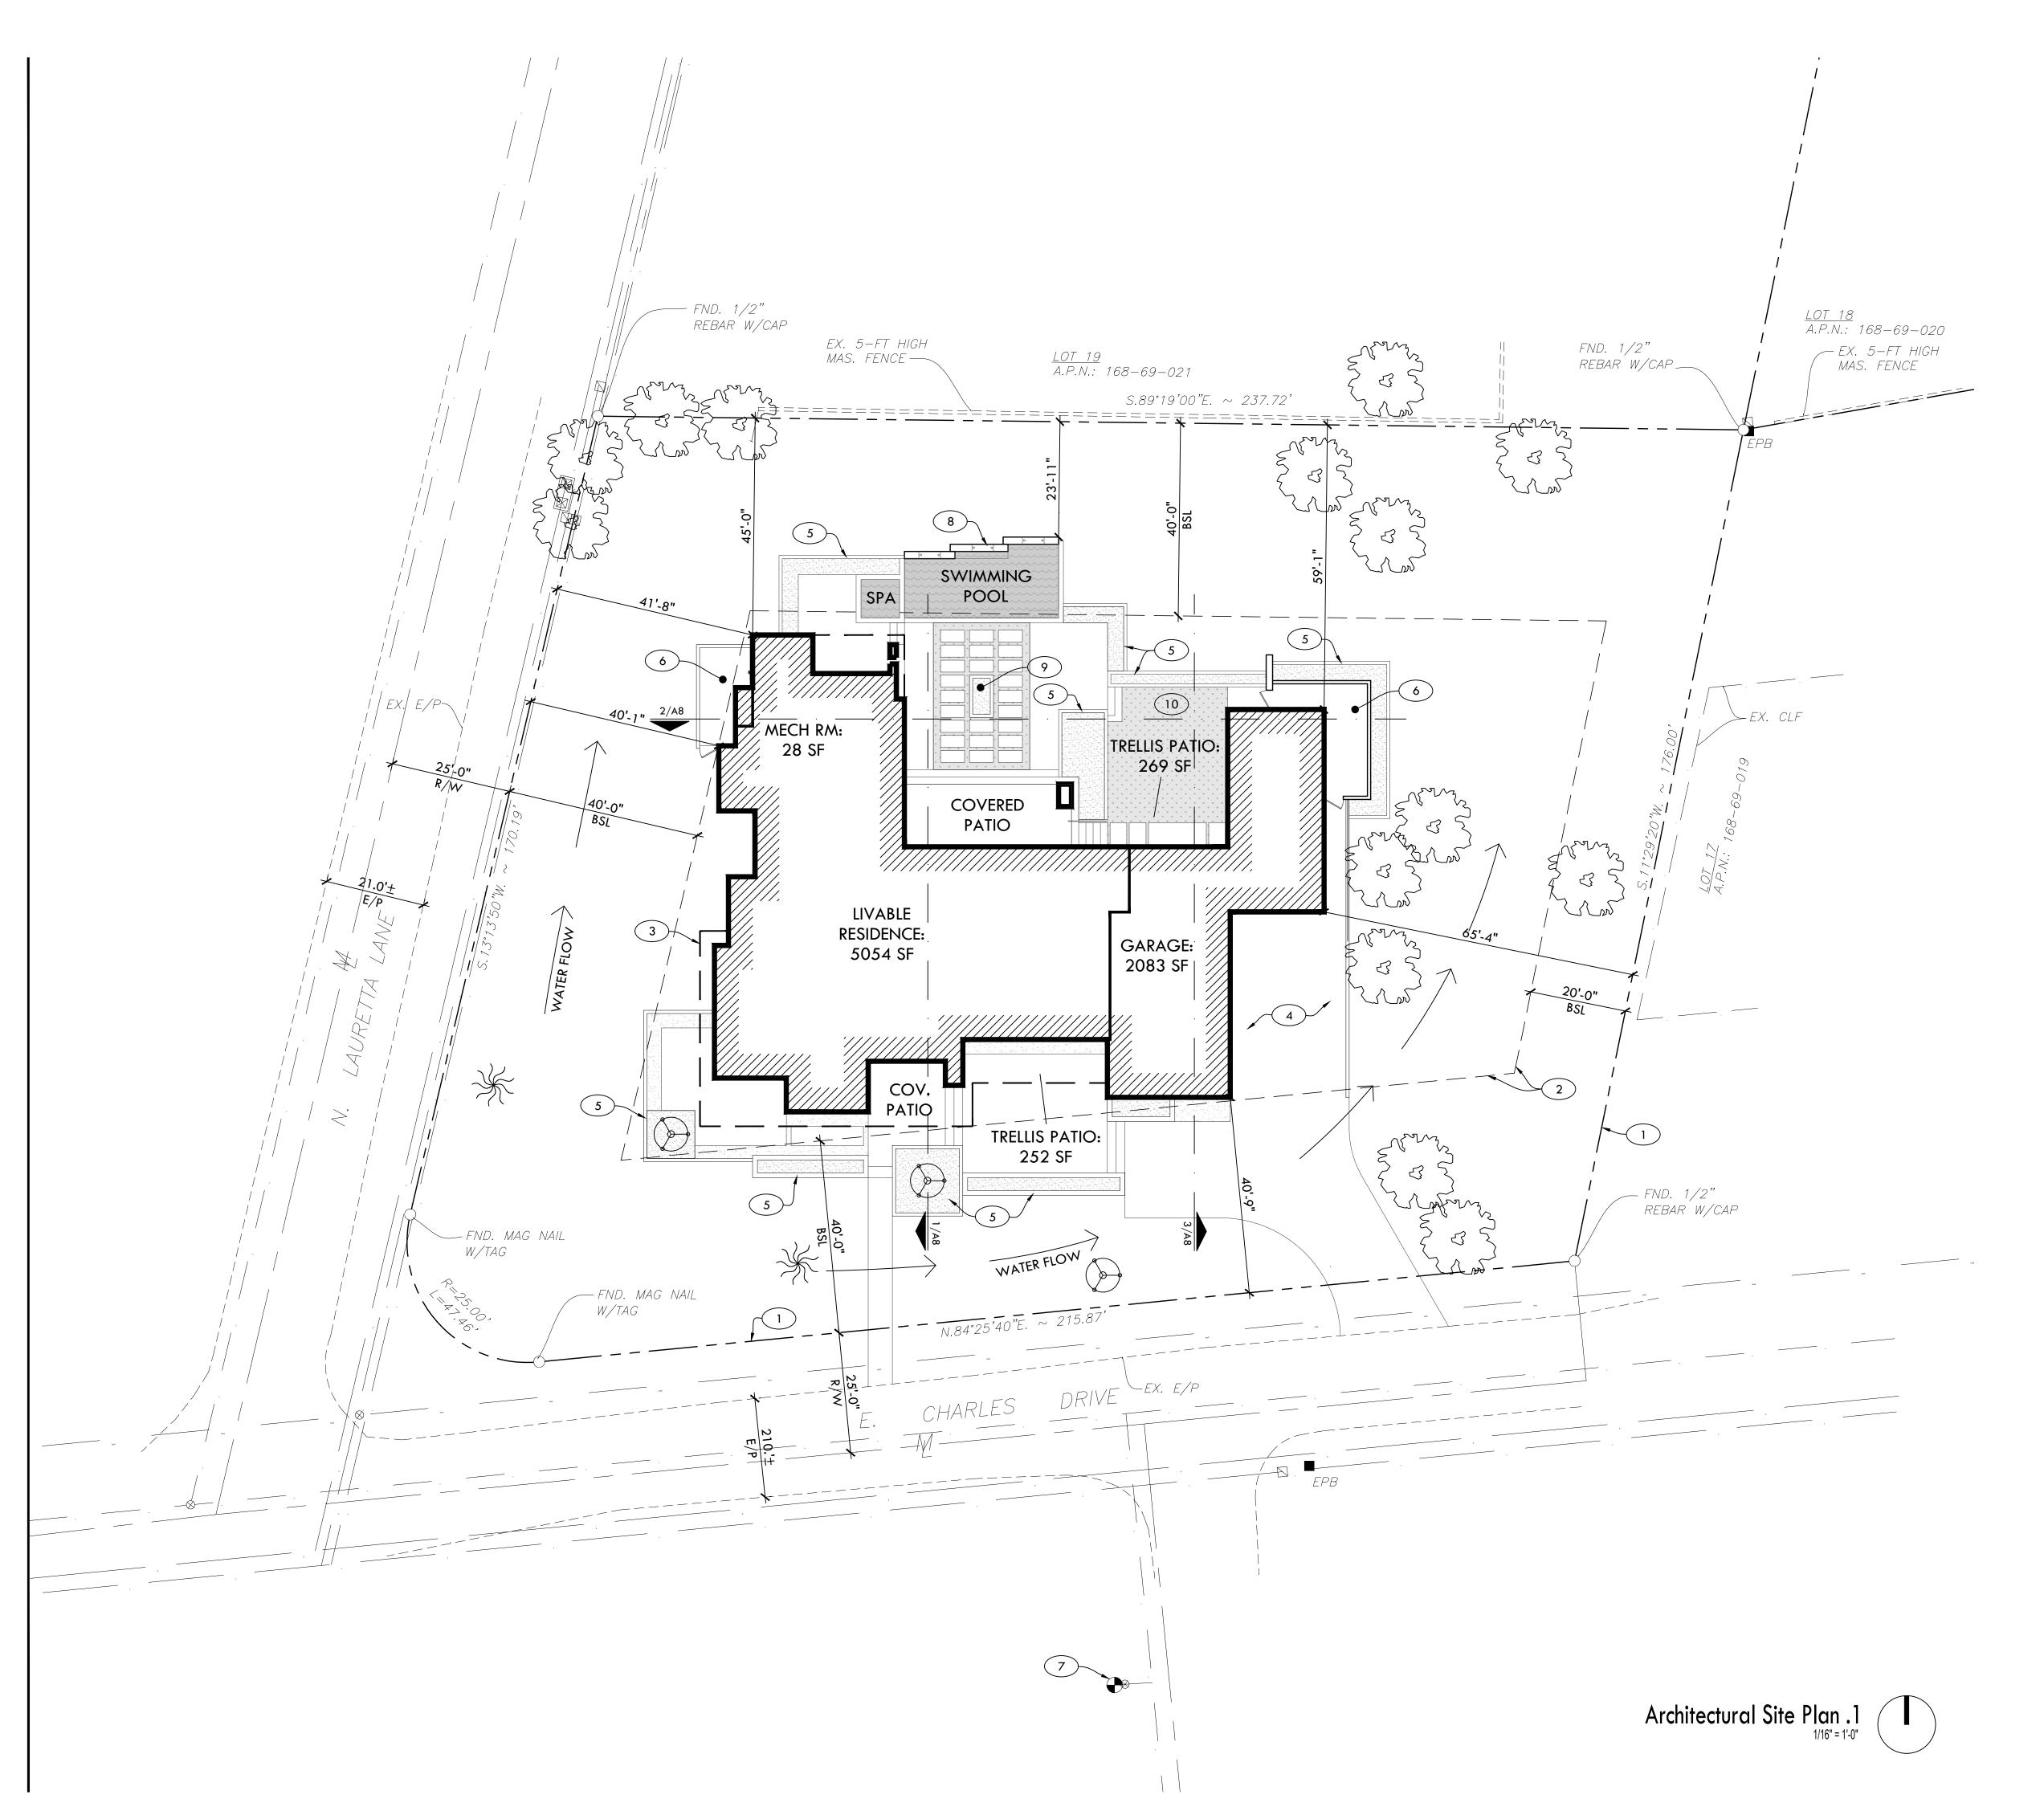

Keynotes

- 1. Property line.
- 2. Building setback.
- 3. Roof overhang above.
- 4. New paver driveway.
- 5. Raised planter retaining wall, typ.
- 6. Screened mechanical / equipment area.
- 7. Existing fire hydrant.
- 8. Water feature accessory structure for swimming pool.
- 9. Gas fire pit.
- 10. Artificial grass lawn.



Fit Designs, PLLC 15459 S. 44th Way Phoenix, Arizona 85044 480.205.4515 fitdesigns@live.com

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Charles Dr. A506 E. Charles Dr.

DATE: 1/28/19
SCALE: As Noted


 DRAWN:
 JPL


 JOB:
 18-99

SHEET:

A4

Site Plan

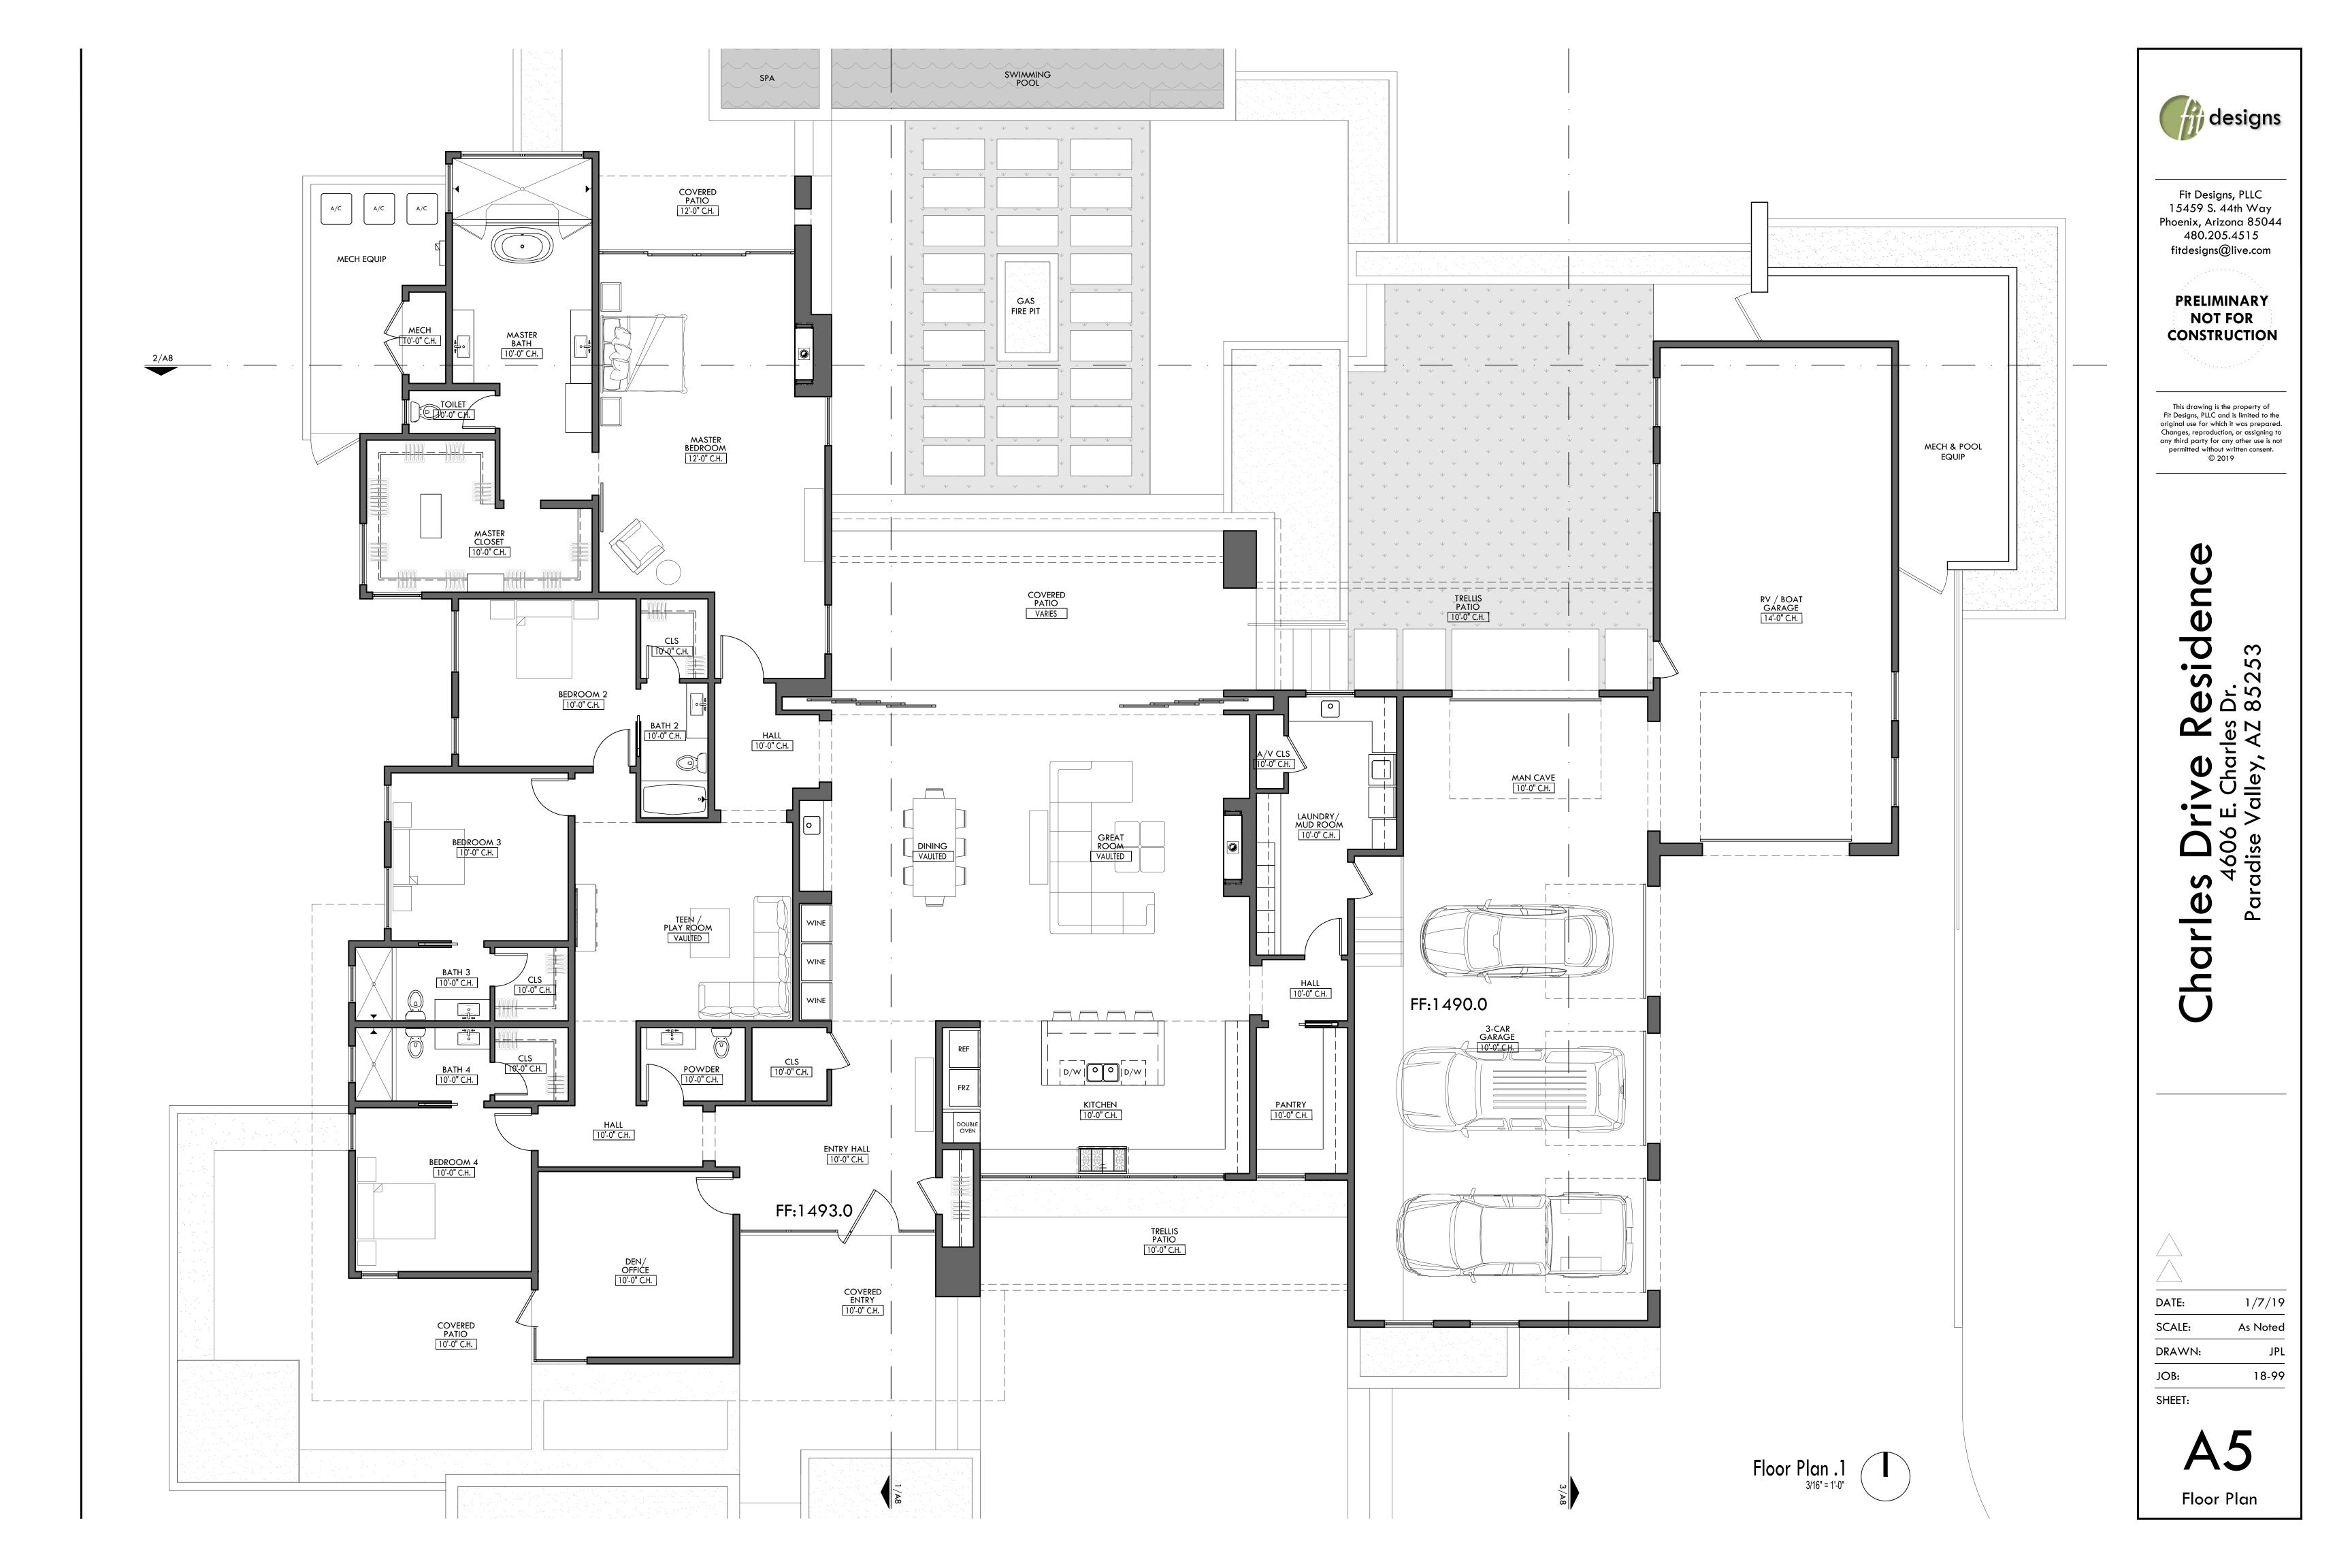

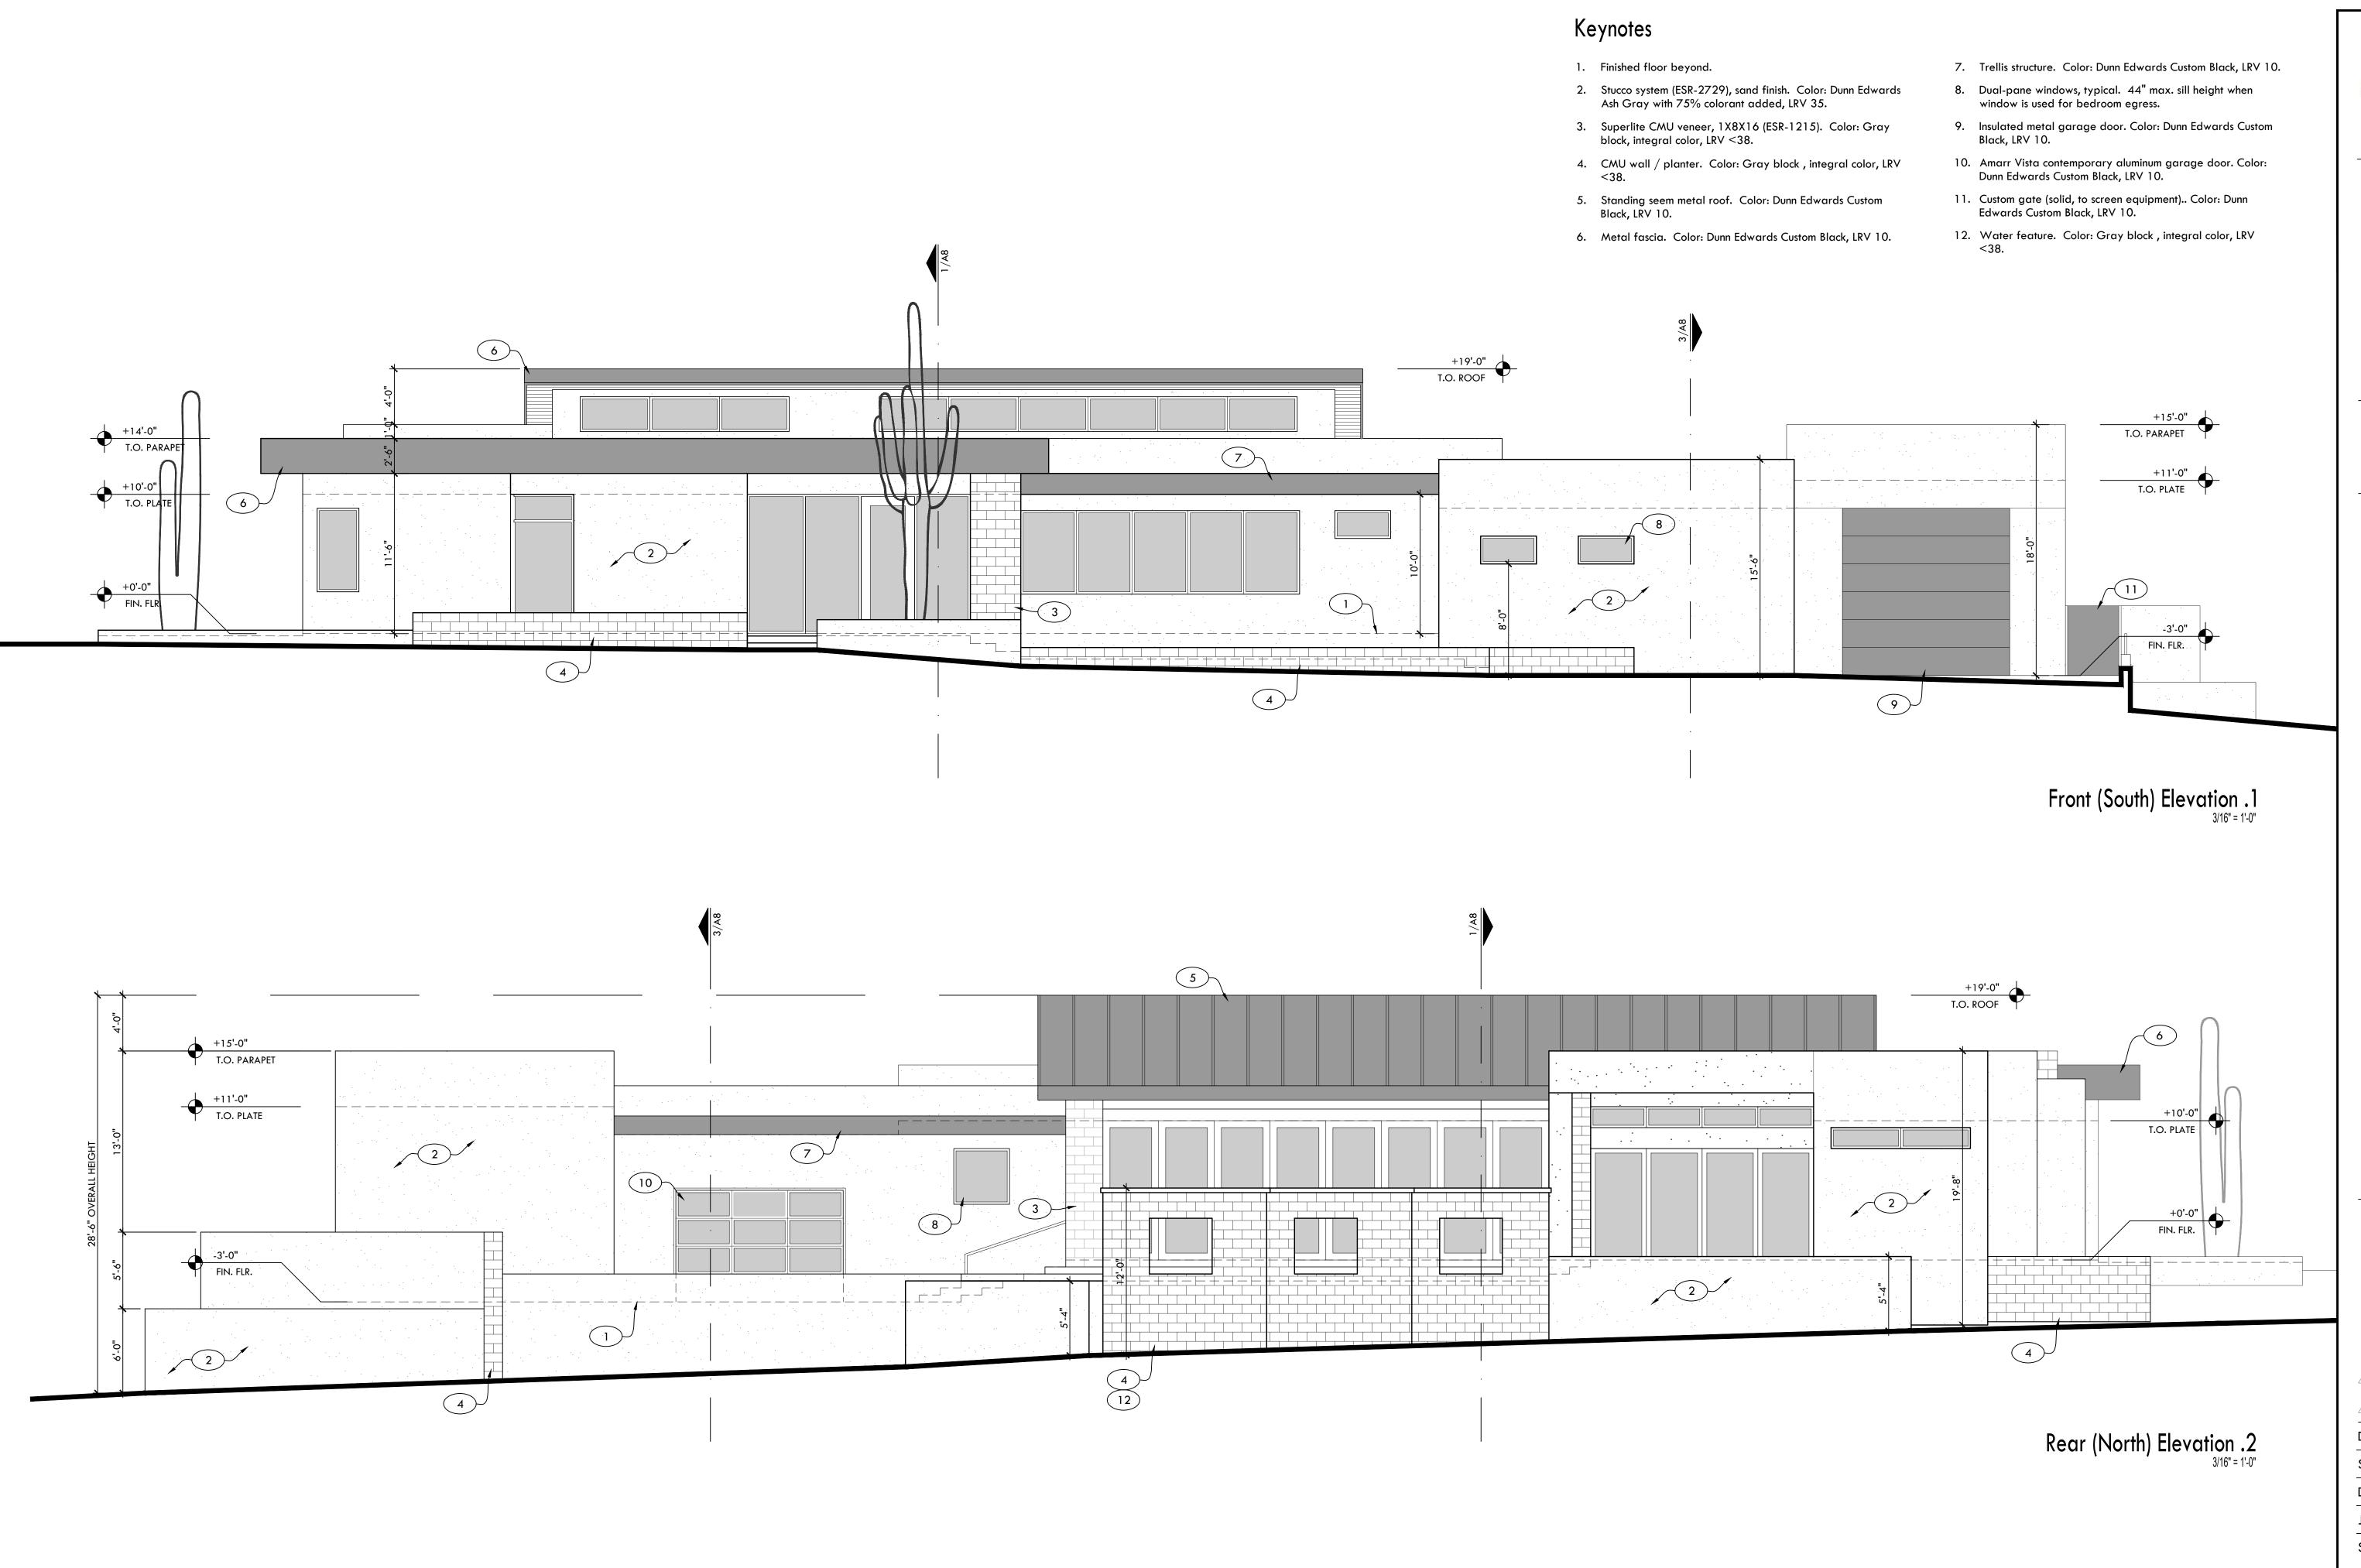



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DATE: 1/28/19

SCALE: As Noted


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SHEET:

A6

Elevations



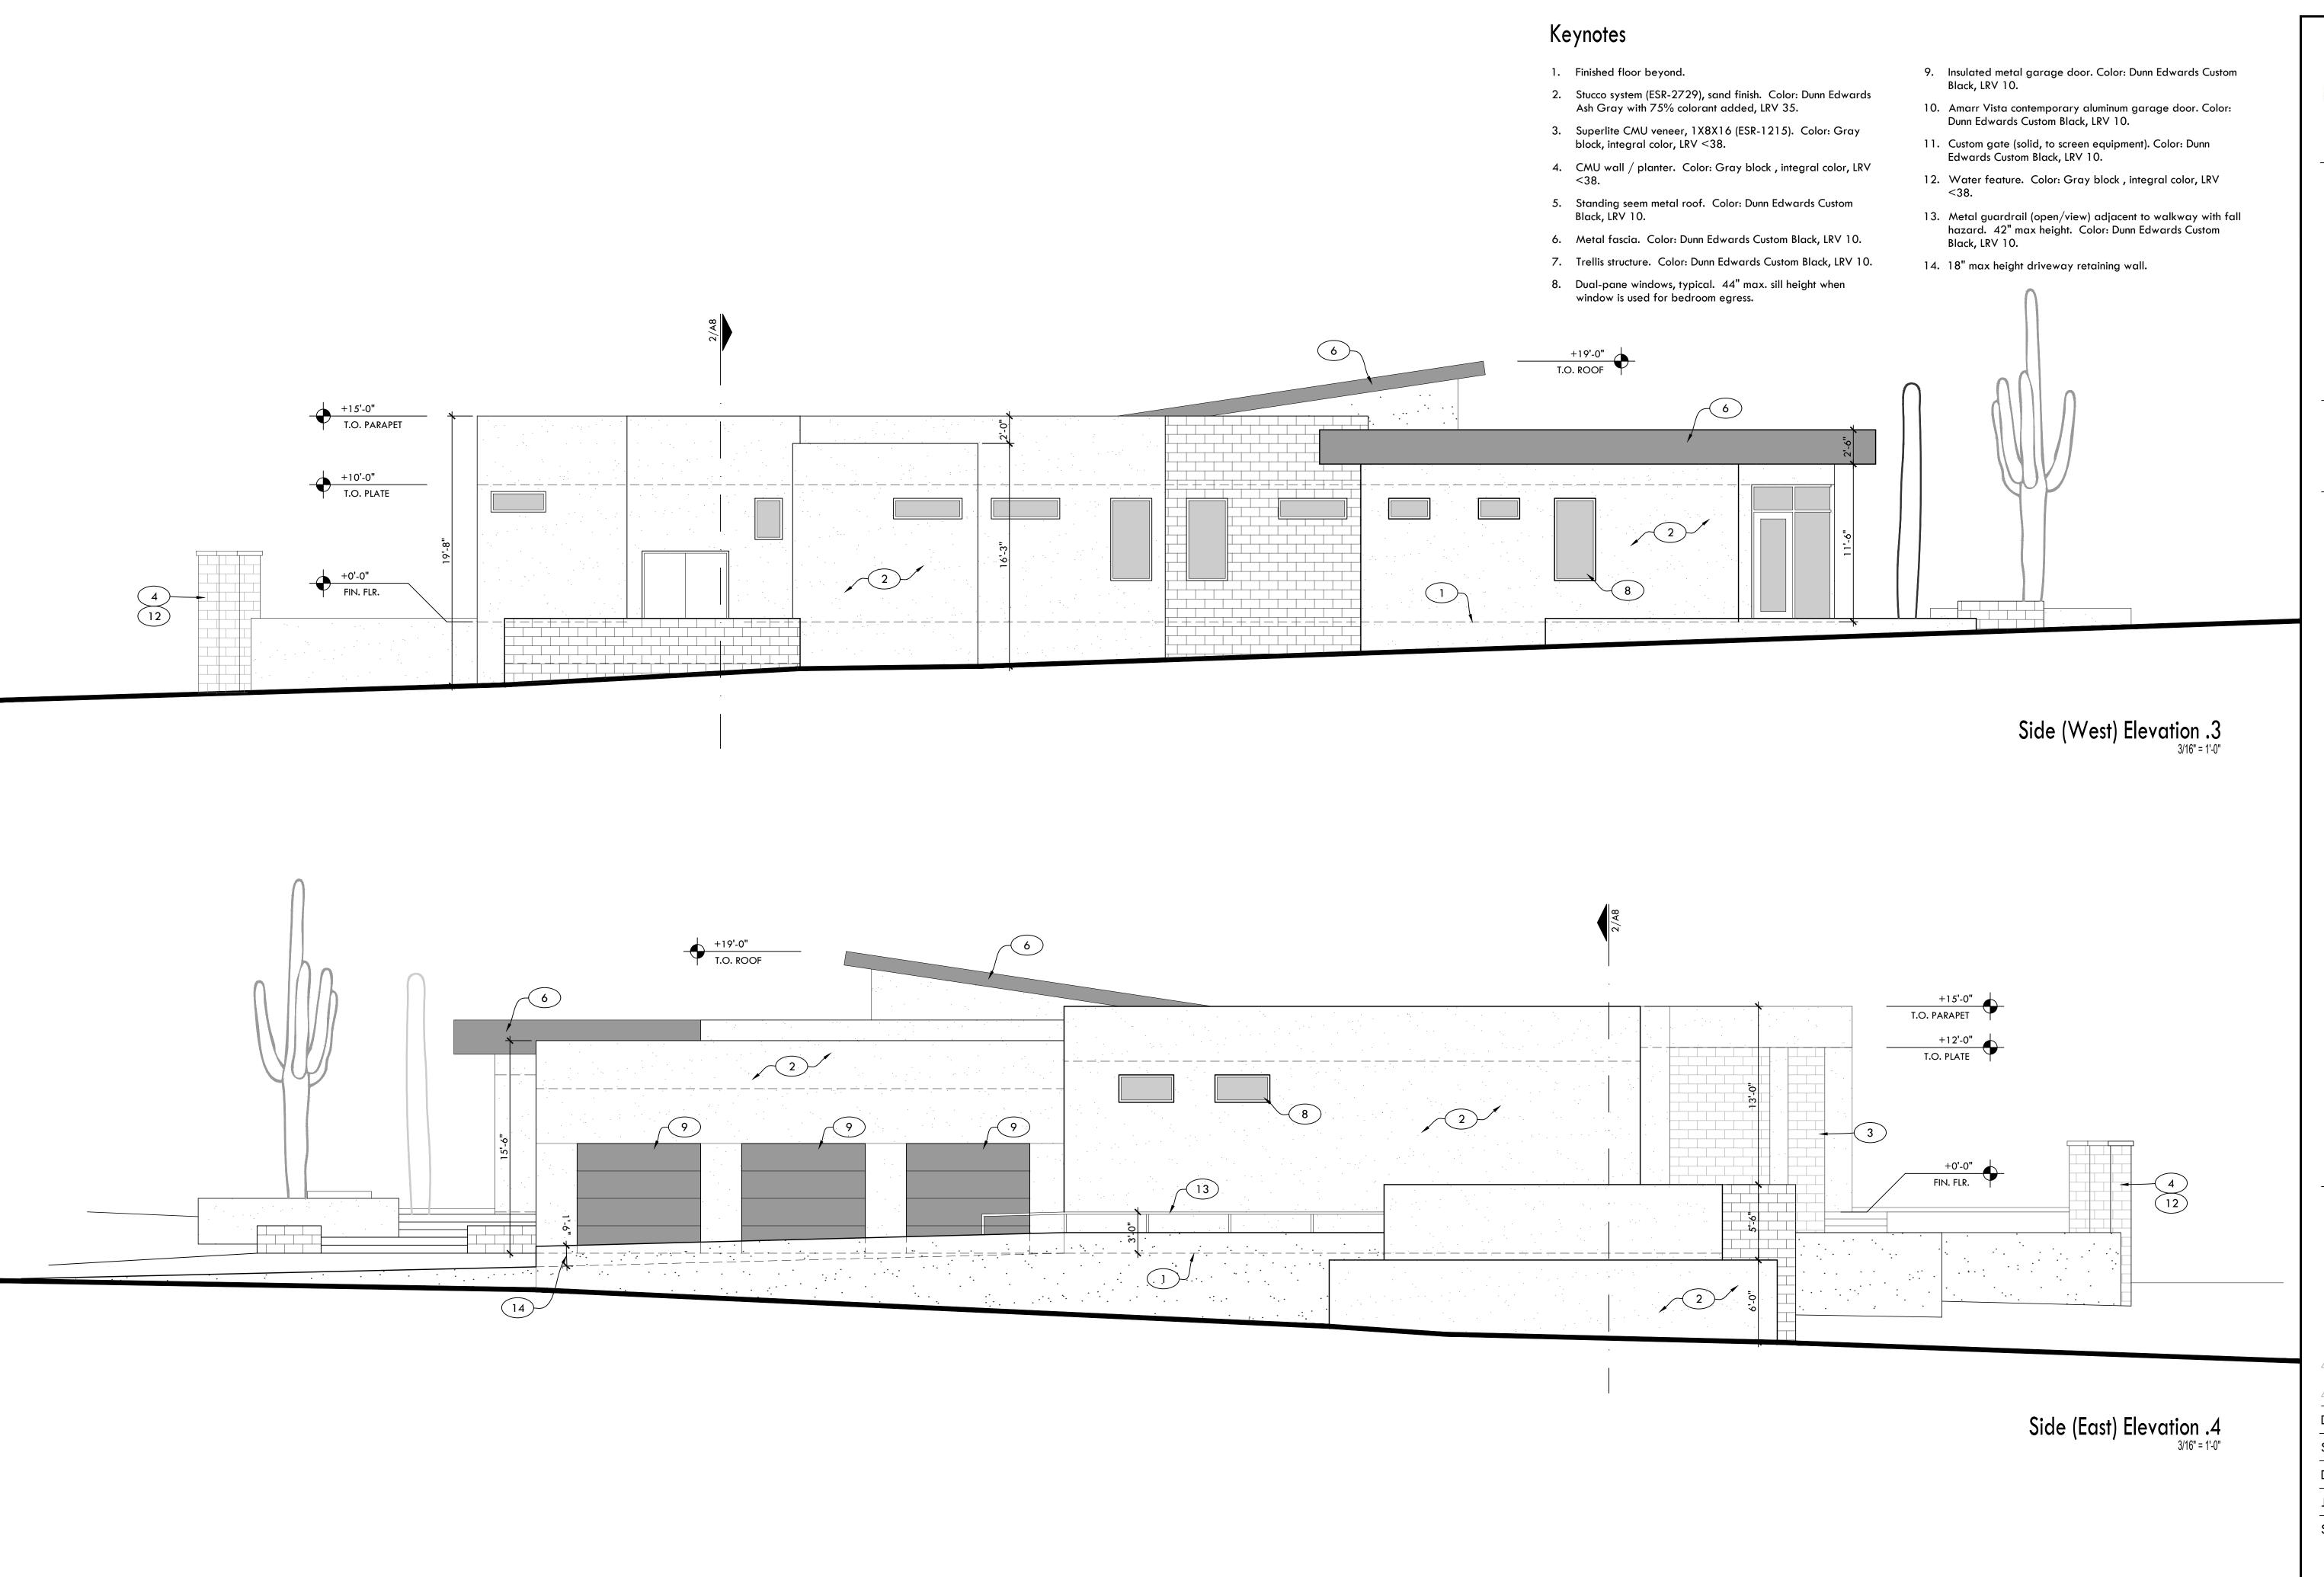

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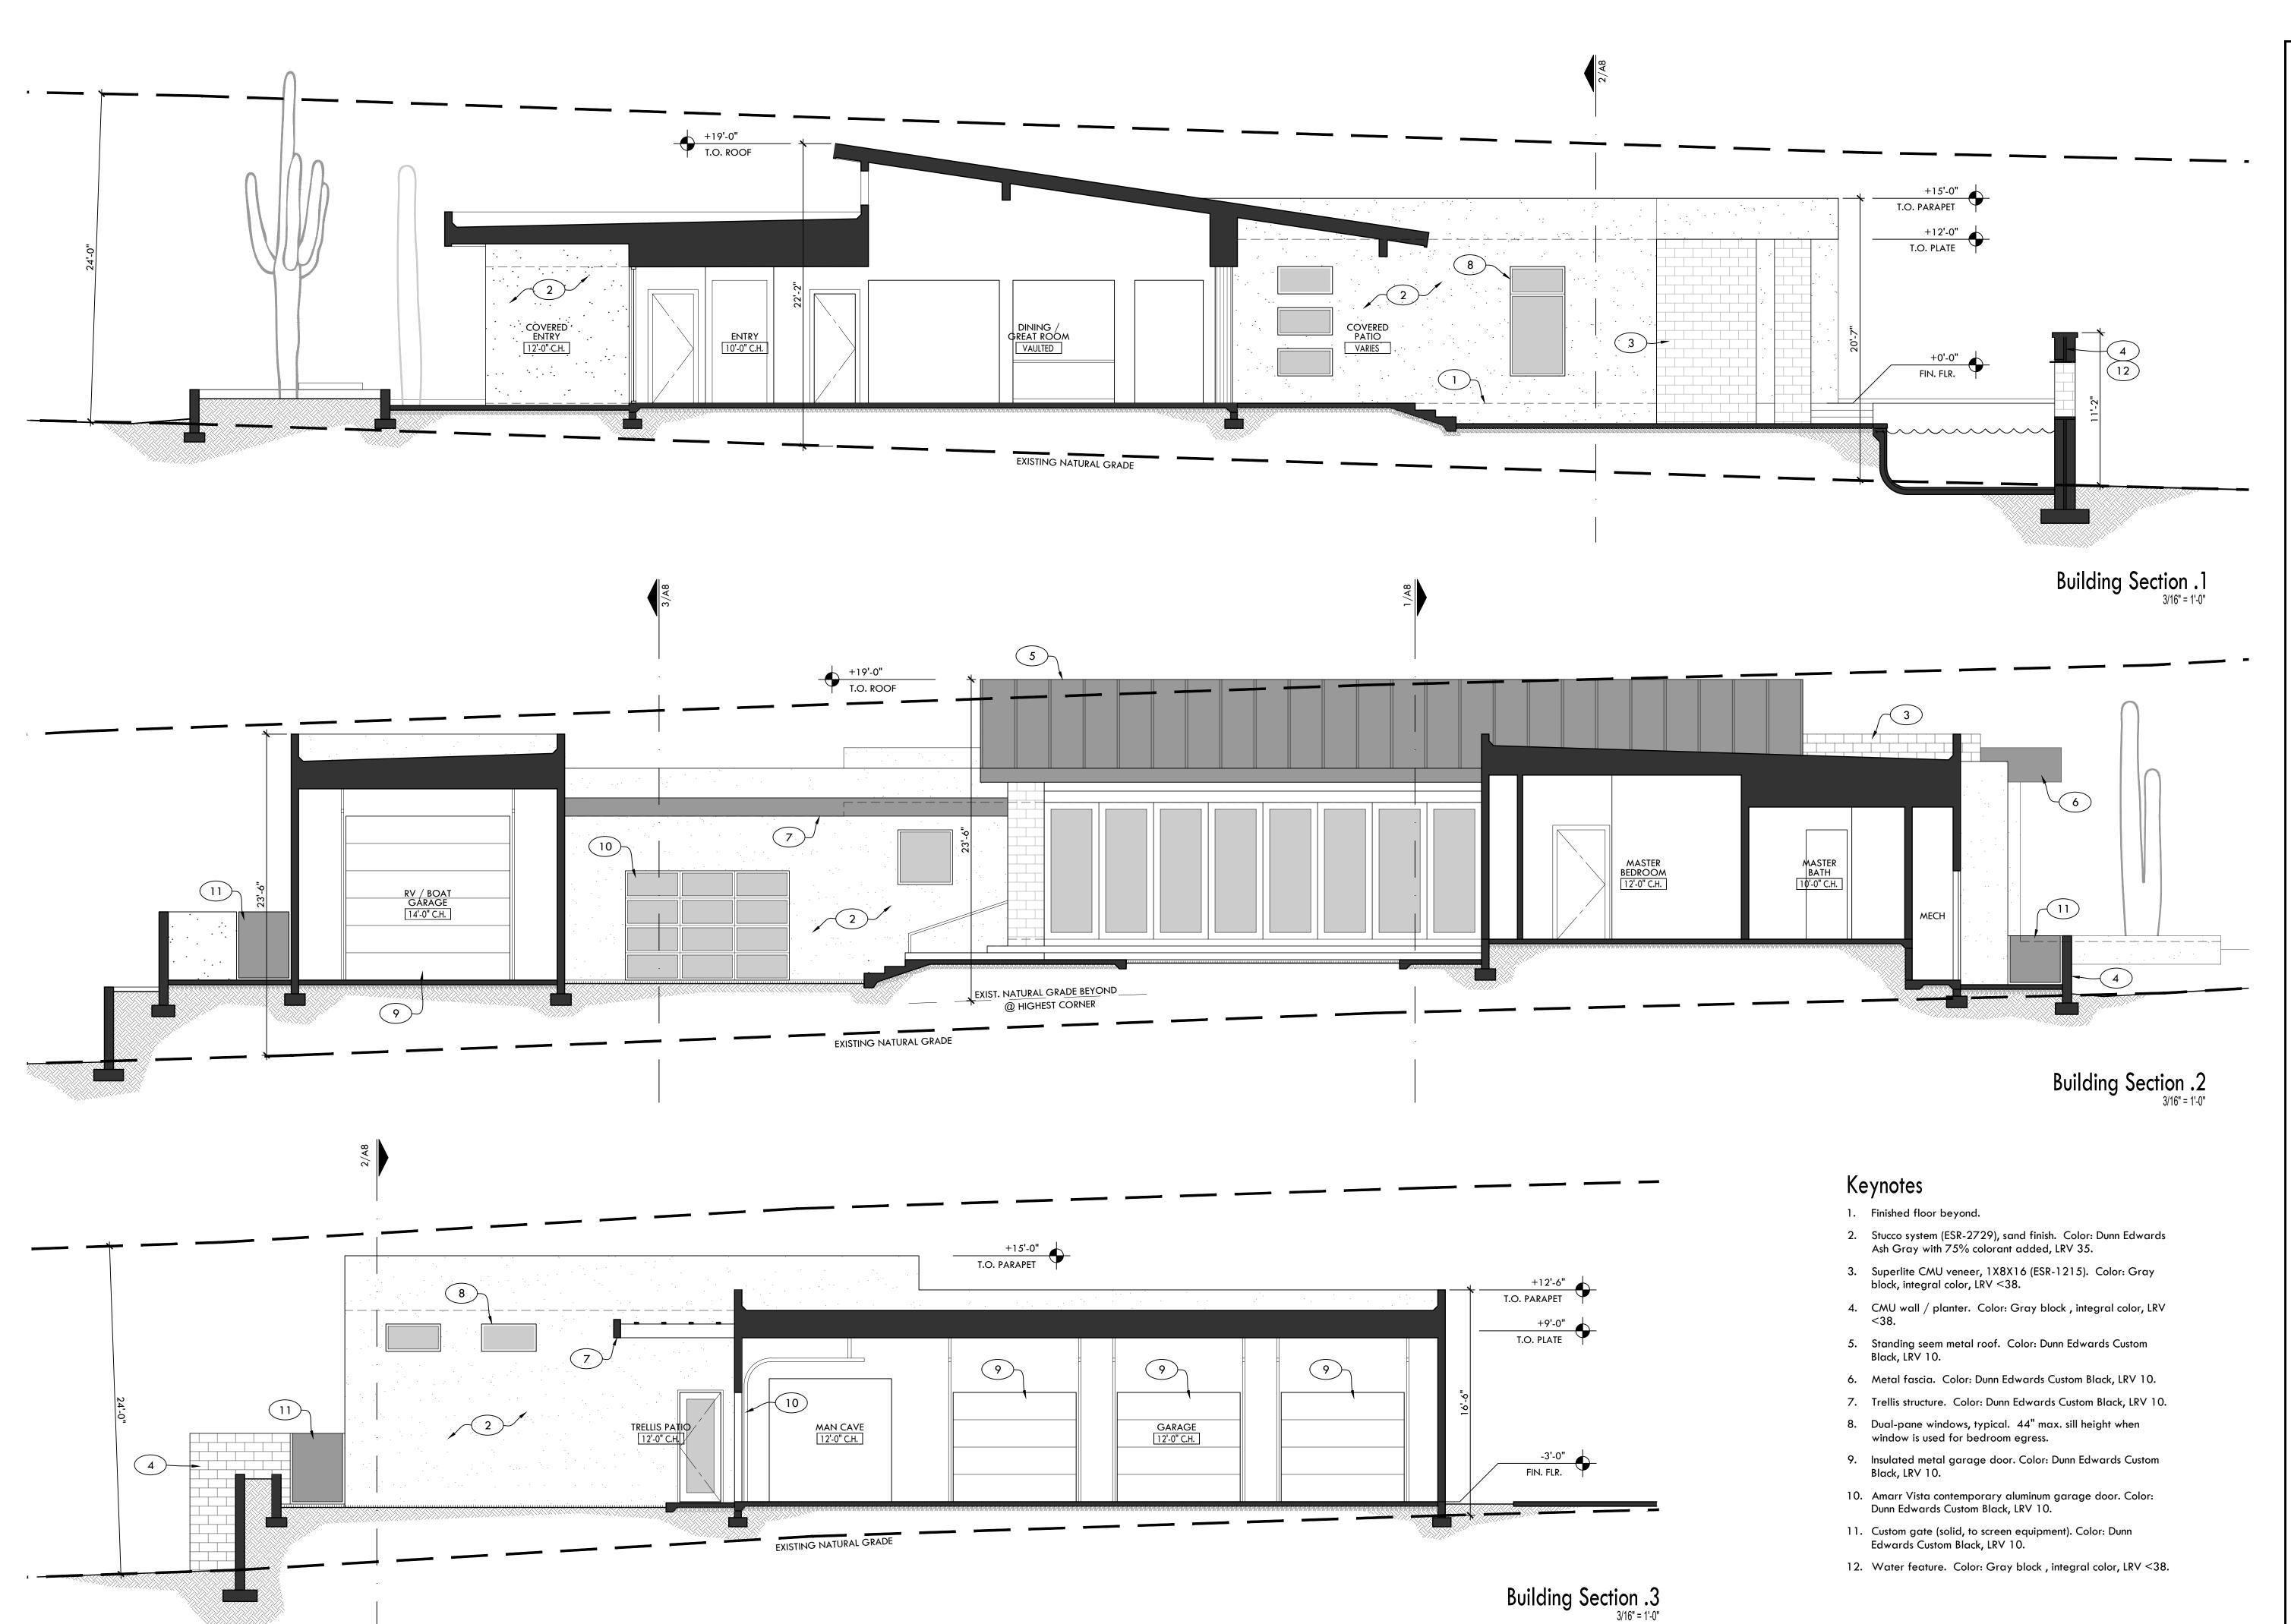
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SHEET:

Elevations





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SCALE: As Noted

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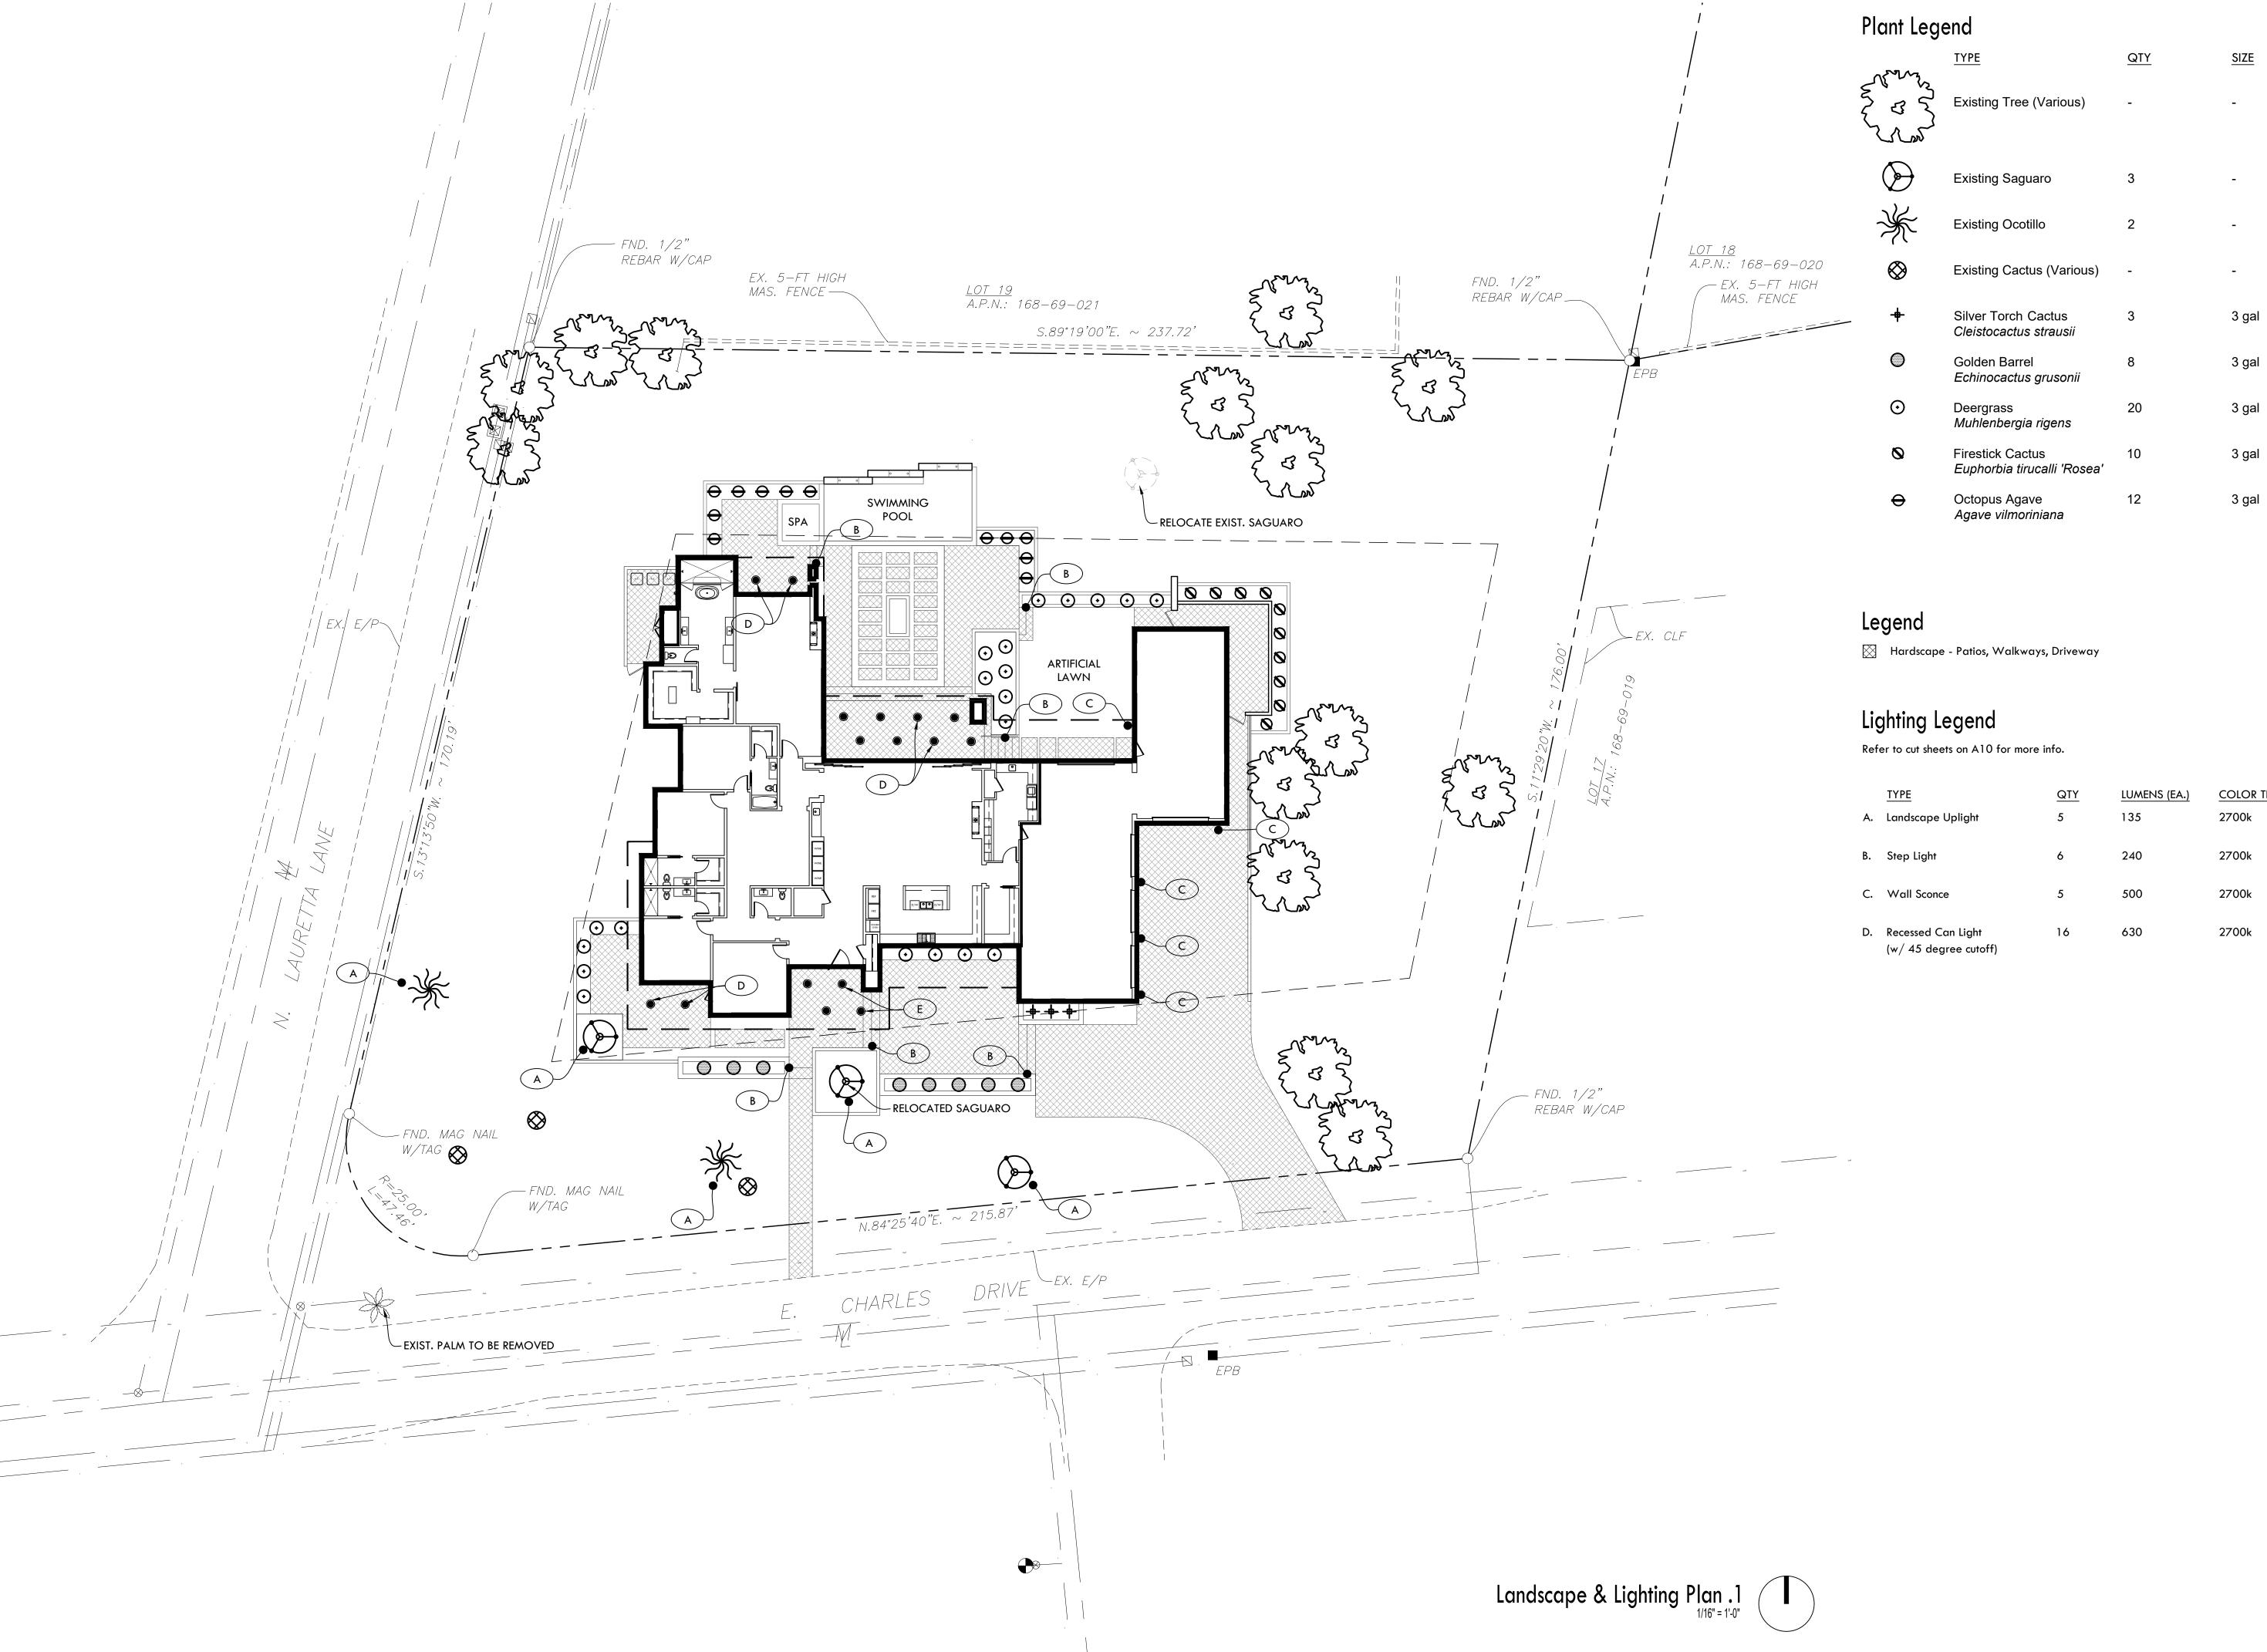
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JOB: 18-99

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Cross Sections





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	TYPE	QTY	LUMENS (EA.)	COLOR TEMP
Α.	Landscape Uplight	5	135	2700k
В.	Step Light	6	240	2700k
C.	Wall Sconce	5	500	2700k
D.	Recessed Can Light (w/ 45 degree cutoff)	16	630	2700k

sidence **Φ** Δ δ

1/28/19 DATE: SCALE: As Noted JPL 18-99 JOB: SHEET:

Landscape / Lights

Yes Yes Yes 690 Yes Yes Yes 700 Yes Yes Yes Yes Yes Yes Yes Yes

Light

7

 $\widetilde{\mathbf{Z}}$

 \Box

Tuscan Bronze TL402TBZS







designs

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Q

DATE: 1,

DATE: 1/28/19

SCALE: As Noted

DRAWN: JPL

JOB: 18-99

A10

SHEET:

Lighting Cut Sheets