project consultants

TITLE

desert pavement note:

AFTER EXISTING PLANT MATERIAL IS REMOVED/SALVAGED,

PAVEMENT TOP-DRESSING. ALL MATERIAL (ROOTS & SEEDS

INCLUDED) LOCATED WITHIN THE TOP 2" OF THE SALVAGED

GRADING CONTRACTOR WILL COLLECT THE TOP 2" OF ALL

THE END OF PROJECT TO BE USED AND DISTRIBUTED AS DESERT

MATERIAL TO REMAIN. DESERT PAVEMENT TO BE BLENDED WITH

THE EXISTING DESERT LANDSCAPE FOR A NATURAL APPEARANCE.

wild seed - sonoran desert

BOTANICAL NAME

ENCELIA FARINOSA

AMBROSIA DELTOIDES

ARTIPLEX POLYCARPA

ARTIPLEX LENTIFORMIS

LARREA TRIDENTATA

ARISTIDA PURPUREA

PLANTAGO PURSHII

SIMMONDSIA CHINENSIS

GUTIERREZIA SATOTHRAE

SENNA COVESII

upland reveg. mix 11bs. /2000 s.f.

AREAS TO BE DISTURBED AND STOCK PILE IT FOR REPLACEMENT AT

COVER SHEET & NOTES

LIGHTING PLAN & DETAILS

LANDSCAPE & IRRIGATION DETAILS

LANDSCAPE PLAN

NEIL MORAN 7026 NORTH 40TH STREET PARADISE VALLEY, ARIZONA CONTACT: NEIL MORAN PHONE: 303.913.5999 EMAIL:neil@4closedreo.com

landscape architecture: DESIGN ETHIC, LLC

7201 E. CAMELBACK #250 SCOTTSDALE, ARIZONA 85251 CONTACT: BRANDON PAUL PHONE: 480.225.7077 EMAIL:bpaul@designethic.net

sheet index

SHEET

L.02 - L.03

L.04 - L.05

L.01

L.06

DAVID DICK ARCHITECT 7400 EAST MCDONALD DRIVE #122 SCOTTSDALE, ARIZONA 85250 CONTACT: DAVID DICK

PHONE: 480.945.1898 EMAIL:dd@ddarchstudio.com

PHOENIX, AZ 85020

PHONE: 602.889.1984

EMAIL:nick@ldgeng.com

civil engineering: LAND DEVELOPMENT GROUP, LLC 8808 NORTH CENTRAL AVE. #288 CONTACT: NICK PRODANOV

AND PLACEMENT OF TREES AND PALMS UNLESS THE LOCATION WAS

ANY BUILDING WALLS OR BUILDING WINDOWS WHEN THE PLANT REACHES IT'S MATURE SIZE.

NURSERY ASSOCIATION STANDARDS. PLANT MATERIAL SIZES NOT ESTABLISHED PER A.N.A. STANDARDS SHALL BE SIZED ACCORDING TO THE AMERICAN ASSOCIATION OF NURSERYMEN STANDARDS 9. ALL NEWLY INSTALLED TREES ARE TO BE STAKED IN PLACE PER THE

WITHIN THE LANDSCAPE ARCHITECT'S DETAIL AND SPECIFICATION BOOKLET DEVELOPED FOR THE PROJECT.

LOCATIONS TO ENSURE PLANT HEALTH AND VITALITY. 11. SUB-CONTRACTOR TO TREAT ALL D.G. AREAS WITHIN THE LIMITS OF CONSTRUCTION WITHONE FINAL APPLICATION OF AN APPROVED

OTHERWISE NOTED OR IDENTIFIED WITHIN THE LANDSCAPE ARCHITECT'S IRRIGATION DRAWINGS. 13. NO PLANT SUBSTITUTIONS, TYPE, OR QUANTITY DEVIATIONS FROM THE

FROM THE LANDSCAPE ARCHITECT.

WILL BE REPLACED IN KIND BY THE CONTRACTOR. 15. ALL LANDSCAPE AREAS SHALL RECEIVE 2" DESERT PAVEMENT UNLESS NOTED. COLOR TO BE SELECTED BY OWNER UNLESS NOTED. ALL D.G.

APPROVAL 16. ROUGH GRADING TO WITHIN +0.10 FOOT, INCLUDING ALL BERMS AND/OR SWALES AND RETENTION AREAS WILL BE PROVIDED BY BUILDER / DEVELOPER OR THE OWNER'S AGENT PRIOR TO PLANT

SITE SHALL BE BROUGHT TO THE ATTENTION OF THE LANDSCAPE

MATERIALS DEEMED UNACCEPTABLE UPON DELIVERY TO SITE. AND LANDSCAPE PERMIT FOR ALL LANDSCAPE WORK WITHIN THE


BUILDING APPROVAL AND PERMITS

25. THERE ARE EXISTING TREES ON SITE.

SAND DROPSEED SPOROBOLUS DRYPTANDRUS

wild seed - sonoran desert grass mix 11bs. /2000 s.f.

COMMON NAME BOTANICAL NAME SYMBOL

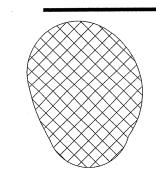

SYMBOL

ARISTIDA PURPUREA **BOUTELOUA ARISTIDOIDES** BOUTELOUA CURTIPENDULA SPOROBOLUS DRYPTANDRUS ERIONEURON PULCHELLUM

PURPLE THREEAWN NEEDLE GRAMA SIDEOATS GRAMA SAND DROPSEED FLUFF GRASS

COMMON NAME

TRIANGLE LEAF BURSAGE

BRITTLEBUSH

QUAIL BRUSH

SNAKEWEED

INDIAN WHEAT

DESERT SENNA

CREOSOTE BUSH

PURPLE THREEAWN

SALT BUSH

JOJOBA

30VE MIX INCLUDES: CONWED FIBER 1200-188 LBS/ACRE SLOW RELEASE FERTILIZER (23-13-0) 300 LBS/ACRE BEST GRADE TACKIFIER 60 LBS./ACRE

> AREA TO BE SEEDED THOROUGHLY TILLED PRIOR TO APPLICATION OF SLURRY MIX.

THIS SEED MIX WILL NOT BE IRRIGATED. APPLICATION OF SEED MIX SHALL NOT COINCIDE WITH PERIODS OF SEASONAL RAIN (JULY-AUGUST OR NOVEMBER -DECEMBER) IN ORDER TO ENCOURAGE GERMINATION. planting notes

(mot approved by city)

THE SUB-CONTRACTOR SHALL MARK AND CONFIRM LOCATIONS OF UNDERGROUND UTILITIES PRIOR TO EXCAVATION. CONFLICTS SHALL BE REPORTED TO THE LANDSCAPE ARCHITECT FOR RESOLUTION. PLANT MATERIALS SPECIFIED SHALL BE SUBJECT TO HAND SELECTION BY

THE LANDSCAPE ARCHITECT AT THE NURSERY 3. FINISH GRADE OR TOP OF D.G. (WHICHEVER IS HIGHER) SHALL BE 1-1/2" BELOW ADJACENT CONCRETE OR OTHER PAVED SURFACES.

4. LANDSCAPE CONTRACTOR IS RESPONSIBLE FOR ALL PLANTS SHOWN ON PLANTING PLAN. THE LANDSCAPE CONTRACTOR SHALL BE RESPONSIBLE FOR ACCURATE PLANT COUNTS. IF ANY DISCREPANCIES SHOULD ARISE WITH REGARDS TO PLANT QUANTITIES THE LANDSCAPE CONTRACTOR SHALL NOTIFY THE LANDSCAPE ARCHITECT WITHIN A PERIOD OF 48 HOUR FOR DISCUSSION. CONTRACTOR TO STAKE ALL TREE, PALM, AND SHRUB LOCATIONS FOR

LANDSCAPE ARCHITECT'S APPROVAL PRIOR TO PLANTING. S. LANDSCAPE ARCHITECT WILL NOT BE RESPONSIBLE FOR LOCATION

APPROVED BY LANDSCAPE ARCHITECT. 7. ALL TREE AND PALM CANOPIES MUST BE A MINIMUM OF 3'-5' FROM

8. ALL PLANT MATERIALS SHALL BE SIZED ACCORDING TO THE ARIZONA

LANDSCAPE ARCHITECT'S DETAILS FOUND WITHIN THE PLAN SET OR

10. ACID ETCH IMPERVIOUS SOILS AS REQUIRED AT PROPOSED TREE

PRE-EMERGENT HERBICIDE AT THE TIME OF ACCEPTANCE BY THE 12. CACTI SHALL RECEIVE NO SUPPLEMENTAL IRRIGATION UNLESS

APPROVED LANDSCAPE OR IRRIGATION PLANS WITHOUT PERMISSION

14. EXISTING TREES AND SHRUBS IN R.O.W. TO REMAIN OR BE RELOCATED BY CONTRACTOR. ANY PLANT MATERIAL DAMAGED OR DESTROYED

SAMPLES SHALL BE SUBMITTED TO THE LANDSCAPE ARCHITECT FOR

INSTALLATION.

17. ANY DISCREPANCIES FOUND BETWEEN PLANS, SPECIFICATIONS, AND ARCHITECT FOR RESOLUTION.

18. THE LANDSCAPE ARCHITECT HAS THE OPTION TO REJECT ANY PLANT 19. ACKNOWLEDGE REQUIREMENT OF COUNTY DUST CONTROL PERMIT PROJECT ON RESIDENTIAL, COMMERCIAL, AND INDUSTRIAL


SUBDIVISIONS. 20. TREES, SHRUBS, VINES, GROUNDCOVER, AND TURF WHICH HAVE TO BE REPLACED UNDER TERMS OF THE GUARANTEE, SHALL BE GUARANTEED FOR AN ADDITIONAL SIXTY (90) DAYS FROM THE DATE OF REPLACEMENT.

21. ALL POOLS, SIGNS AND MONUMENT WALLS REQUIRE A SEPARATE

22. THE CONTRACTOR SHALL PROVIDE ALL REQUIRED SHOP DRAWINGS TO THE LANDSCAPE ARCHITECT FOR REVIEW AND APPROVAL PRIOR TO THE BEGINNING OF CONSTRUCTION. REQUIRED SHOP DRAWINGS MAY INCLUDE BUT ARE NOT LIMITED TO WALLS, COLUMNS, ENTRY GATES, POOL FENCE AND/OR WATER FEATURES. SHOULD A DISPUTE ARISE WITH ANY DESIGN ELEMENT REQUIRING SHOP DRAWINGS, THE LANDSCAPE ARCHITECT SHALL ONLY ASSUME RESPONSIBILITY IF THE SHOP DRAWINGS IN QUESTION HAVE BEEN REVIEWED AND APPROVED BY

THE LANDSCAPE ARCHITECT. 23. ALL TREES WITHIN THE SIGHT TRIANGLE AND DISTANCE AREAS SHALL BE MAINTAINED TO A MINIMUM CANOPY CLEARANCE OF 7'-0". 24. TREES ADJACENT TO PEDESTRIAN WALKWAYS ARE TO HAVE A

MINIMUM CLEARANCE OF 6'-8

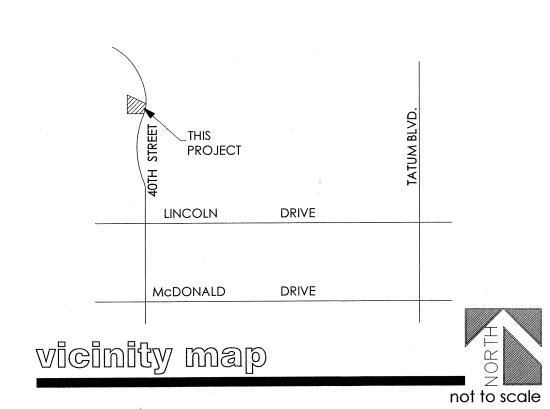

irrigation notes (not approved by city)

IRRIGATION DESIGN SHALL COMPLY WITH THE INTENT OF THE CITY/TOWN OF PHOENIX WATER CONSERVATION, LANDSCAPING AND WATER WASTE ORDINANCE.

CONTRACTOR TO CONTACT THE LOCAL UNDERGROUND UTILITY SERVICES FOR UTILITY LOCATION AND IDENTIFICATION. STAKE ALL UTILITIES, INCLUDING SEWER AND DRAINAGE PRIOR TO ANY EXCAVATION. CONFLICTS SHALL BE REPORTED TO THE

ARCHITECT/LANDSCAPE ARCHITECT FOR RESOLUTION. 4. PERFORM EXCAVATION IN THE VICINITY OF UNDERGROUND UTILITIES WITH CARE AND IF NECESSARY, BY HAND. THE CONTRACTOR BEARS FULL RESPONSIBILITY FOR THIS WORK AND DISRUPTION OR DAMAGE TO UTILITIES SHALL BE REPAIRED IMMEDIATELY AT NO EXPENSE TO THE OWNER.

REFER TO CIVIL ENGINEER'S UTILITY AND PRECISE GRADING PLANS FOR UTILITY LOCATION AND FINAL GRADING. IF ACTUAL SITE CONDITIONS VARY FROM WHAT IS SHOWN ON THE PLANS, CONTACT THE ARCHITECT FOR DIRECTION AS TO HOW TO PROCEED. VERIFY LOCATIONS OF PERTINENT SITE IMPROVEMENTS INSTALLED UNDER OTHER SECTIONS. IF ANY PART OF THIS PLAN CANNOT BE FOLLOWED DUE TO SITE CONDITIONS, CONTACT ARCHITECT FOR INSTRUCTIONS PRIOR TO COMMENCING WORK.

6. THE DESIGN OF THE IRRIGATION SYSTEM SHALL BE THE RESPONSIBILITY OF OF THE CONTRACTOR PER THE PROJECT SPECIFICATIONS. THE CONTRACTOR SHALL SUBMIT IRRIGATION AS-BUILT DESIGN DRAWINGS AND ASSOCIATED DOCUMENTATION TO THE ARCHITECT FOR APPROVAL PRIOR TO INSTALLATION. THE IRRIGATION SYSTEM SHALL BE RUN WITH A FULLY AUTOMATED IRRIGATION CONTROLLER. RUN TIME SHALL BE ADJUSTED ACCORDING TO SEASON, LOCATION AND PLANT PERFORMANCE. DRIP EMITTERS SHALL BE USED FOR ALL PLANT MATERIAL EXCEPT SOD AND POSSIBLY PERENNIAL GROUNDCOVERS. THESE AREAS SHALL BE IRRIGATED WITH SPRAY EMITTERS APPROPRIATELY DESIGNED TO AVOID OVERSPRAY ONTO IMPERMEABLE SURFACES AND ADJACENT PAVING.

IRRIGATION EQUIPMENT NOT OTHERWISE DETAILED OR SPECIFIED SHALL BE INSTALLED PER MANUFACTURER'S RECOMMENDATIONS AND SPECIFICATIONS.

8. IF THERE ARE ANY DISCREPANCIES WITH VALVE SIZES, METER SIZES, MAINLINE SIZES, WATER PRESSURE, COVERAGE, CONTROLLER SIZES, OBSTRUCTIONS, GRADE DIFFERENCES OR LAYOUT - THE CONTRACTOR IS TO NOTIFY THE LANDSCAPE ARCHITECT WITHIN ONE BUSINESS DAY TO DISCUSS AND ADDRESS THE ISSUE(S)

9. DEPTH OF BURY OF THE MAINLINE SHALL BE A MINIMUM OF 18". DEPTH OF BURY ON LATERAL PIPING SHALL BE A MINIMUM OF 12". THE MAIN LINE AND LATERAL LINES SHALL BE SCHEDULE 40 PVC SOLVENT WELD PIPE WITH INTEGRAL SOLVENT WELD BELLS. CURVED TRENCHES AND BENDING OF PIPE TO AVOID FITTINGS WILL NOT BE ACCEPTED.

10. FOR METERS THAT OPERATE MORE GALLONS PER MINUTE (G.P.M.) THAN THE METER'S CAPACITY, CONTRACTOR SHALL PROGRAM THE CONTROLLER TO OPERATE VALVES TO THE MAXIMUM METER CAPACITY. A METER MAY NEED TO HAVE SEVERAL RUN TIMES TO OPERATE ALL VALVES ASSOCIATED

WITH THE METER. 11. POINT OF CONNECTION: A CONNECTION TO POTABLE WATER FOR IRRIGATION PURPOSES WILL BE MADE ON THE PROPERTY, SEE UTILITY PLANS FOR EXAC'T LOCATION OF METER. VALVE BOXES AND EQUIPMENT SHALL BE SHIELDED FROM VIEW. CONTRACTOR TO VERIFY WATER PRESSURE AT WATER METER PRIOR TO START OF WORK. A BOOSTER PUMP MAY BE REQUIRED IF THE PRESSURE IS TOO LOW.

12. BACKFLOW PREVENTOR TO BE VERIFIED IN FIELD BY LANDSCAPE ARCHITECT OR OWNER PRIOR TO INSTALLATION.

13. ELECTRICAL POWER/PEDESTAL(S) LOCATIONS TO BE PROVIDED BY OTHERS. FINAL LOCATION OF CONTROLLER TO BE STAKED AND APPROVED BY LANDSCAPE ARCHITECT OR OWNER PRIOR TO INSTALLATION.

14. ALL 24 VOLT WIRING FROM CONTROLLER TO ELECTRIC VALVES SHALL BE MINIMUM 14 GAUGE SOLID COPPER DIRECT BURIAL 15. PER ARIZONA HOUSE BILL 2256, A BLUE 18 GAUGE TRACER

WIRE SHALL BE INSTALLED WITH 2" AND LARGER MAINLINES. 6" INCHES OF WHICH SHALL BE COILED INSIDE THE CONTROLLER. 16. MAINLINE AND LATERAL PIPING IS SCHEMATIC. LOCATE ALL MAINLINES AND EQUIPMENT OUTSIDE OF THE PUBLIC R.O.W. AND P.U.E. BUT WITHIN THE LANDSCAPE AREAS. CONTRACTOR

17. ALL MAINLINES, LATERAL LINES AND WIRING UNDER PAVEMENT

TO ADJUST AS NECESSARY IN FIELD.

TO BE IN SEPARATE SCHEDULE 80 PVC SLEEVES. PVC SCHEDULE SLEEVES SHALL BE A MINIMUM INSIDE DIAMETER OF 2 TIMES THE IRRIGATION LINE DIAMETER. VALVE WIRING SHALL BE WITHIN SEPARATE ADJACENT SLEEVE.

18. THE CONTRACTOR SHALL PROVIDE IN-LINE AND/OR SPRINKLER CHECK VALVES AS REQUIRED THROUGHOUT THE IRRIGATION SYSTEM LOCATED WITHIN A SLOPED AREAS TO PREVENT LOW IRRIGATION HEAD DRAINAGE. 19. PROVIDE SEPARATE VALVES FOR TREES AND SHRUBS. ALL DRIP

ZONE PVC SHALL BE A MINIMUM 3/4" CLASS 200. 20. ALL PIPING IS TO BE FLUSHED FOR A PERIOD OF 10 MINUTES PRIOR TO THE INSTALLATION OF EMITTERS. CONTRACTOR SHALL BE RESPONSIBLE FOR NECESSARY FLUSHING OF SYSTEM DUE TO CLOGGING FOR THE DURATION OF THE LANDSCAPE MAINTENANCE PER SPECIFICATIONS.

21. MAXIMUM LENGTH OF MICROTUBING ON DRIP ZONE TO BE 5'. WITH 6" MIN. EXPOSED AT THE EMITTER END. 22. CONTRACTOR TO GUARANTEE 100% IRRIGATION COVERAGE FOR ALL LAWN AREAS. CONTRACTOR TO NOTIFY LANDSCAPE ARCHITECT OF ANY LAWN AREAS WITHOUT FULL COVERAGE.

23. IRRIGATION HEADS SHALL BE SET PERPENDICULAR TO FINISH

GRADE UNLESS OTHERWISE SPECIFIED.


Bass leasing


CONCRETE HEADER
EXTRUDED CONCRETE

plant l (see sheet L.	용ggendl 02 for size & qty)				
	botanical name common name	emitters	size	qty	comments
trees					
	OLNEYA TESOTA 'AZT' 'AZT' DESERT IRONWOOD	(5 @ 1.0 GPH)	2" CAL.	3	8.0 H., 6.0 W., 2.0 CAI STAKE IN PLACE
	PARKINSONIA MICROPHYLLUM FOOTHILLS PALO VERDE	(5 @ 1.0 GPH)	1" CAL.	4	5.0 H., 4.0 W., 1.0 CA STAKE IN PLACE
shrubs					
	ENCELIA FARINOSA BRITTLEBUSH	(1 @ 1.0 GPH)	5 GAL.	50	PLANT AT 4' O.C.
\odot	JUSTICIA SPICIGERA MEXICAN HONEYSUCKLE	(1 @ 1.0 GPH)	5 GAL.	24	
③	MYRTUS COMMUNIS COMMON MYRTLE	(1 @ 1.0 GPH)	5 GAL.	14	
	LARREA TRIDENTATA CREOSOTE	(1 @ 1.0 GPH)	5 GAL.	19	PLANT AT 7' O.C.
	PLUMBAGO AURICULATA CAPE PLUMBAGO	(1 @ 1.0 GPH)	5 GAL.	8	
•	RUELLIA BRITTONIANA MEXICAN PETUNIA	(1 @ 1.0 GPH)	5 GAL.	24	
	RUSSELIA EQUISETIFORMIS CORAL FOUNTAIN	(1 @ 1.0 GPH)	5 GAL.	17	
	TECOMA STANS YELLOW BELLS	(1 @ 1.0 GPH)	5 GAL.	10	PLANT AT 7' O.C.
vines accents	FICUS PUMILA CREEPING FIG	(1 @ 1.0 GPH)	5 GAL.	21	PLANT AT 7' O.C.
*	ALOE X. BLUE ELF	(1 @ 0.5 GPH)	5 GAL.	28	2'-0" MINIMUM HEIGH
€	BLUE ELF ALOE ALOE BARBADENSIS	0.5 GPH) (1 @ 0.5 GPH)	5 GAL.	6	3'-0" MINIMUM HEIGH
	ALOE VERA ALOE FEROX	0.5 GFH) (1 @ 0.5 GPH)	5 GAL.	7	3'-0" MINIMUM HEIGH
\oints	CAPE ALOE ALOE MACULATA	0.5 GFH) (1 @ 0.5 GPH)	5 GAL.	6	2'-0" MINIMUM HEIGH
	SOAP ALOE BIZMARKIA NOBILIS	(1 @ 0.5 GPH)	15 GAL.	3	5'-0" MINIMUM HEIGH
• • • • • • • • • • • • • • • • • • •	BIZMARK PALM CARNEGIEA GIGANTEA	0.5 GPH)	4' - 6' TALL SEE PLAN	10	5'-0" MINIMUM HEIGH
	SAGUARO CYCAS REVOLUTA	(1 @	15 GAL.	5	PLANT AT 4' O.C.
	SAGO PALM EUPHORBIA TRICUCALLI	`0.5 GPH)	15 GAL.	3	PLANT AT 4' O.C.
*	STICKS OF FIRE FEROCACTUS CYLINDRACEUS	0.5 GPH)	1.5' TALL	23	1.5' MINIMUM HEIGHT
	COMPASS BARREL FOUQUIERIA SPLENDENS		SEE CANE. MIN.	6	15 CANE MINIMUM
*	OCOTILLO HESPERALOE FUNIFERA GIANT HESPERALOE	(1 @ 0.5 GPH)	5 GAL.	4	PLANT AT 5' O.C.
	OPUNTIA ENGALMANII	0.5 GITI)	5 PAD MIN.	10	PLANT AT 5' O.C.
*	ENGELMAN'S PRICKLY PEAR OPUNTIA VERSICOLOR		5 PAD MIN.	15	PLANT AT 5' O.C.
•	STAGHORN CHOLLA PACHCEREUS MARGINATUS	(1 @ 0.5 CPU)	5 GAL.	3	PLANT AT 5' O.C.
*	MEXICAN FENCE POST YUCCA BACCATA BANANA YUCCA	`0.5 GPH)	5 GAL.	9	PLANT AT 5' O.C.
groundcove ©	AMBROSIA DELTOIDEA BURSAGE	(1 @ 1.0 GPH)	5 GAL.	37	PLANT AT 4' O.C.
②	ERICAMERIA LARICIFOLIA TURPENTINE BUSH	(1 @ 1.0 GPH)	5 GAL.	30	PLANT AT 3' O.C.
(1)	LANTANA 'NEW GOLD' NEW GOLD LANTANA	(1 @ 2.0 GPH)	1 GAL.	21	PLANT AT 3' O.C.
8	SETCREASEA PALLIDA PURPLE HEART PLANT	(1 @ 2.0 GPH)	1 GAL.	48	PLANT AT 6' O.C.
*	SPHAGNETICOLA TRILOBATA YELLOW DOT	(1 @ 2.0 GPH)	1 GAL.	8	PLANT AT 6' O.C.
inerts	TURF - HYBRID BERMUDA	•		917 SF	
	SELECT GRANITE BOULDERS		PER PLAN	6	2' X 2' MINIMUM
	WILD SEED - SONORAN DESERT UPLAND REVEG. MIX			9,334 SF	1lbs. / 2000 sf
2	TOPDRESSING SALVAGED DESERT PAVEMENT		4"-MINUS DESERT PAVEMENT	190,508 S.F.	2" MINIMUM IN ALL PLANTERS


265 L.F.

4" X 6"

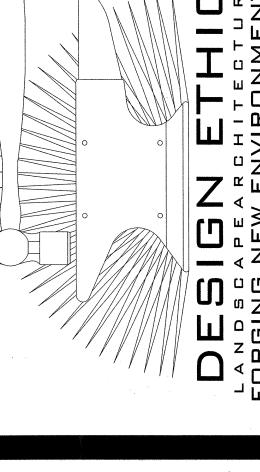

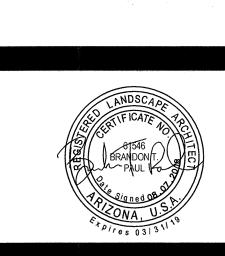



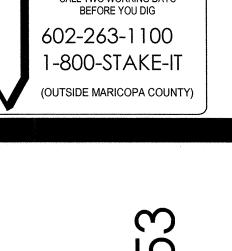


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18-034 JOB NO: DATE: DRAWN BY: B. PAUL 08.07.2018 SUBMITTED: REVISED:





(see sheet L.02 for size & qty) botanical name common name

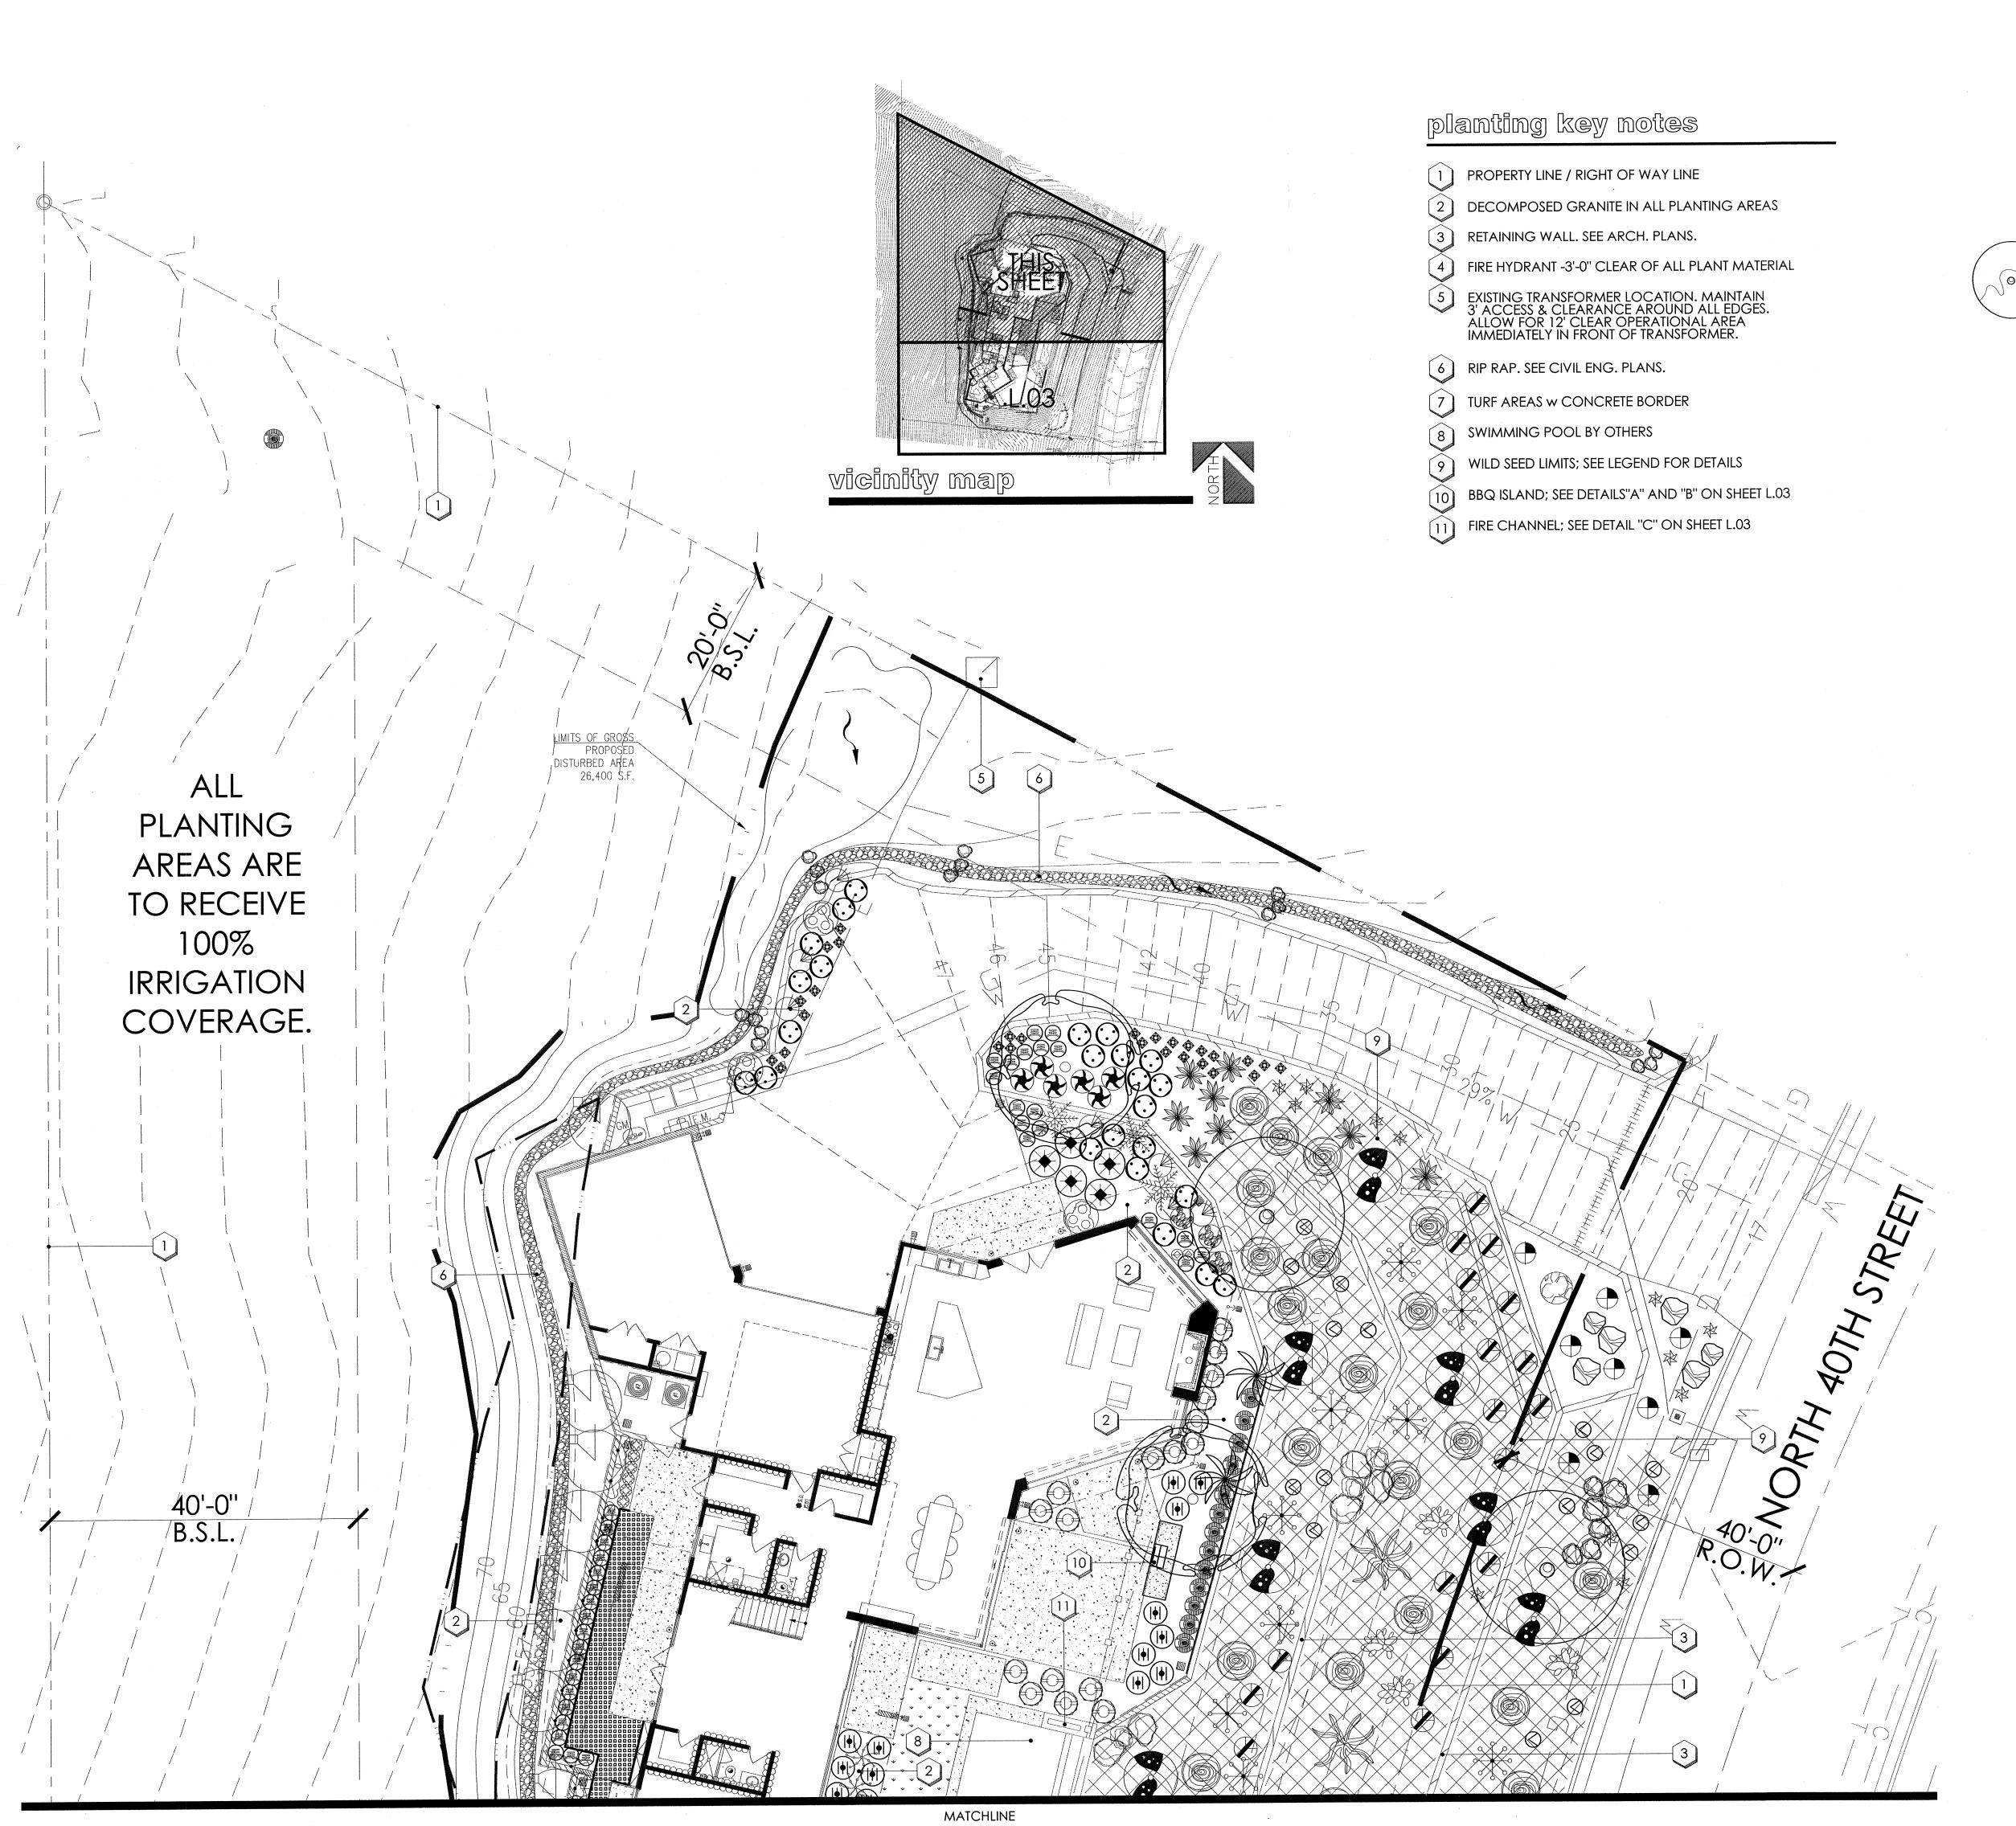OLNEYA TESOTA 'AZT' 'AZT' DESERT IRONWOOD PARKINSONIA MICROPHYLLUM FOOTHILLS PALO VERDE

ENCELIA FARINOSA BRITTLEBUSH

- JUSTICIA SPICIGERA MEXICAN HONEYSUCKLE
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- CREOSOTE
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- RUELLIA BRITTONIANA MEXICAN PETUNIA
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- TECOMA STANS YELLOW BELLS

FICUS PUMILA CREEPING FIG

accents

- ALOE X. BLUE ELF BLUE ELF ALOE
- ALOE BARBADENSIS ALOE VERA
- ALOE FEROX CAPE ALOE
- ALOE MACULATA SOAP ALOE
- BIZMARKIA NOBILIS BIZMARK PALM
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- CYCAS REVOLUTA SAGO PALM
- EUPHORBIA TRICUCALLI STICKS OF FIRE
- FEROCACTUS CYLINDRACEUS COMPASS BARREL
- FOUQUIERIA SPLENDENS OCOTILLO
- HESPERALOE FUNIFERA GIANT HESPERALOE
- OPUNTIA ENGALMANII ENGELMAN'S PRICKLY PEAR
- OPUNTIA VERSICOLOR STAGHORN CHOLLA
- PACHCEREUS MARGINATUS MEXICAN FENCE POST

YUCCA BACCATA BANANA YUCCA groundcover

- AMBROSIA DELTOIDEA BURSAGE
- ERICAMERIA LARICIFOLIA TURPENTINE BUSH
- LANTANA 'NEW GOLD' NEW GOLD LANTANA
- SETCREASEA PALLIDA PURPLE HEART PLANT
- SPHAGNETICOLA TRILOBATA YELLOW DOT

TURF - HYBRID BERMUDA





TOPDRESSING SALVAGED DESERT PAVEMENT

——— CONCRETE HEADER EXTRUDED CONCRETE

JOB NO: 18-034 DATE: B. PAUL 08.07.2018 SUBMITTED: REVISED:

CALL TWO WORKING DAYS BEFORE YOU DIG

602-263-1100

1-800-STAKE-IT

(OUTSIDE MARICOPA COUNTY)

SCALE: 1" = 10'-0"

of L.06




18" 1 1 18"

NOTE: GAS BURN ELEMENT NOT SHOWN

SCALE: 1/2" =1'-0"

planting key notes

- 1 PROPERTY LINE / RIGHT OF WAY LINE
- 2 DECOMPOSED GRANITE IN ALL PLANTING AREAS
- (3) RETAINING WALL. SEE ARCH. PLANS.
- [4] FIRE HYDRANT -3'-0" CLEAR OF ALL PLANT MATERIAL
- EXISTING TRANSFORMER LOCATION. MAINTAIN 3' ACCESS & CLEARANCE AROUND ALL EDGES. ALLOW FOR 12' CLEAR OPERATIONAL AREA IMMEDIATELY IN FRONT OF TRANSFORMER.
- 6 RIP RAP. SEE CIVIL ENG. PLANS.
- 7 TURF AREAS W CONCRETE BORDER
- 8 SWIMMING POOL BY OTHERS
- 9 WILD SEED LIMITS; SEE LEGEND FOR DETAILS
- BBQ ISLAND; SEE DETAILS"A" AND "B" ON SHEET L.03
- 11 FIRE CHANNEL; SEE DETAIL "C" ON SHEET L.03

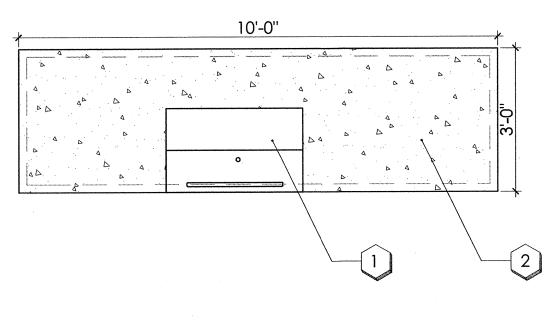

36"W BBQ @ 36"H

1 1" TO 3" COLORED GLASS

2 FILL INNER SPACE WITH PEA GRAVEL TO WITHIN 18" OF TOP

3 20" X 4" CONCRETE CAP.

#4 CONT. IN GROUTED BOND BEAM

5 8" X 8" X 16" CMU BLOCK WITH TRAVERTINE SIDES

6 #4 @ 32" O.C. IN GROUTED CELLS

8 CONTRACTOR TO TIE GAS LINE FROM EXISTING BBQ AT RESIDENCE INTO FIRE PIT.

C FIRE CHANNEL DETAIL

7 #4 CONT. IN 2800 P.S.I. CONC. FOOTING

key notes

key notes


BBQ GAL. # 368433 - TURBO ELITE 5B +RB NGL CUT OUT DIMENSIONS: 38.5" (W) X 19.75" (D) X 9.5" (H PRODUCT DIMENSIONS: 39.75" (W) X 25" (D) X 9" (H)

2 3" THICK POURED IN PLACE CONCRETE CONCRETE

SCALE: 1/2" =1'-0"

1 3" COUNTERTOP

2 8" CMU BLOCK 3 #4 REBAR SUPPORT 4 POURED CONCRETE INTERIOR 5 CONCRETE FOOTING 2500 PSI 6 DECKING → 3'-0" H BBQ COUNTER SCALE: 1/2" =1'-0"

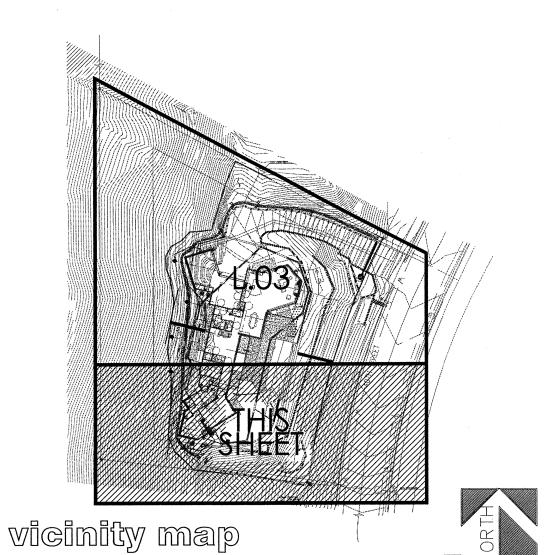

plant legend (see sheet L.02 for size & qty)

botanical name common name OLNEYA TESOTA 'AZT' 'AZT' DESERT IRONWOOD



- ENCELIA FARINOSA BRITTLEBUSH
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- EUPHORBIA TRICUCALLI STICKS OF FIRE
- FEROCACTUS CYLINDRACEUS COMPASS BARREL
- FOUQUIERIA SPLENDENS OCOTILLO
- HESPERALOE FUNIFERA GIANT HESPERALOE
- OPUNTIA ENGALMANII ENGELMAN'S PRICKLY PEAR
- OPUNTIA VERSICOLOR STAGHORN CHOLLA
- PACHCEREUS MARGINATUS MEXICAN FENCE POST

YUCCA BACCATA BANANA YUCCA

- groundcover AMBROSIA DELTOIDEA BURSAGE
 - ERICAMERIA LARICIFOLIA TURPENTINE BUSH
 - LANTANA 'NEW GOLD' NEW GOLD LANTANA
 - SETCREASEA PALLIDA PURPLE HEART PLANT


SPHAGNETICOLA TRILOBATA YELLOW DOT TURF - HYBRID BERMUDA





TOPDRESSING SALVAGED DESERT PAVEMENT

——— CONCRETE HEADER EXTRUDED CONCRETE

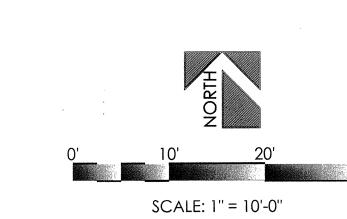

18-034 JOB NO: DATE: DRAWN BY: B. PAUL 08.07.2018 SUBMITTED: REVISED:

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L.06

CALL TWO WORKING DAYS BEFORE YOU DIG


602-263-1100

1-800-STAKE-IT


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(OUTSIDE MARICOPA COUNTY)



MATCHLINE

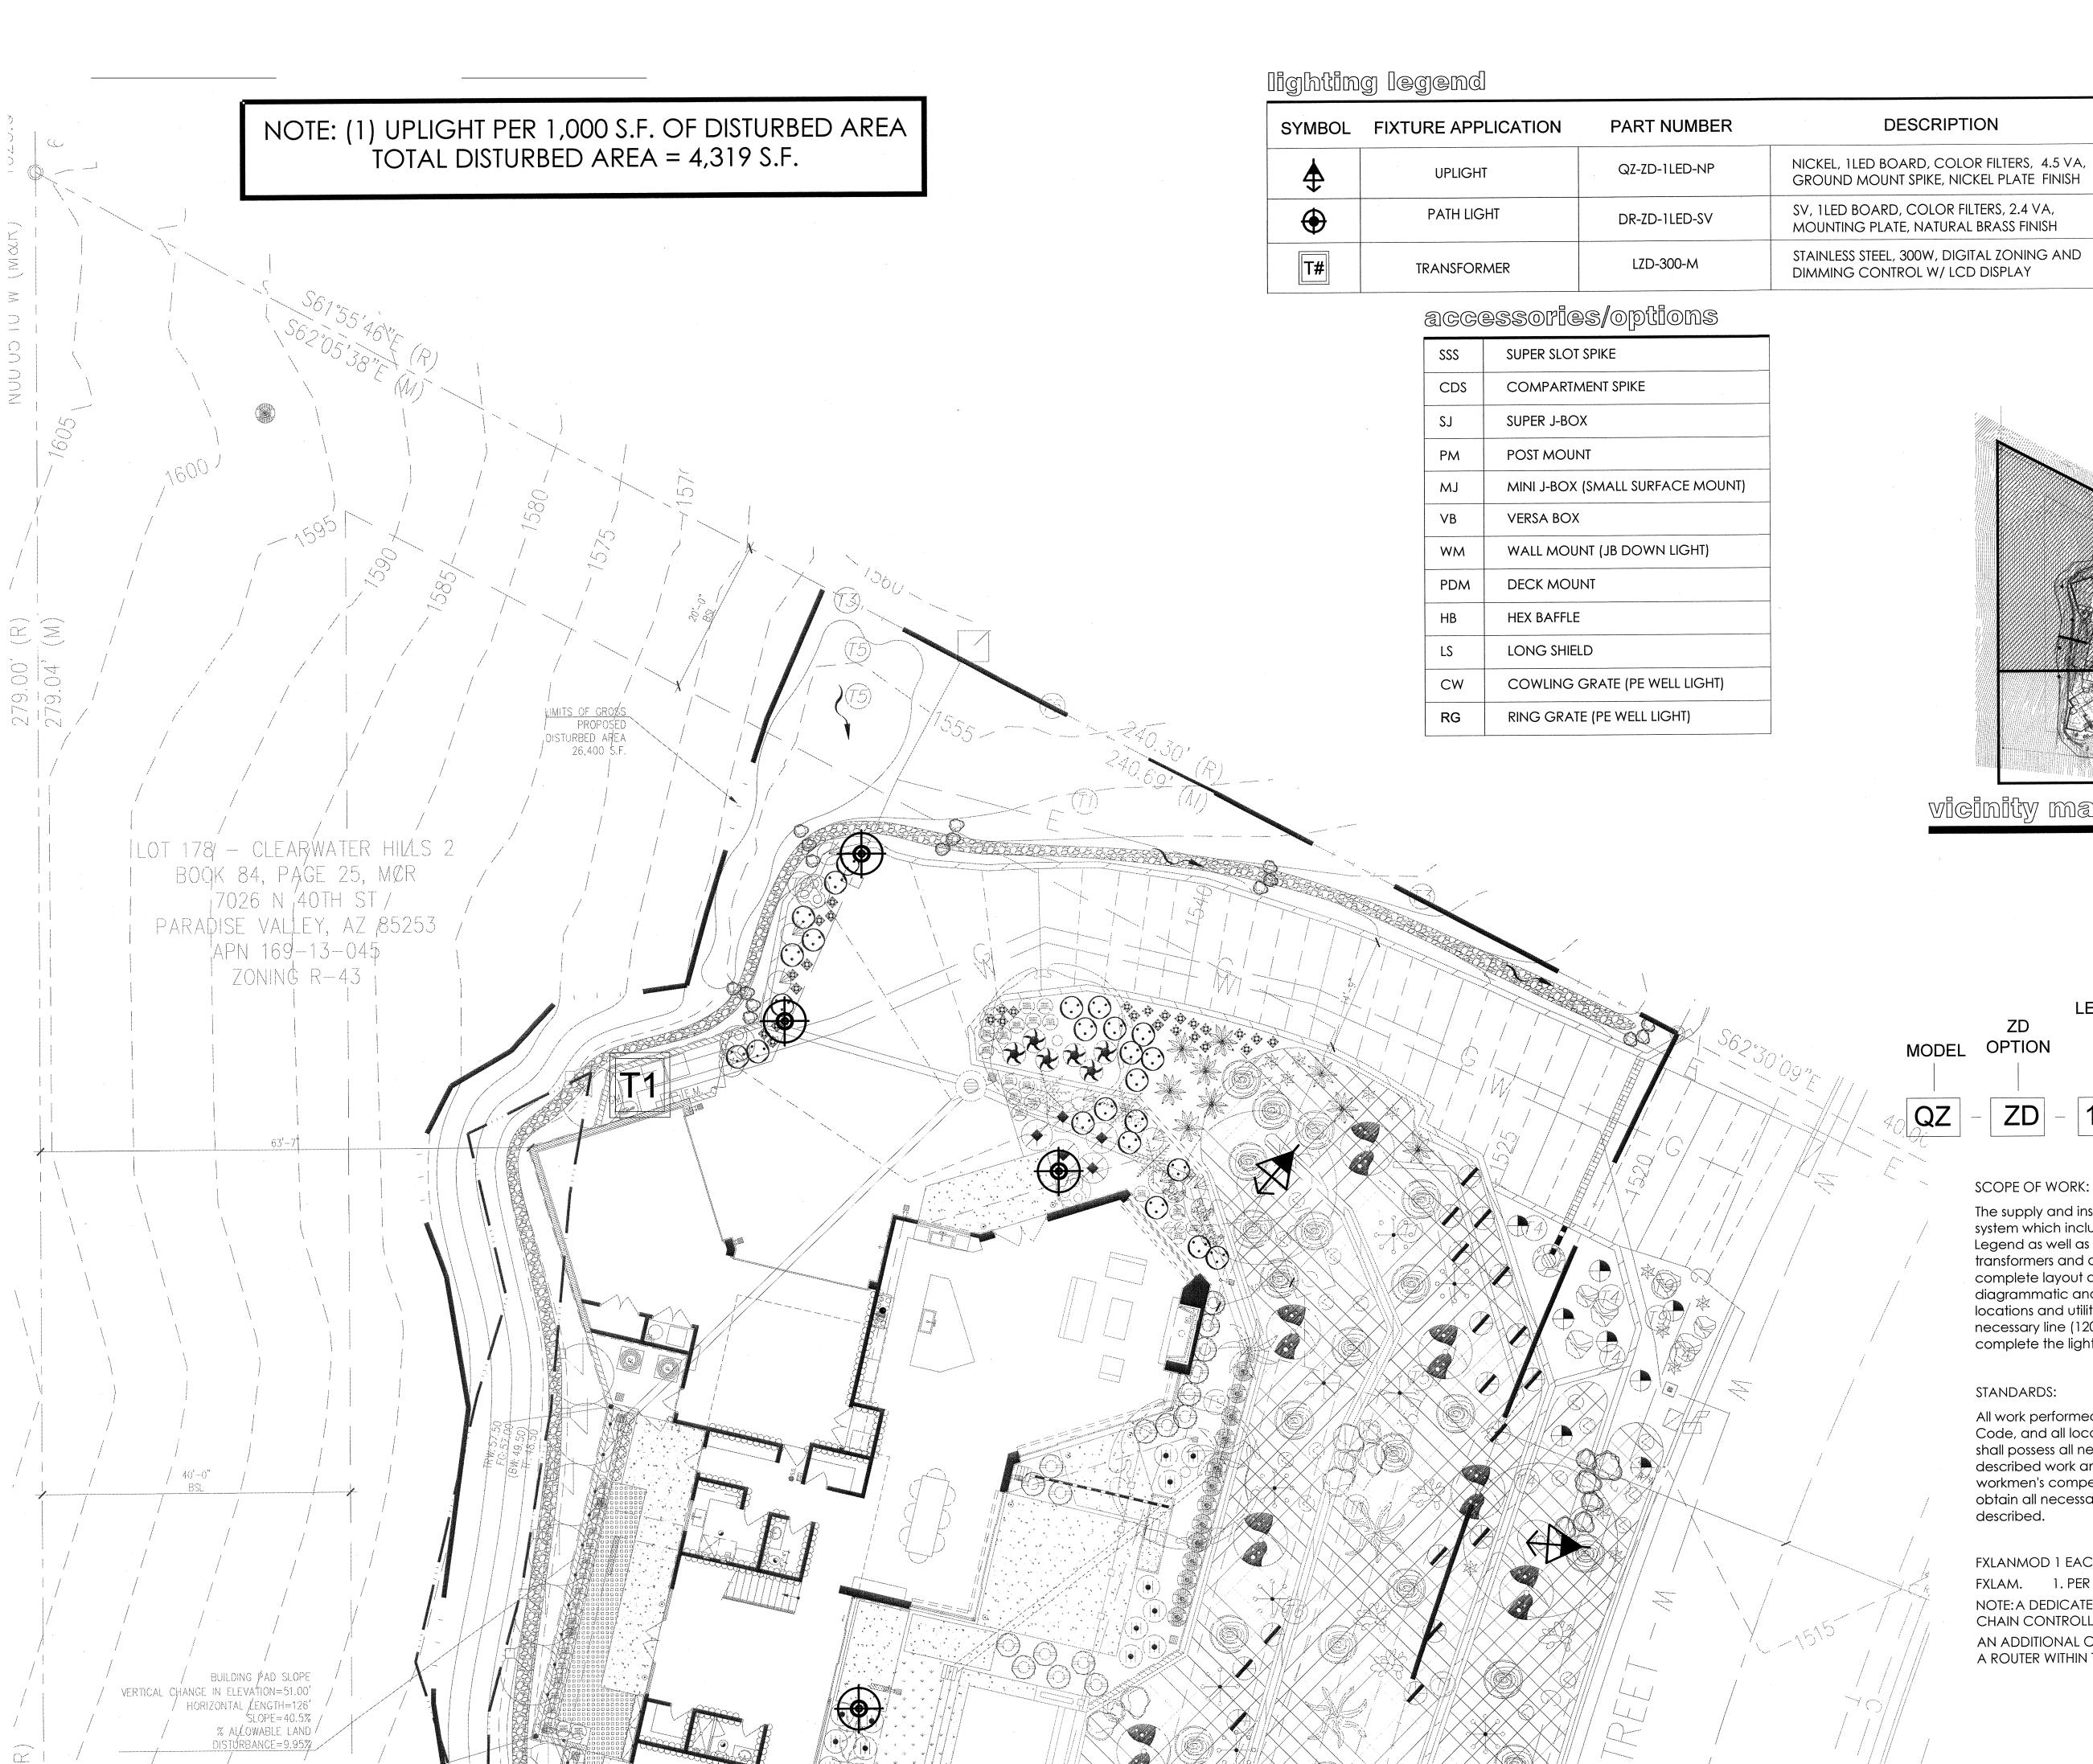



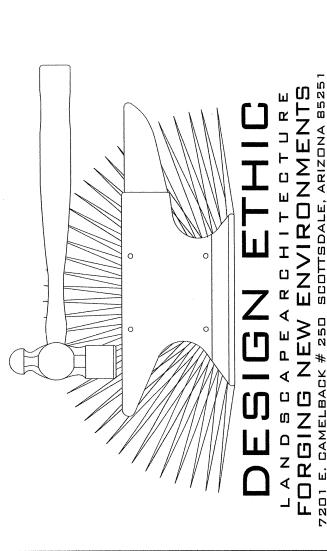

SID

ACCESSORIES/ OPTION **OPTIONS** LS

FINISH

LED TYPE

LIGHT COLOR QTY

3000 K

3000 K

SCOPE OF WORK:

The supply and installation of a 12 volt landscape lighting system which includes the fixtures specified on Lighting Legend as well as the installation of low voltage transformers and direct burial cable necessary to complete layout as shown. This lighting plan is diagrammatic and is intended to show general fixture locations and utilities. Contractor is responsible for necessary line (120v) and low voltage (12v) work to complete the lighting design as shown.

STANDARDS:

All work performed is to comply with the Uniform Building Code, and all local codes and ordinances. Contractor shall possess all necessary licenses to complete described work and shall carry general liability and workmen's compensation insurance. Contractor is to obtain all necessary permits to complete work described.

FXLANMOD 1 EACH CONTROLLER FXLAM. 1. PER PROJECT NOTE: A DEDICATED CAT5 CABLE TO BE RUN. DAISY CHAIN CONTROLLERS TOGETHER. AN ADDITIONAL CATS TO RUN FROM A CONTROLLER TO A ROUTER WITHIN THE HOME.

SCALE: 1" = 10'-0"



JOB NO:


DRAWN BY:

DATE:

18-034

B. PAUL

08.07.2018

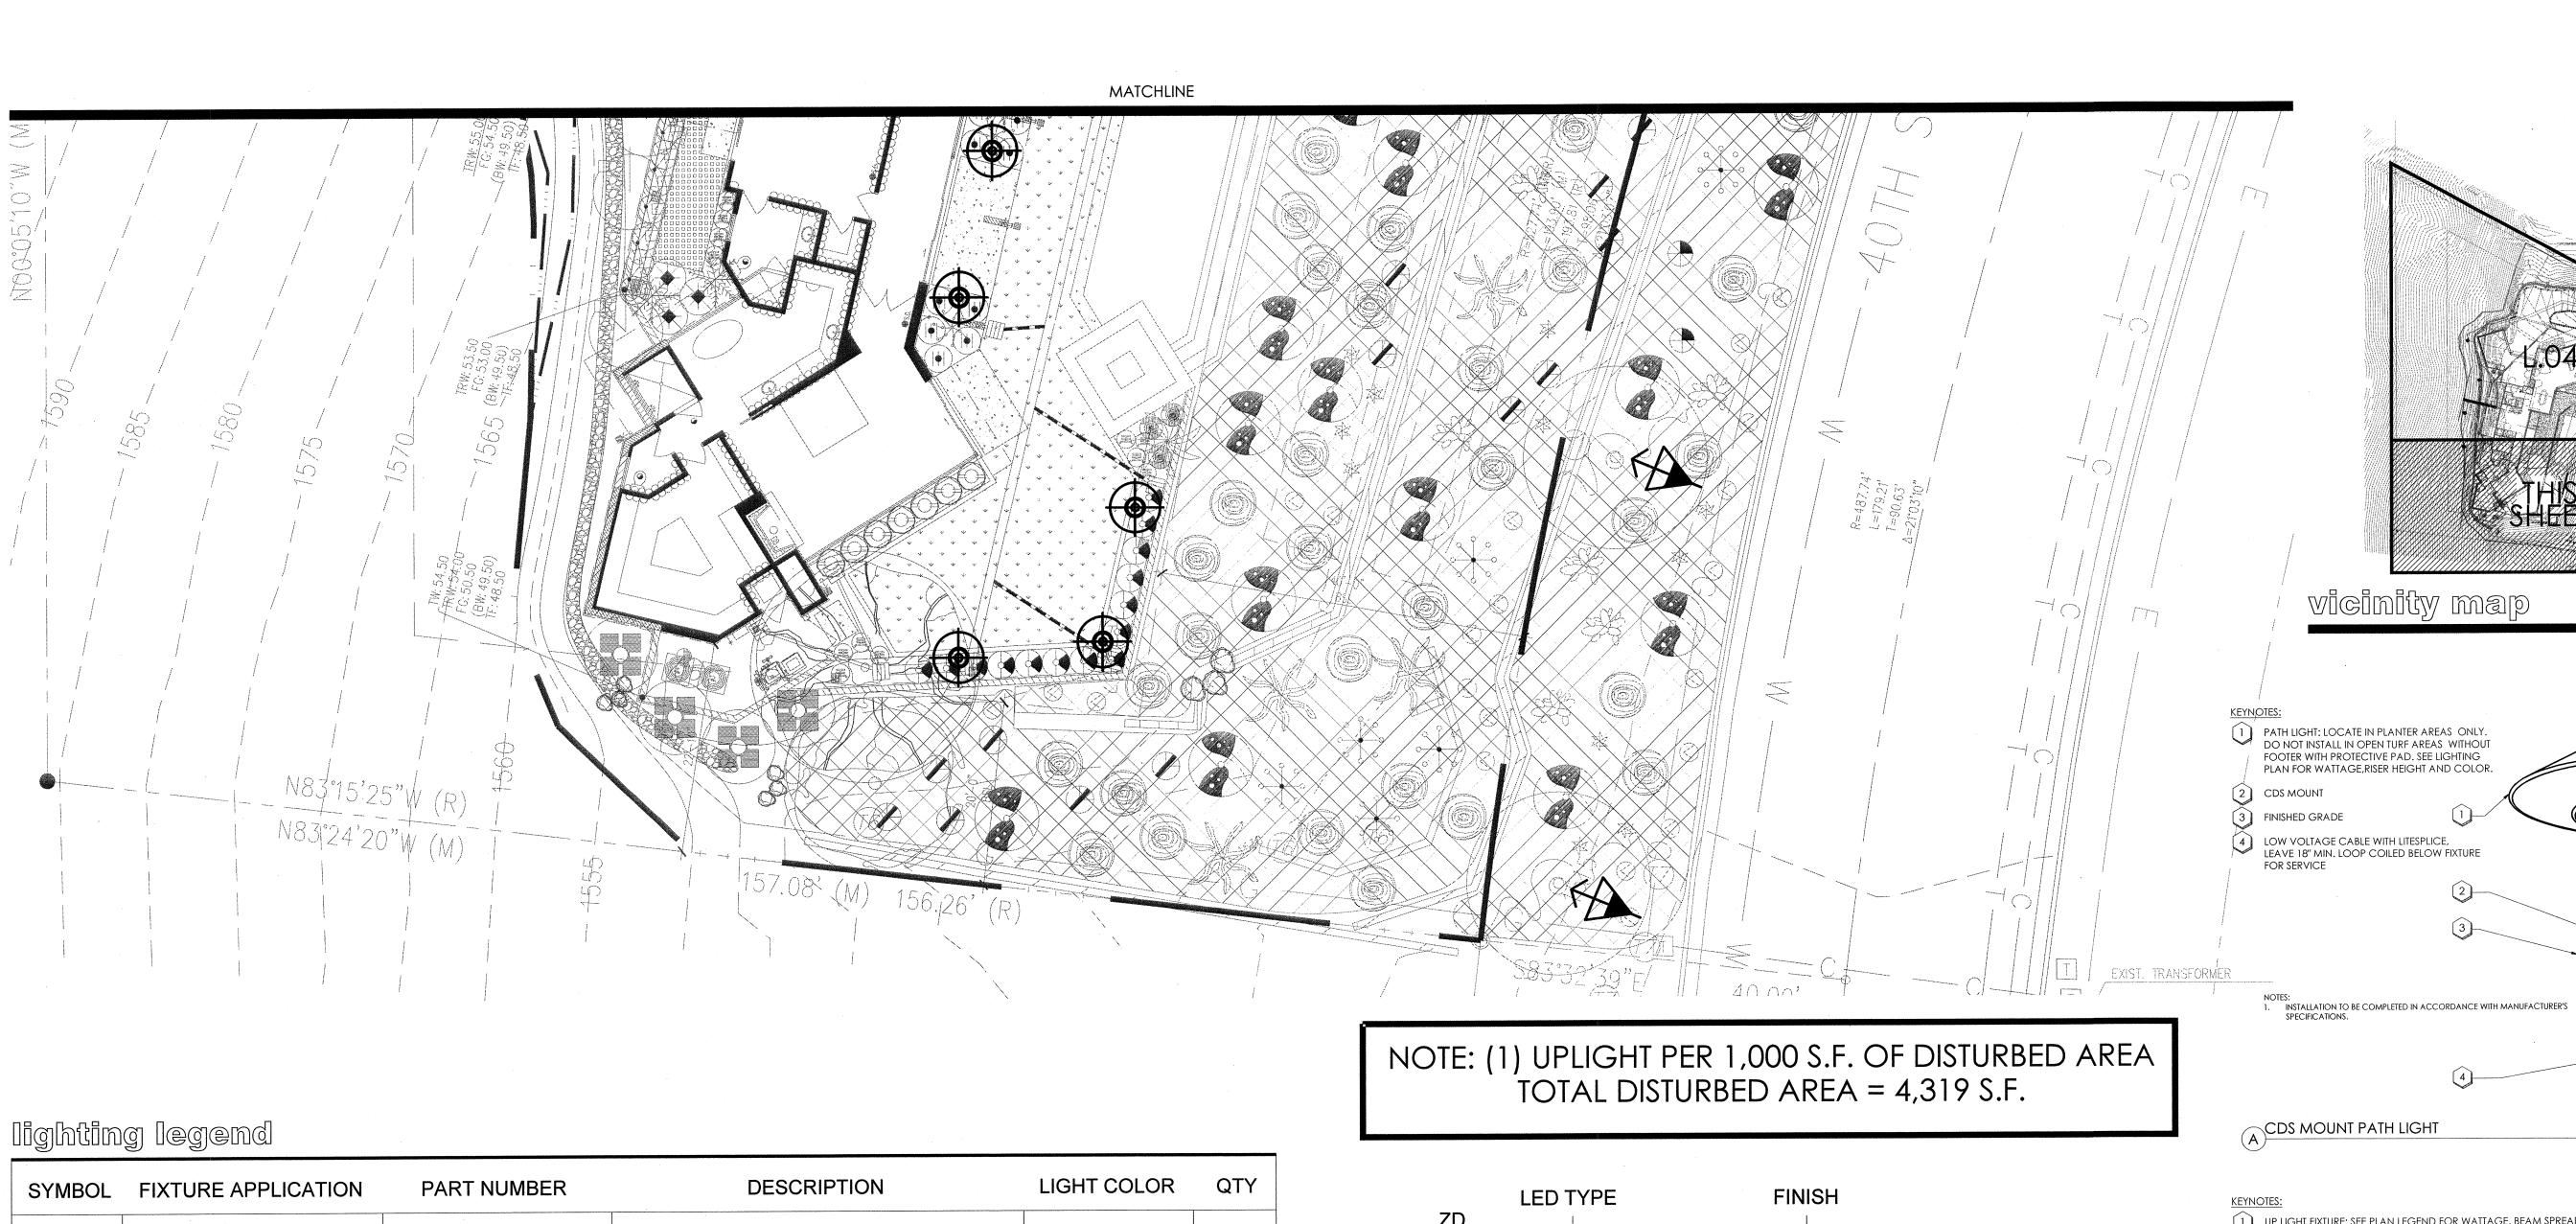

SYMBOL	FIXTURE APPLICATION	PART NUMBER	DESCRIPTION	LIGHT COLOR	QTY
\$	UPLIGHT	QZ-ZD-1LED-NP	NICKEL, 1LED BOARD, COLOR FILTERS, 4.5 VA, GROUND MOUNT SPIKE, NICKEL PLATE FINISH	3000 K	4
(PATH LIGHT	DR-ZD-1LED-SV	SV, 1LED BOARD, COLOR FILTERS, 2.4 VA, MOUNTING PLATE, NATURAL BRASS FINISH	3000 K	8
T#	TRANSFORMER	LZD-300-M	STAINLESS STEEL, 300W, DIGITAL ZONING AND DIMMING CONTROL W/ LCD DISPLAY		1


*(Use this number to size the transformer)

LANDSCAPE LIGHTING

	LED TYPE	FINISH
MODEL OPTION	ACCESS	
$\begin{bmatrix} QZ \end{bmatrix} - \begin{bmatrix} ZD \end{bmatrix} -$	1LED - LS	S - SV


accessories/options

SSS	SUPER SLOT SPIKE	
CDS	COMPARTMENT SPIKE	
SJ	SUPER J-BOX	
PM	POST MOUNT	
MJ	MINI J-BOX (SMALL SURFACE MOUNT)	
VB	VERSA BOX	
WM	WALL MOUNT (JB DOWN LIGHT)	
PDM	DECK MOUNT	
НВ	HEX BAFFLE	
LS	LONG SHIELD	
CW	COWLING GRATE (PE WELL LIGHT)	
RG	RING GRATE (PE WELL LIGHT)	

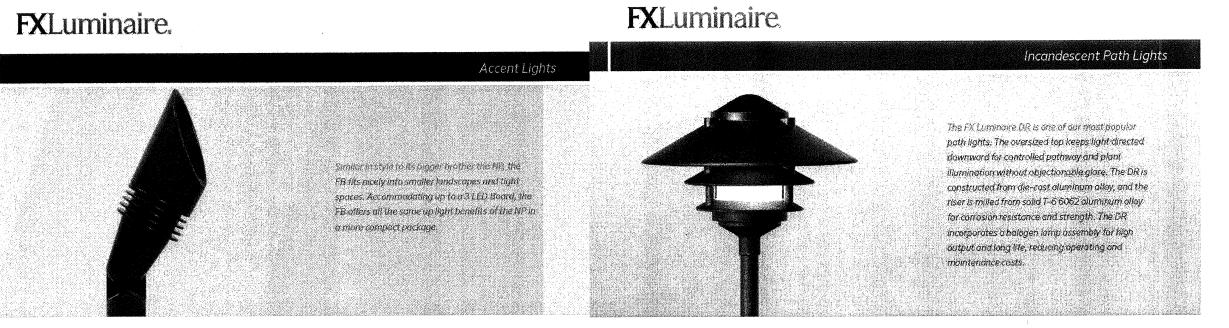

FB: Up Light 10 to 15V 10 to 15V 11 to 15V

A Hunter Industries Companypany

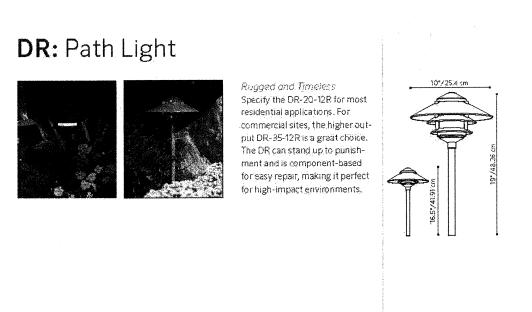

Learn more about FX Luminaire path lights. Visit: fxl.com


SCOPE OF WORK:


The supply and installation of a 12 volt landscape lighting system which includes the fixtures specified on Lighting Legend as well as the installation of low voltage transformers and direct burial cable necessary to complete layout as shown. This lighting plan is diagrammatic and is intended to show general fixture locations and utilities. Contractor is responsible for necessary line (120v) and low voltage (12v) work to complete the lighting design as shown.


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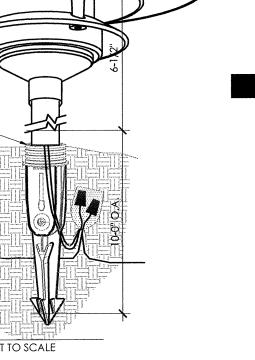







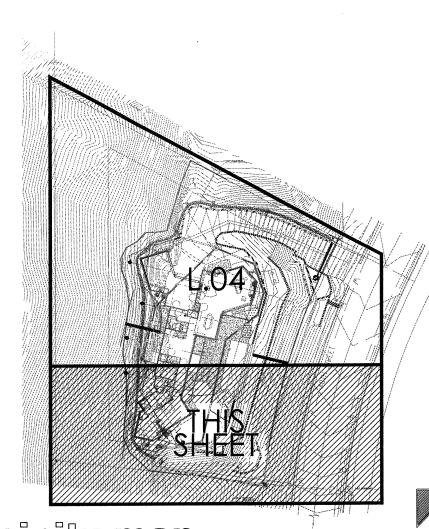

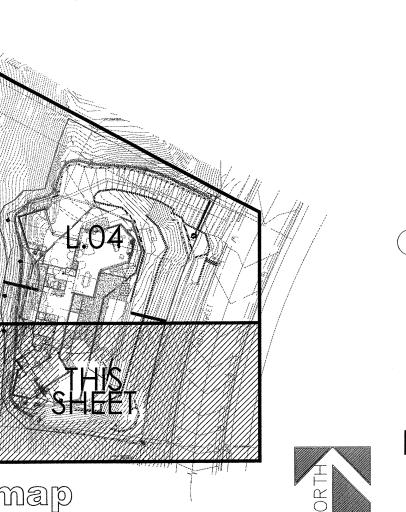

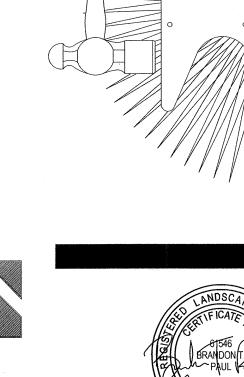


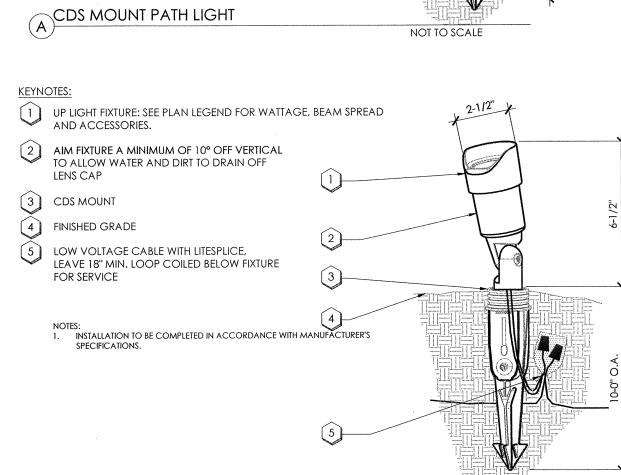


	Francis Tokana To
CDS MOUNT UP LIGHT	
В	NOT TO SCALE

ESID

JOB NO: 18-034 DATE: DRAWN BY: B. PAUL SUBMITTED: 08.07.2018 REVISED:

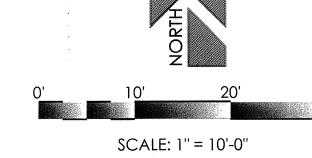

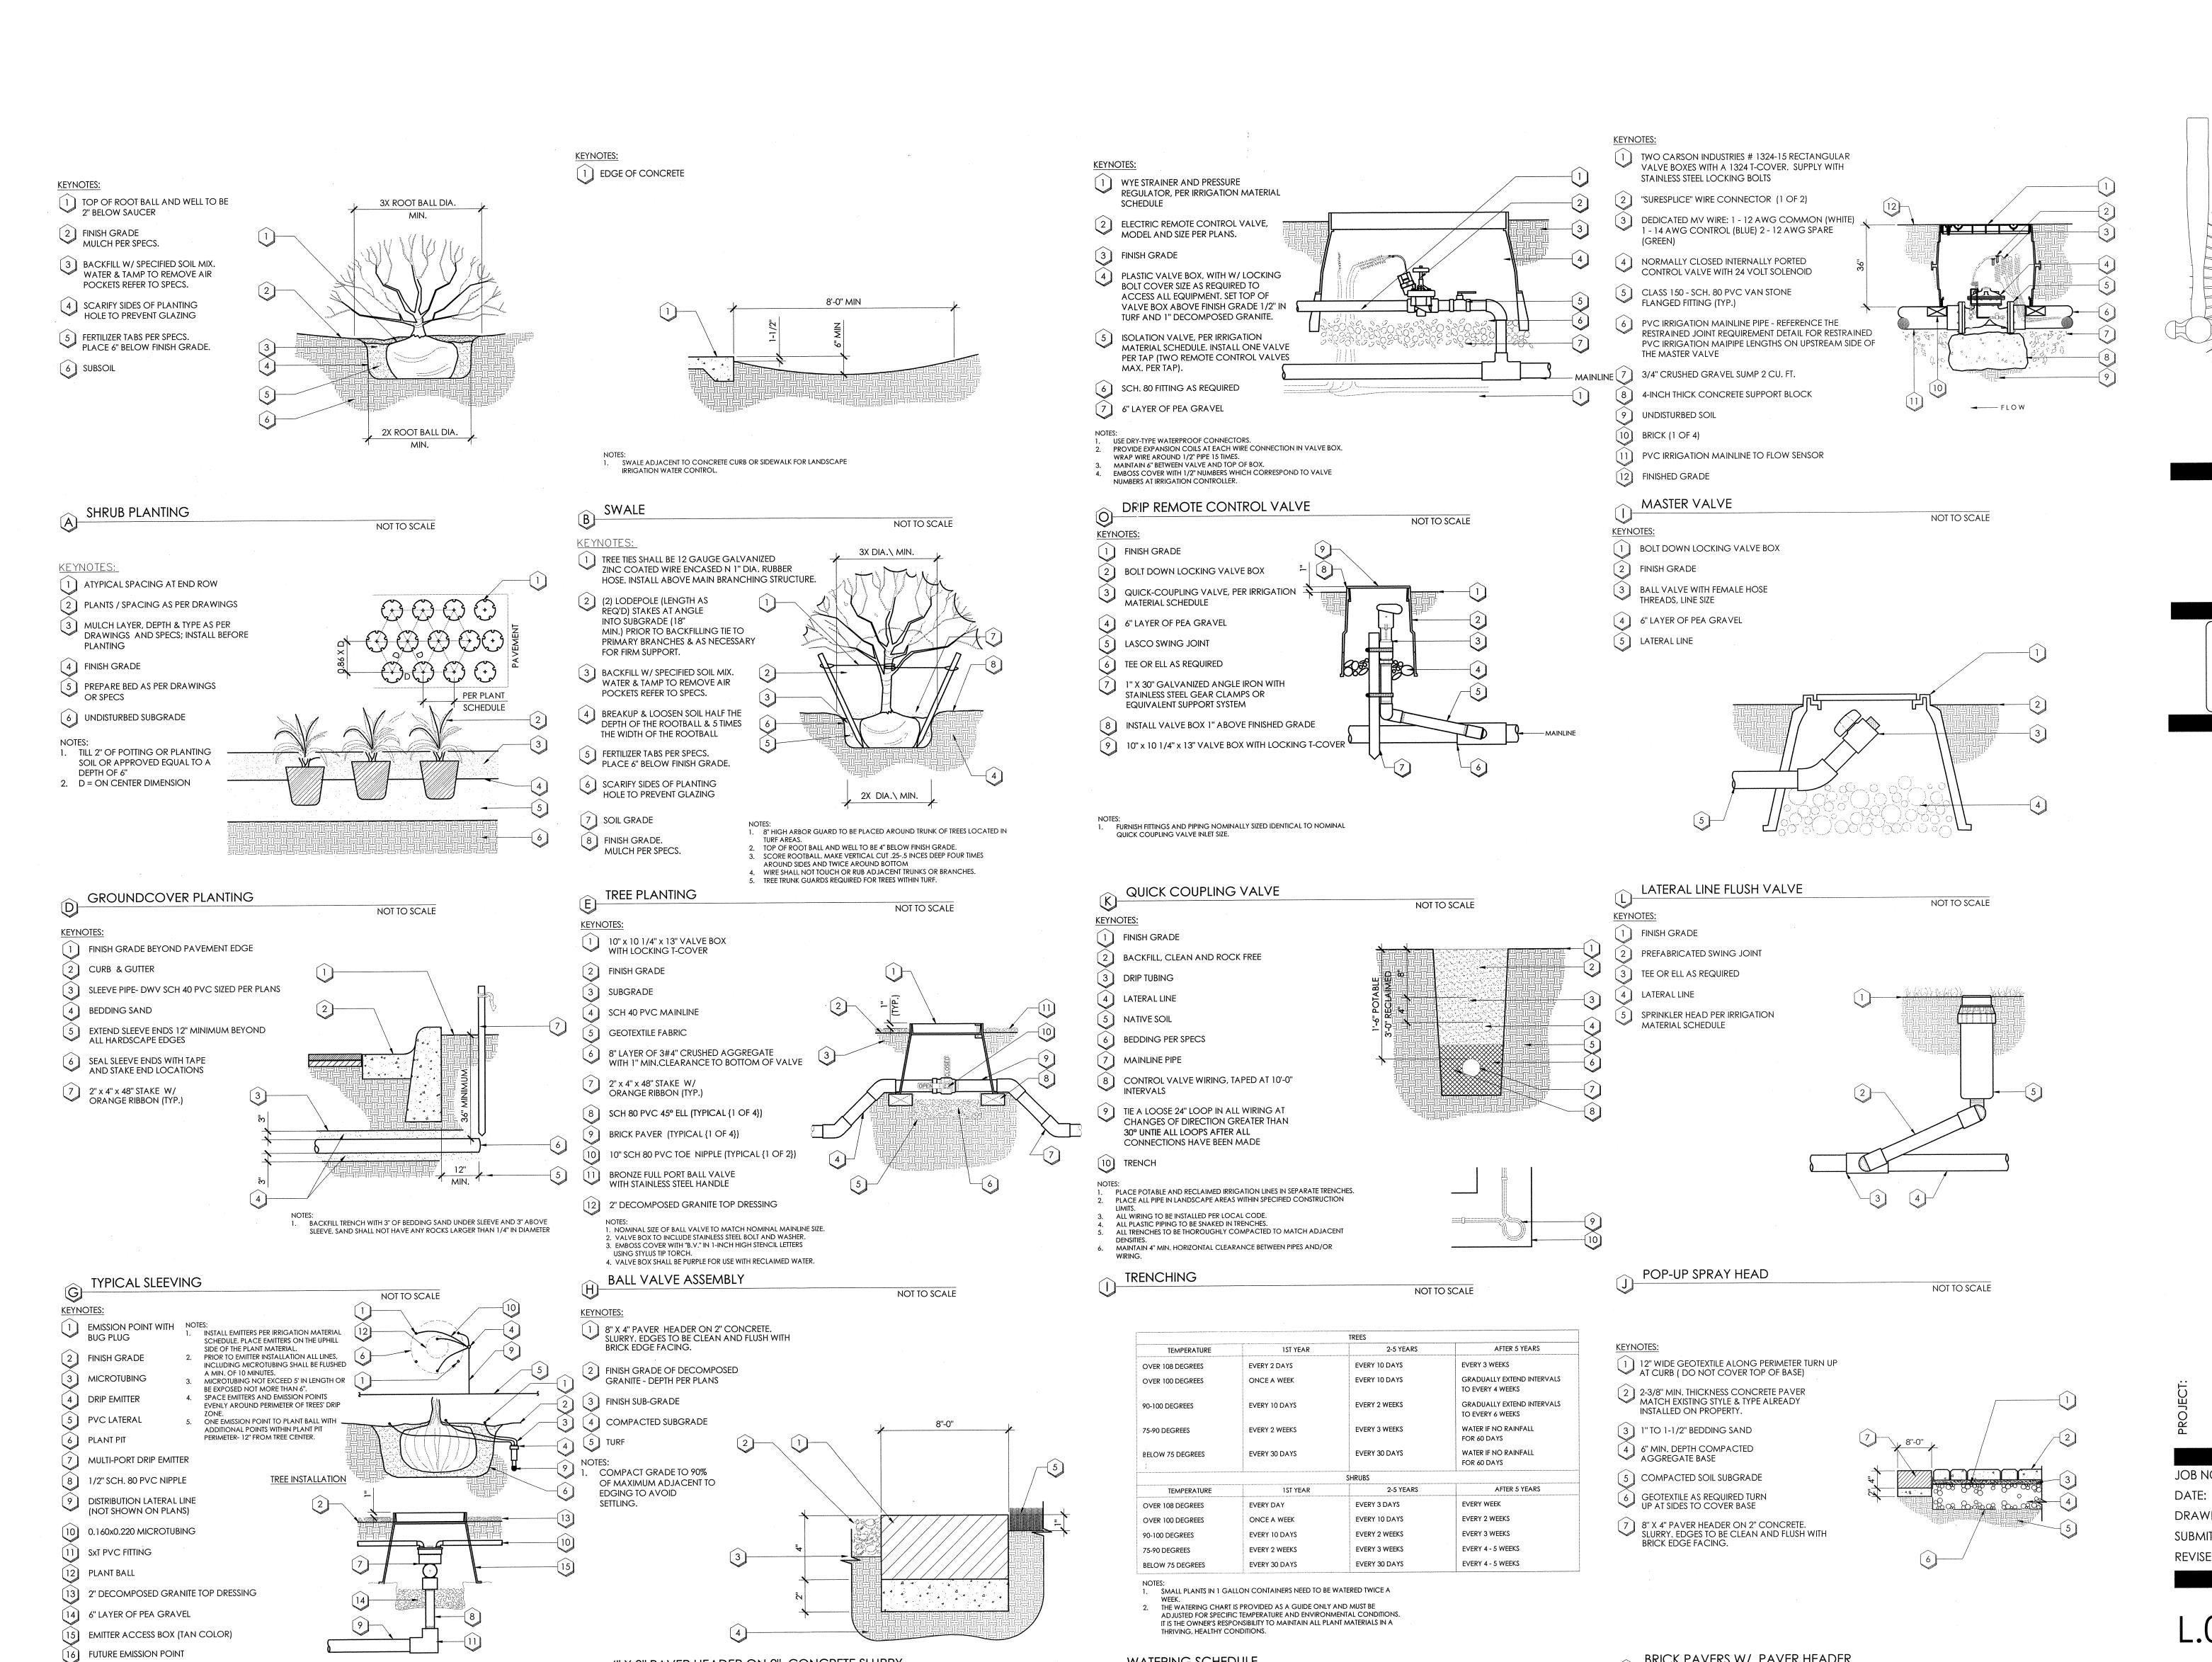

WATERING SCHEDULE

NOT TO SCALE

4" X 8" PAVER HEADER ON 2" CONCRETE SLURRY

NOT TO SCALE

MULTI-PORT EMITTER

NOT TO SCALE







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18-034 JOB NO: DRAWN BY: B. PAUL 08.07.2018 SUBMITTED: REVISED:

BRICK PAVERS W/ PAVER HEADER

NOT TO SCALE


YELLOW BELLS

PURPLE HEART PLANT

ENGELMAN'S PRICKLY PEAR

YELLOW DOT

BANANA YUCCA

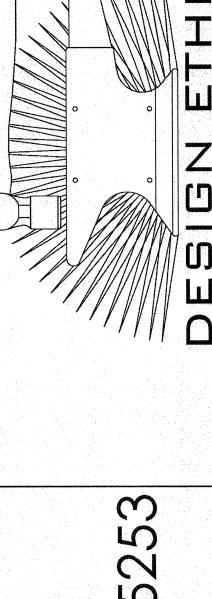

MORAN RESIDENCE 7026 NORTH 40TH STREET PARADISE VALLEY, ARIZONA 85253

JOB NO.:

DATE:


DRAWN BY:

SUBMITTED:

SUBMITTED:

OCOTILLO

SHEET

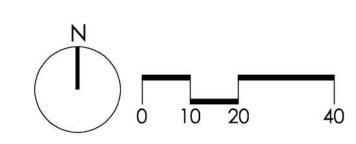

Plant #	Common Name	Caliper (in)/ Height (ft)	Status	Comments
1	Foothills Palo Verde	8	NS	Rocks / On Slope
2	Foothills Palo Verde	4	NS	Rocks / On Slope
3	Foothills Palo Verde	4	NS	Rocks / On Slope
4	Foothills Palo Verde	7	NS	Rocks / On Slope
5	Mesquite	20	NS	Rocks / On Slope
6	Blue Palo Verde	16	NS	On Slope / Leaning
7	Blue Palo Verde	5	NS	On Slope / Leaning
8	Blue Palo Verde	15	NS	Cambium Damage / Leaning
9	Blue Palo Verde	6	NS	Rocks / On Slope
10	Blue Palo Verde	8	NS	Cambium Damage / On Slope
11	Foothills Palo Verde	8	NS	Branch Dieback / On Slope
12	Foothills Palo Verde	6	NS	Rocks / On Slope
13	Foothills Palo Verde	4	NS	Rocks / On Slope
14	Foothills Palo Verde	5	NS	Rocks / On Slope
15	Foothills Palo Verde	4	NS	Rocks / On Slope
16	Foothills Palo Verde	4	NS	Rocks / On Slope
17	Blue Palo Verde	5	NS	Rocks / On Slope
18	Blue Palo Verde	4	NS	Rocks / On Slope
19	Saguaro	6	NS	On Slope / Rocks
20	Foothills Palo Verde	7	NS	Rocks / On Slope
21	Foothills Palo Verde	4	NS	Rocks / On Slope
22	Foothills Palo Verde	6	NS	Rocks / On Slope
23	Foothills Palo Verde	4	NS	Rocks / On Slope
24	Foothills Palo Verde	6	NS	Rocks / On Slope
25	Foothills Palo Verde	6	NS	Rocks / On Slope
26	Foothills Palo Verde	4	NS	Rocks / On Slope
27	Foothills Palo Verde	4	NS	Rocks / On Slope
28	Foothills Palo Verde	6	NS	Exposed Roots / On Slope
29	Mesquite	14	NS	Proximity to Gas Meter
30	Barrel	6	S	2 heads
31	Barrel	6	S	2 heads
32	Night Blooming Cereus	5	NS	Proximity to Wall / Poor Form
33	Mesquite	15	NS	Leaning / On Slope
34	Mesquite	20	NS	Rocks / Leaning
35	Mesquite	12	NS	Cambium Damage / Leaning
36	Mesquite	22	NS	Trunk Form / Leaning
37	Mesquite	24	NS	Trunk Form
38	Ocotillo	12	S	
39	Ocotillo	6	S	
40	Saguaro	10	NS	Access Issue
	Summary	Trees	Cacti	Legend
	Salvageable	0	4	S = Salvageable
	Non-Salvageable	33	3	NS = Non-Salvageable
	Remain-In-Place	0	0	RIP = Remain-In-Place
		33	7	

Plant Legend

Tree - Salvageable Tree - Non-Salvageable

Cacti - Non-Salvageable Cacti - Remain In Place

Project Consultants

Tree - Remain In Place

Inventory Provider

Native Resources International 1540 West Happy Valley Road Phoenix, Arizona 85085 623-869-6757 (p) • 623-869-6769 (f) Contact: Kevin Brenda

Mative Resources

Native Plant Preservation Residence Moran 7026 N. 40th S Paradise Valley

DATE: 5/25/2018

REVISION: SCALE: 1" = 20'

CHECKED: DRAWN: KB

SHEET 1 OF 1