



PROJECT ADDRESS 5429 E SOLANO DR

PARADISE VALLEY, AZ 85253

OWNER SCOTT & TRACY TONN

LEGAL DESCRIPTION

APN SECTION TOWNSHIP RANGE ZONING

PROJECT DESCRIPTION

DEMOLITION OF EXISTING HOUSE AND CONSTRUCTION OF A NEW 3,830 SF HOUSE

1172-47-063

17 2N 4E

R-43

V-B

3,830 SF

1,573 SF

6,267 SF

44,542 SF (1.0225 AC)

14.07%

19,381 SF

4,694 SF

45.38% (20,213 SF)

3,316 SF x 0.25 = 829 SF

13,858 SF < 20,213 SF

864 SF

PROJECT INFORMATION CONSTRUCTION TYPE

PROPOSED SQUARE FOOTAGE LIVABLE GARAGE & STORAGE COVERED EXTERIOR

TOTAL

LOT SIZE:

FLOOR AREA RATIO:

ALLOWABLE NET DISTURBED AREA PROPOSED GROSS DISTURBED AREA LESS 25% CREDIT FOR PAVERS LESS BUILDING FOOTPRINT AREA

PROPOSED NET DISTURBED AREA

CODE STUDY

2015 INTERNATIONAL BUILDING CODE 2015 INTERNATIONAL RESIDENTIAL CODE 2015 INTERNATIONAL FIRE CODE 2014 NATIONAL ELECTRIC CODE 2015 INTERNATIONAL FUEL GAS CODE 2015 INTERNATIONAL MECHANICAL CODE 2015 INTERNATIONAL PLUMBING CODE 2015 INTERNATIONAL ENERGY CONSERVATION CODE EXPOSURE C SEISMIC DESIGN CATEGORY B



PROJECT TEAM ARCHITECT

CIVIL

DARREN PETRUCCI 480 329 1888 dpetrucci@a-i-rinc.com


NICK PRODANOV, P.E. 602 889 1984 nick@idgeng.com



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5429 E SOLANO DR PARADISE VALLEY, AZ



DATE: 07/26/18 SCALE: AS SHOWN DRAWN: DP/JP JOB: XXXX

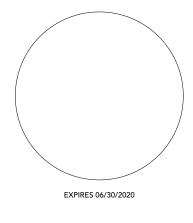COVER SHEET

DRAWING TITLE:

SCHEMATIC DESIGN








ONN RESIDENCE

5429 E SOLANO DR PARADISE VALLEY, AZ 85

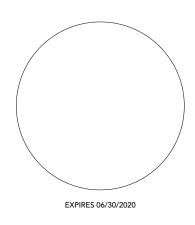

DATE:	07/26/18
SCALE:	AS SHOWN
DRAWN:	DP/JP
JOB:	XXXX

SITE AERIAL

DRAWING TITLE:

SCHEMATIC DESIGN





KEYNOTES

- 01 ROOF METAL STANDING SEAM
- 02 EXISTING DRIVEWAY TO BE REPLACED WITH
- 63 EXISTING POOL TO BE DEMOLISHED64 PROPOSED STAIRS
- 04 PROPOSED STAIRS
 05 PROPOSED PATIO HIGHEST POINT = 1'-8" ABOVE GRADE

SITE DATA

AREA OF LOT	44,542 SF (1.0225 AC)
AREA UNDER ROOF	6,267 SF
LIVABLE SF	3,830 SF
FLOOR AREA RATIO	14.07% < 25%
ALLOWABLE NET DISTURBED AREA	45.38% (20,213 SF)
PROPOSED GROSS DISTURBED AREA	19,381 SF
LESS 25% CREDIT FOR PAVERS	3 316 SE x 0 25 = 829

LESS 25% CREDIT FOR PAVERS3,316 SF x 0.25 = 829 SFLESS BUILDING FOOTPRINT AREA4,694 SFPROPOSED NET DISTURBED AREA13,858 SF < 20,213 SF</td>

PROJECT NARRATIVE


NEW CONSTRUCTION OF A 3,830 SF HOUSE WITH A THREE CAR GARAGE. THE EXISTING HOUSE IS TO BE DEMOLISHED, AND THE EXISTING POOL WILL BE DEMOLISHED AND FILLED IN.



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5429 E SOLANO DR PARADISE VALLEY, AZ 8 PROLETIADRESS



DATE:	07/26/18
SCALE:	AS SHOWN
DRAWN:	DP/JP
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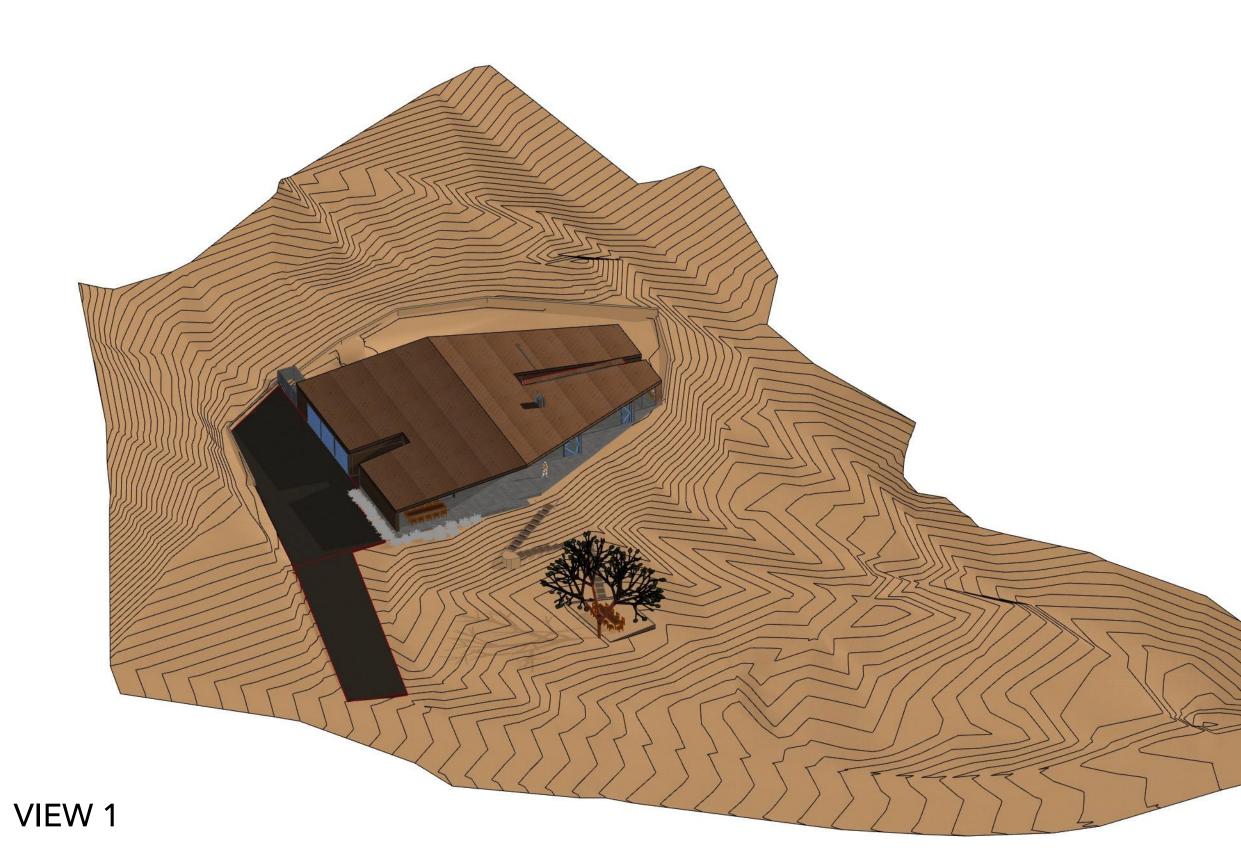
SITE PLAN

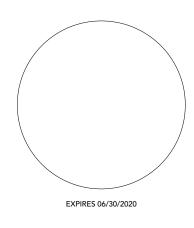
DRAWING TITLE:

SCHEMATIC DESIGN


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SITE PLAN SCALE: 1/16" = 1'-0"






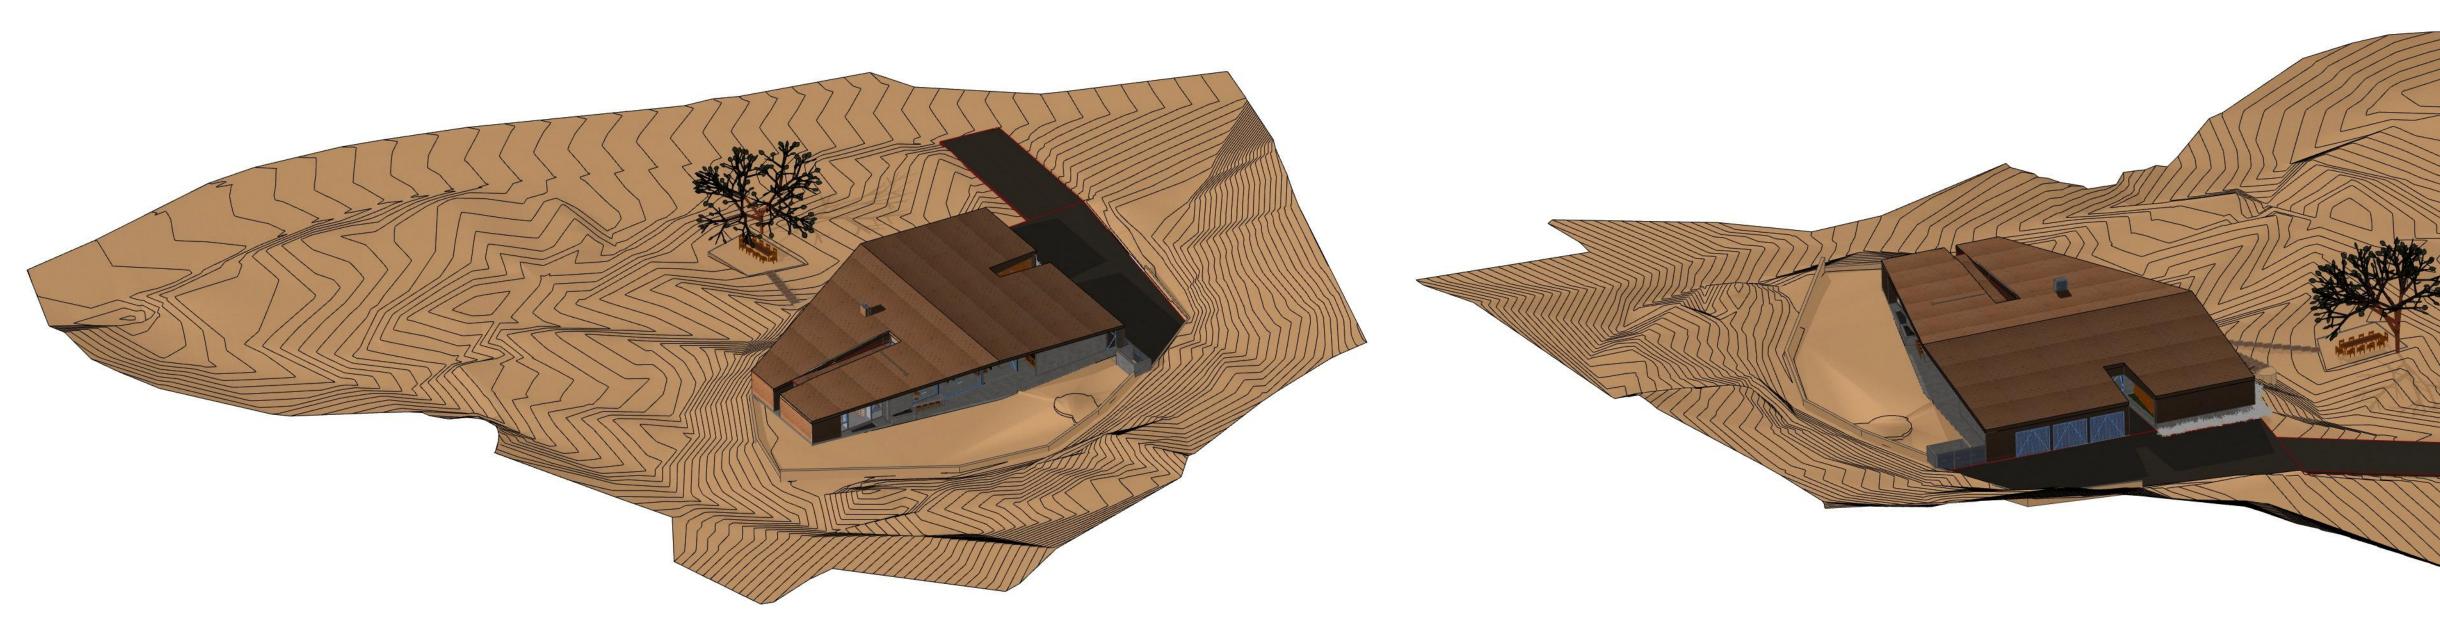

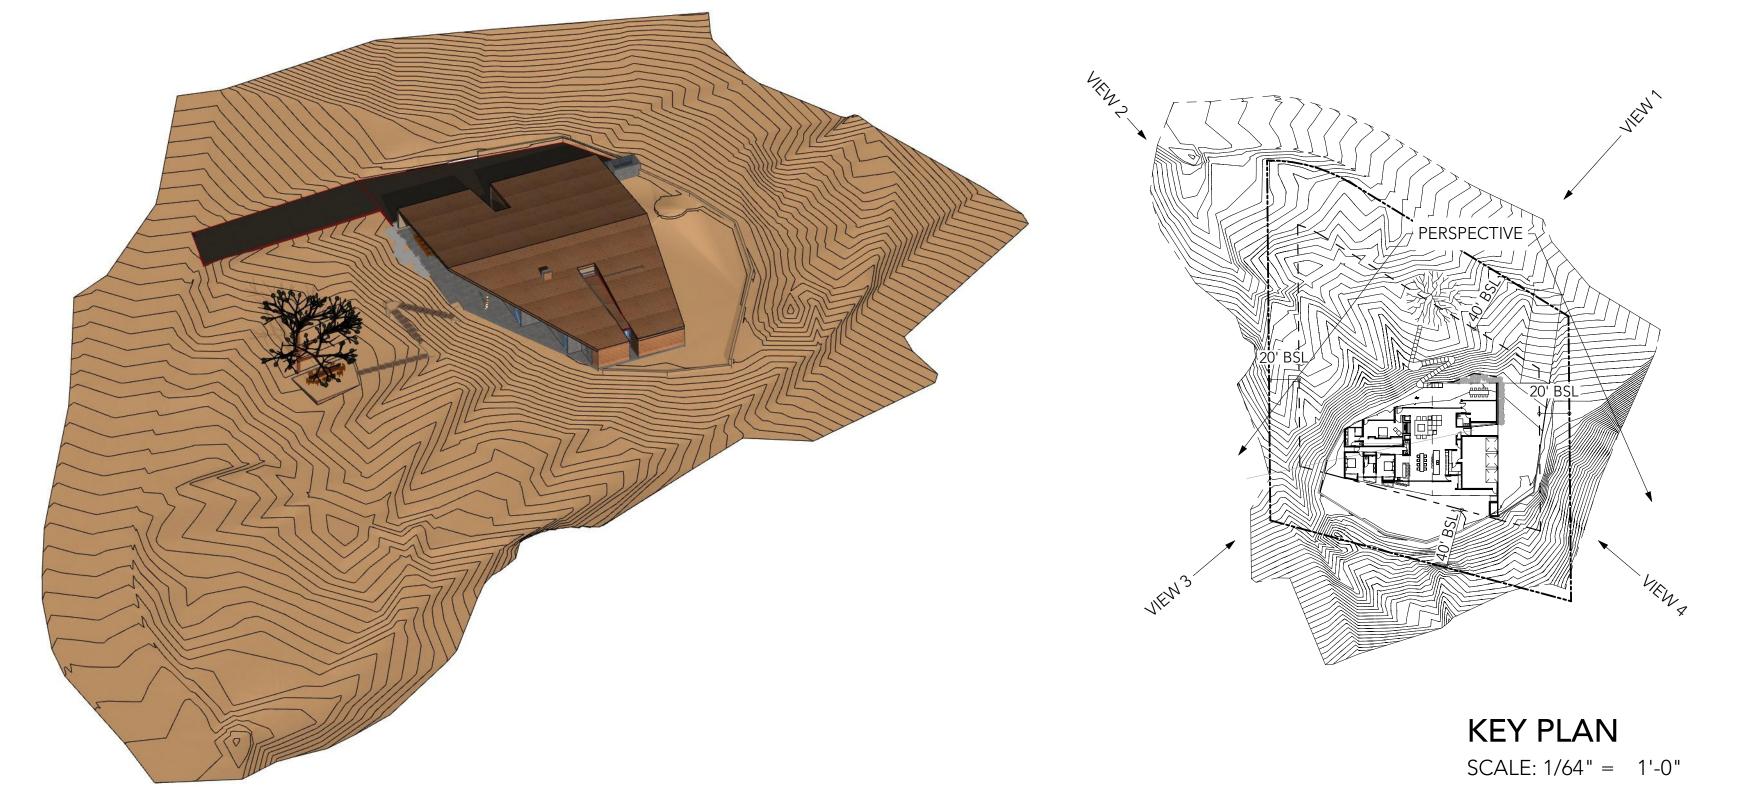


VIEW 2

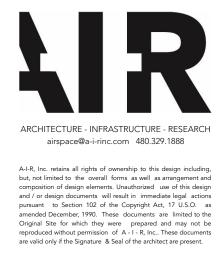

TONN RESIDENCE

5429 E SOLANO DR PARADISE VALLEY, A

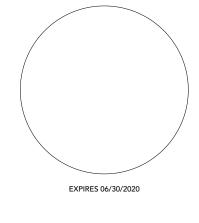

07/26/18 AS SHOWN DRAWN: DP/JP JOB: XXXX

3D VIEWS

SCHEMATIC DESIGN



TOWN OF PARADISE VALLEY GENERAL NOTES

- PRIOR TO THE FIRST INSPECTION OF STRUCTURES WITHIN 3 FEET OF A SETBACK LINE. THE PROPERTY PINS SHALL BE PLACED BY A REGISTERED CIVIL ENGINEER OR LAND SURVEYOR OF THE STATE OF ARIZONA, AND THE PROPERTY LINE(S) IDENTIFIED.
- WHERE EXCAVATION IS TO OCCUR THE TOP 4" OF EXCAVATED NATIVE SOIL SHALL REMAIN ON THE SITE AND SHALL BE REUSED IN A MANNER THAT TAKES ADVANTAGE OF THE NATURAL SOIL SEED BANK IT CONTAINS. ALL WORK REQUIRED TO COMPLETE THE CONSTRUCTION COVERED BY THIS PLAN SHALL BE IN ACCORDANCE WITH THE MARICOPA ASSOCIATION OF GOVERNMENTS (M.A.G.) STANDARD SPECIFICATIONS AND DETAILS AND CURRENT SUPPLEMENTS THEREOF PER THE LOCAL MUNICIPALITY UNLESS SPECIFIED OTHERWISE IN THESE
- PLANS OR ELSEWHERE IN THE CONTRACT DOCUMENTS. THE CONTRACTOR IS TO COMPLY WITH ALL LOCAL STATE, AND FEDERAL LAWS AND REGULATIONS APPLICABLE TO THE CONSTRUCTION COVERED BY THIS PLAN.
- THE CONTRACTOR IS RESPONSIBLE FOR OBTAINING AND COMPLYING WITH ALL PERMITS REQUIRED TO COMPLETE ALL WORK COVERED BY THIS PLAN. ALL EXTERIOR SITE LIGHTING SHALL COMPLY WITH THE APPLICABLE REQUIREMENTS FOR TYPE, LOCATION,
- HEIGHT, WATTAGE, AND LUMEN BASED UPON THE FIXTURES INSTALLED PURSUANT TO SECTION 1023 OF THE TOWN OF PARADISE VALLEY ZONING ORDINANCE FOR NON-HILLSIDE PROPERTIES. SECTION 2208 OF THE TOWN OF PARADISE VALLEY ZONING ORDINANCE FOR HILLSIDE PROPERTIES, OR AS SPECIFIED IN THE SPECIAL USE PERMIT FOR SPECIAL USE PERMIT PROPERTIES.
- A DUST CONTROL PLAN AND PERMIT MEETING THE REQUIREMENTS OF RULE 310 OF THE MARICOPA COUNTY AIR POLLUTION CONTROL REGULATIONS, AS AMENDED, IS REQUIRED. A SEPARATE RIGHT-OF-WAY PERMIT IS NECESSARY FOR ANY OFF-SITE CONSTRUCTION.
- AN APPROVED GRADING AND DRAINAGE PLAN SHALL BE ON THE JOB SITE AT ALL TIMES. DEVIATIONS FROM THE PLAN MUST BE PRECEDED BY AN APPROVED PLAN REVISION.
- 0. EAVE PROJECTIONS INTO REQUIRED SETBACKS ARE LIMITED TO A MAXIMUM OF 24" PURSUANT TO SECTION 1008 OF THE TOWN OF PARADISE VALLEY ZONING ORDINANCES. . ALL STRUCTURES AND LANDSCAPING WITHIN THE SIGHT VISIBILITY TRIANGLE SHALL HAVE A 2 FOOT MAXIMUM
- HEIGHT. 12. ALL NEW AND EXISTING ELECTRICAL SERVICE LINES SHALL BE BURIED PER THE TOWN OF PARADISE VALLEY REQUIREMENTS.
- 13. IT SHALL BE THE RESPONSIBILITY OF THE PERMITTEE TO ARRANGE FOR THE RELOCATION AND RELOCATION COSTS OF ALL UTILITIES, AND TO SUBMIT A UTILITY RELOCATION SCHEDULE PRIOR TO THE ISSUANCE OF AN ENGINEERING CONSTRUCTION PERMIT.
- 4. EXISTING AND/OR NEW UTILITY CABINETS AND PEDESTALS SHALL BE LOCATED A MINIMUM OF 4'BEHIND ULTIMATE BACK OF CURB LOCATION.
- 5. POOL, SPA, BARBECUE AND ANY PROPOSED STRUCTURES OVER 8" ABOVE GRADE REQUIRE SEPARATE PERMIT APPLICATIONS. 6. POOLS SHALL BE CONSTRUCTED BY SEPARATE PERMIT AND SECURED FROM UNWANTED ACCESS PER TOWN
- CODE, ARTICLE 5-2. 7. ALL FILL MATERIAL UNDER SLABS AND WALKS SHALL BE COMPACTED TO NOT LESS THAN 95%. 18. SETBACK CERTIFICATION IS REQUIRED AND SHALL BE PROVIDED TO TOWN INSPECTOR PRIOR TO STEM WALL
- INSPECTION. 19. FOR BUILDING PADS THAT HAVE 1'OR MORE OF FILL MATERIAL, SOILS COMPACTION TEST RESULTS ARE
- REQUIRED AND SHALL BE PROVIDED TO TOWN INSPECTOR PRIOR TO PRE-SLAB INSPECTION. 20. FINISHED FLOOR ELEVATION CERTIFICATION IS REQUIRED AND SHALL BE PROVIDED TO TOWN INSPECTOR PRIOR TO FRAMING INSPECTION.
- 1. MAIL BOXES SHALL COMPLY WITH THE TOWN OF PARADISE VALLEY STANDARDS FOR MAIL BOXES IN THE RIGHTOF-WAY FOR HEIGHT, WIDTH AND BREAK AWAY FEATURES. 22. ALL PATIOS, WALKS, AND DRIVES TO SLOPE AWAY FROM BUILDING AND GARAGES AT A MINIMUM SLOPE OF
- 1/4" PER FOOT UNLESS SPECIFIED OTHERWISE. TRENCH BEDDING AND SHADING SHALL BE FREE OF ROCKS AND DEBRIS.
- 24. THE TOWN ONLY APPROVES THE SCOPE OF WORK AND NOT THE ENGINEERING DESIGN. ANY CONSTRUCTION QUANTITIES SHOWN ARE NOT VERIFIED BY THE TOWN. 25. THE APPROVAL OF THE PLANS IS VALID FOR 180 DAYS. IF A PERMIT FOR CONSTRUCTION HAS NOT BEEN
- ISSUED WITHIN 180 DAYS, THE PERMIT MUST BE RENEWED. 26. A TOWN INSPECTOR WILL INSPECT ALL WORK WITHIN THE TOWN'S RIGHTS-OF-WAY. NOTIFY TOWN INSPECTION SERVICES TO SCHEDULE A PRECONSTRUCTION MEETING PRIOR TO STARTING CONSTRUCTION.
- WHENEVER EXCAVATION IS NECESSARY, CALL ARIZONA811 BY DIALING 811 or 602-263-1100, TWO (2) WORKING DAYS BEFORE EXCAVATION BEGINS.
- 28. EXCAVATIONS SHALL COMPLY WITH REQUIREMENTS OF OSHA EXCAVATION STANDARDS (29 CFR, PART 1926, SUBPART P). UNDER NO CIRCUMSTANCES WILL THE CONTRACTORS BE ALLOWED TO WORK IN A TRENCH LOCATED WITHIN THE TOWN'S RIGHT-OF-WAY WITHOUT PROPER SHORING OR EXCAVATION METHODS.
- 29. PERMIT HOLDER SHALL POST A 6 SQUARE FOOT (2'X3') IDENTIFICATION SIGN, MADE OF DURABLE MATERIAL, IN THE FRONT YARD OF SUBJECT PROPERTY AND NOT IN THE TOWN'S RIGHT-OF-WAY. THE SIGN MAY NOT EXCEED A MAXIMUM OF 6 FEET IN HEIGHT FROM GRADE TO TOP OF THE SIGN. THE SIGN MUST INCLUDE THE PERMITTEE OR COMPANY NAME, PHONE NUMBER. TYPE OF WORK, ADDRESS OF PROJECT AND TOWN CONTACT NUMBER, 480-348-3556
- WHEN DEEMED NECESSARY, A 6-FOOT HIGH CHAIN LINK FENCE MUST BE INSTALLED AROUND THE CONSTRUCTION AREA TO PREVENT ANY POTENTIAL SAFETY HAZARD FOR THE PUBLIC. THE FENCE SHALL BE SETBACK AT LEAST 10 FEET FROM ALL RIGHTS-OF-WAY AND HAVE A 50-FOOT STREET CORNER SITE TRIANGLE WHERE APPLICABLE.
- CLEAR ACCESS FOR NEIGHBORING PROPERTIES AND EMERGENCY VEHICLES MUST BE MAINTAINED AT ALL TIMES. CONSTRUCTION RELATED VEHICLES MUST BE LEGALLY PARKED ONLY ON ONE SIDE OF THE STREET OR JOB SITE PROPERTY
- ALL CONSTRUCTION DEBRIS AND EQUIPMENT MUST BE CONTAINED ON SITE AT ALL TIMES. CONTRACTOR AND PROPERTY OWNER MUST MAINTAIN THE JOB SITE FREE OF LITTER AND UNSIGHTLY MATERIALS AT ALL TIMES. CONSTRUCTION MATERIALS ARE PROHIBITED IN THE TOWN'S RIGHT-OF-WAY. CONSTRUCTION ACTIVITIES ARE PERMITTED BETWEEN THE HOURS OF 7 AM AND 5 PM MONDAY THROUGH
- FRIDAY. CONSTRUCTION ACTIVITIES MAY START ONE (1) HOUR EARLIER DURING THE SUMMER (MAY 1ST THROUGH SEPTEMBER 30TH).
- 34. THE USE AND OPERATION OF FUEL-FIRED GENERATORS IS PROHIBITED UNLESS DUE TO A HARDSHIP. TOWN APPROVAL SHALL BE REQUIRED. 35. THE CONTRACTOR AND PROPERTY OWNER SHALL BE LIABLE FOR ANY DAMAGE DONE TO ANY PUBLIC
- PROPERTY AS A RESULT OF ANY CONSTRUCTION OR CONSTRUCTION RELATED ACTIVITIES. NO CERTIFICATE OF OCCUPANCY WILL BE ISSUED UNTIL ALL AFFECTED RIGHTS-OF-WAY ARE CLEANED AND/OR REPAIRED TO THEIR ORIGINAL CONDITION AND UNTIL ANY AND ALL DAMAGES TO AFFECTED PROPERTIES ARE RESTORED TO ORIGINAL CONDITION.
- 36. A KEYED SWITCH SHALL BE REQUIRED ON ALL NEW AND EXISTING ELECTRIC ENTRY GATES. THE KEYED SWITCH SHALL BE INSTALLED IN A LOCATION THAT IS READILY VISIBLE AND ACCESSIBLE. KNOX BOX ORDER FORMS ARE AVAILABLE AT THE TOWN'S BUILDING SAFETY DEPARTMENT.
- PROPERTY OWNER, BUILDER, OR GENERAL CONTRACTOR WILL BE RESPONSIBLE FOR CONTROLLING DUST FROM THE SITE AT ALL TIMES. ALL MEANS NECESSARY SHALL BE USED BY THE BUILDER OR GENERAL CONTRACTOR TO CONTROL THE EXISTENCE OF DUST CAUSED BY ANY EARTHWORK, SPRAY APPLICATION OF MATERIALS, OR OTHER DUST-CAUSING PRACTICES REQUIRED BY THE CONSTRUCTION PROCESS APPROVAL OF THESE PLANS ARE FOR PERMIT PURPOSES ONLY AND SHALL NOT PREVENT THE TOWN FROM
- REQUIRING CORRECTION OF ERRORS IN THE PLANS WHERE SUCH ERRORS ARE SUBSEQUENTLY FOUND TO BE IN VIOLATION OF ANY LAW, ORDINANCE, HEALTH, SAFETY, OR OTHER DESIGN ISSUES. ALL DRAINAGE PROTECTIVE DEVICES SUCH AS SWALES, INTERCEPTION DITCHES, PIPES PROTECTIVE BERMS,
- CONCRETE CHANNELS OR OTHER MEASURES DESIGNED TO PROTECT PROPOSED AND EXISTING IMPROVEMENTSFROM RUNOFF OR DAMAGE FROM STORM WATER, MUST BE CONSTRUCTED PRIOR TO THE CONSTRUCTION OF ANY IMPROVEMENTS.

TOWN OF PARADISE VALLEY GENERAL HILLSIDE NOTES

- NO CERTIFICATE OF OCCUPANCY SHALL BE ISSUED UNTIL ALL HILLSIDE STIPULATIONS AND ALL TOWN CODE REQUIREMENTS ARE COMPLIED INCLUDING, BUT NOT LIMITED TO LANDSCAPING, GROUND RESTORATION, FIRE FLOW, FIRE SAFETY AND ALL ONSITE AND OFFSITE IMPROVEMENTS. ALL OUTDOOR LIGHTING SHALL BE IN CONFORMANCE WITH ARTICLE XXII OF THE TOWN ZONING ORDINANCE
- 3. ALL EXCESS FILL MATERIAL SHALL BE REMOVED FROM THE SITE WITH NO NEW SPILL SLOPES. 4. THE USE OF HYDRAULIC RAM HAMMERS, OR OTHER HEAVY EQUIPMENT USED TO CUT THROUGH ROCK,
- INCLUDING MACHINERY WITH AUDIBLE BACK UP WARNING DEVICES SHALL BE LIMITED TO USE BETWEEN THE HOURS OF 7:00AM OR SUNRISE, WHICHEVER IS LATER, AND 6:00PM OR SUNSET, WHICHEVER IS EARLIER, MONDAY THROUGH FRIDAY, WITH LIMITED WORK ON SATURDAY AND NO WORK ON SUNDAY OR LEGAL HOLIDAYS. RAM HAMMERS AND OTHER HEAVY EQUIPMENT CANNOT BE USED ON SATURDAYS WITHOUT A WAIVER FROM THE TOWN MANAGER.
- CONSTRUCTION STAKING AND /OR FENCING SHALL BE PLACED AROUND THE CONSTRUCTION SITE SO AS TO PROTECT THE UNDISTURBED NATURAL AREA.
- . ALL RETAINING WALLS SHALL NOT EXTEND MORE THAN 6 INCHES ABOVE THE MATERIAL THEY RETAIN (WITH EXCEPTION OF DRIVEWAY RETAINING WALLS IN ACCORDANCE WITH 2207.VI.6).

ENGINEERS NOTES

- 2. ALL WORK REQUIRED TO COMPLETE THE CONSTRUCTION COVERED BY THIS PLAN SHALL BE IN ACCORDANCE WITH THE M.A.G. STANDARD SPECIFICATIONS AND DETAILS AND CURRENT SUPPLEMENTS THEREOF PER THE LOCAL CITY OR TOWN UNLESS SPECIFIED OTHERWISE IN THESE PLANS OR ELSEWHERE IN THE CONTRACT DOCUMENTS. CONTRACTORS SHALL FAMILIARIZE THEMSELVES WITH ALL REQUIRED STANDARD SPECIFICATIONS, DETAILS AND
- SUPPLEMENTS PRIOR TO BIDDING THE WORK FOR THE CONSTRUCTION COVERED BY THIS PLAN. GRADING SHALL BE IN CONFORMANCE WITH 2012 IBC SEC. 1803 AND APPENDIX J. 5% MINIMUM SLOPE AWAY FROM BUILDING FOR A MINIMUM 10', U.N.O.
- 5. ALL CONSTRUCTION SHALL CONFORM TO THE LATEST MARICOPA ASSOCIATION OF GOVERNMENTS (M.A.G.) SPECIFICATIONS AND STANDARD DETAILS.
- 6. A DUST CONTROL PLAN MEETING THE REQUIREMENTS OF RULE 310 OF THE MARICOPA COUNTY AIR POLLUTION CONTROL REGULATIONS, AS AMENDED, IS REQUIRED.
- A SEPARATE PERMIT IS NECESSARY FOR ANY OFFSITE CONSTRUCTION. 8. AN APPROVED GRADING AND DRAINAGE PLAN SHALL BE ON THE JOB SITE AT ALL TIMES. DEVIATIONS FROM THE PLAN MUST BE PRECEDED BY AN APPROVED PLAN REVISION.
- 9. ALL DRAINAGE PROTECTIVE DEVICES SUCH AS SWALES, INTERCEPTOR DITCHES, PIPES, PROTECTIVE BERMS, BARRIER WALLS, CONCRETE CHANNELS OR OTHER MEASURES DESIGNED TO PROTECT ADJACENT BUILDINGS OR
- PROPERTY FROM STORM RUNOFF MUST BE COMPLETED PRIOR TO BUILDING CONSTRUCTION. 10. ALL STRUCTURES AND LANDSCAPING WITHIN THE SIGHT VISIBILITY TRIANGLE SHALL HAVE A 2 FOOT MAXIMUM HEIGHT.
- 11. ALL PATIOS, WALKS, AND DRIVES TO SLOPE AWAY FROM BUILDING AND GARAGES AT A MINIMUM SLOPE OF 1/4" PER FOOT UNLESS SPECIFIED OTHERWISE. ALL LAWN AREAS ADJOINING WALKS OR SLABS WILL BE GRADED TO 2" BELOW THE TOP OF SLAB. TYPICAL FINISHED GRADE AROUND PERIMETER OF BUILDING IS MINUS 6" BELOW
- FINISHED FLOOR UNLESS SPECIFIED OTHERWISE. ALL MATERIAL TO BE UNDER SLABS AND WALKS SHALL BE COMPACTED TO NOT LESS THAN 95% PER ASTM D698. 13. THE QUANTITIES AND SITE CONDITIONS DEPICTED IN THESE PLANS ARE FOR INFORMATIONAL PURPOSES ONLY AND ARE SUBJECT TO ERROR AND OMISSION. CONTRACTORS SHALL SATISFY THEMSELVES AS TO ACTUAL QUANTITIES AND SITE CONDITIONS PRIOR TO BIDDING THE WORK FOR THE CONSTRUCTION COVERED BY THIS PLAN. 14. THE CONTRACTOR IS RESPONSIBLE FOR OBTAINING AND COMPLYING WITH ALL PERMITS REQUIRED TO COMPLETI
- ALL WORK COVERED BY THIS PLAN.
- 15. THE CONTRACTOR IS RESPONSIBLE FOR ALL METHODS, SEQUENCING, AND SAFETY CONCERNS ASSOCIATED WITH THIS PROJECT DURING CONSTRUCTION. UNLESS SPECIFICALLY ADDRESSED OTHERWISE IN THIS PLAN OR ELSEWHERE.
- 16. A REASONABLE EFFORT HAS BEEN MADE TO SHOW THE LOCATIONS OF EXISTING UNDERGROUND FACILITIES AND UTILITIES IN THE CONSTRUCTION AREA. THE CONTRACTOR IS RESPONSIBLE FOR ANY DAMAGE TO UTILITIES AND/OR FACILITIES CAUSED DURING THEIR CONSTRUCTION OPERATIONS. THE CONTRACTOR SHALL CALL 48 HOURS IN ADVANCE FOR BLUE STAKE (1-800-STAKE-IT) PRIOR TO ANY EXCAVATION.
- 17. THE CONTRACTOR IS RESPONSIBLE FOR ALL COORDINATION OF CONSTRUCTION AFFECTING UTILITIES AND THE COORDINATION OF ANY NECESSARY UTILITY RELOCATION WORK.
- 18. ALL PAVING, GRADING, EXCAVATION, TRENCHING, PIPE BEDDING, CUT, FILL AND BACKFILL SHALL COMPLY WITH THE RECOMMENDATIONS SET FORTH IN THE SOILS (GEOTECHNICAL) REPORT FOR THIS PROJECT IN ADDITION TO THE REFERENCED REQUIRED SPECIFICATIONS AND DETAILS.
- 19. THE CONTRACTOR IS TO VERIFY THE LOCATION AND THE ELEVATIONS OF ALL EXISTING UTILITIES AT POINTS OF TIE-IN PRIOR TO COMMENCING ANY NEW CONSTRUCTION. SHOULD ANY LOCATION OR ELEVATION DIFFER FROM THAT SHOWN ON THESE PLANS. THE CONTRACTOR SHALL CONTACT THE OWNER'S AGENT.
- 20. CONTRACTOR TO VERIFY AND COORDINATE ALL DIMENSIONS AND SITE LAYOUT WITH ARCHITECTURE'S FINAL SITE PLAN AND FINAL BUILDING DIMENSIONS BEFORE STARTING WORK. REPORT DISCREPANCIES TO OWNER'S AGENT. 21. COORDINATION BETWEEN ALL PARTIES IS ESSENTIAL PART OF CONTRACT.
- 22. CONTRACTOR IS RESPONSIBLE FOR PROJECT AND SITE CONDITIONS, AND TO WORK WITH WEATHER CONDITIONS AS THE PROJECT SITE MAY BE LOCATED IN A FLOOD PRONE AREA AND SUBJECT TO FLOODING AND ITS HAZARDS. 23. THE CONTRACTOR IS TO VERIFY THE LOCATION, ELEVATION, CONDITION, AND PAVEMENT CROSS-SLOPE OF ALL EXISTING SURFACES AT POINTS OF TIE-IN AND MATCHING, PRIOR TO COMMENCEMENT OF GRADING, PAVING, CURB AND GUTTER, OR OTHER SURFACE CONSTRUCTION. SHOULD EXISTING LOCATIONS, ELEVATIONS, CONDITION, OR PAVEMENT CROSS-SLOPE DIFFER FROM THAT SHOWN ON THESE PLANS. RESULTING IN THE DESIGN INTENT
- REFLECTED ON THESE PLANS NOT ABLE TO BE CONSTRUCTED. THE CONTRACTOR SHALL NOTIFY THE OWNER'S AGENT IMMEDIATELY FOR DIRECTION ON HOW TO PROCEED PRIOR TO COMMENCEMENT OF CONSTRUCTION. THE CONTRACTOR ACCEPTS RESPONSIBILITY FOR ALL COSTS ASSOCIATED WITH CORRECTIVE ACTION IF THESE PROCEDURES ARE NOT FOLLOWED.
- 24. CONTRACTOR IS RESPONSIBLE TO COORDINATE UTILITY CROSSINGS AT CULVERT CROSSINGS BEFORE STARTING WORK ON CULVERT. COORDINATE WITH OWNER REPRESENTATIVE. VERIFY UTILITY LINES AND/OR CONDUITS ARE IN PLACE BEFORE STARTING CULVERT WORK.
- 25. ALL ON-SITE UTILITIES PER OTHERS. 26. THIS PROJECT REQUIRES A REGULAR ONGOING MAINTENANCE PROGRAM FOR THE DESIGNED DRAINAGE SYSTEM(S) TO PRESERVE THE DESIGN INTEGRITY AND THE ABILITY TO PERFORM ITS OPERATIONAL INTENT. FAILURE TO PROVIDE MAINTENANCE WILL JEOPARDIZE THE DRAINAGE SYSTEM(S)' PERFORMANCE AND MAY LEAD TO IT'S INABILITY TO PERFORM PROPERLY AND/OR CAUSE DAMAGE ELSEWHERE IN THE PROJECT
- 27. IF A DISCREPANCY IS FOUND BETWEEN ENGINEER'S PLAN OR SURVEYOR'S STAKING AND THE ARCHITECTURAL PLAN. ENGINEER SHALL BE NOTIFIED IMMEDIATELY. FAILURE TO NOTIFY ENGINEER SHALL NEGATE ENGINEER'S LIABILITY.
- 28. ALL DISTURBED AREAS ARE TO BE ROPED AND ROPING MUST MATCH PLAN.
- 29. VEGETATION OUTSIDE OF CONSTRUCTION AREA TO REMAIN. 30. AREAS OUTSIDE THE WALL AND CUT AND FILL SLOPES SHALL BE REVEGETATED WITH SIMILAR PLANT TYPES AND DENSITIES FOUND ON THE SITE. REVEGETATION SHALL BE COMPLETED PRIOR TO OCCUPANCY AND THE ISSUANCE OF A CERTIFICATE OF OCCUPANCY.
- MECHANICAL EQUIPMENT SHALL BE SCREENED TO A MINIMUM OF ONE FOOT ABOVE TOP OF EQUIPMENT.
- 32. ANY FUTURE IMPROVEMENTS SHOWN HEREON SHALL REQUIRE A SEPARATE PERMIT. SITE PLAN TO DETERMINE FINAL HOUSE, WALL, STEP, ETC., LOCATIONS AND ELEVATIONS.
- 33. ANY POINTS OF DRAINAGE CONCENTRATION SHOULD BE PROTECTED AGAINST EROSION WITH NATIVE STONE. 34. THIS PLAN IS DESIGNED TO SHOW SITE GRADING AND DRAINAGE CONTRACTOR SHALL USE THE ARCHITECTURAL
- DETAILS. TOP OF FOOTING ELEVATIONS SHOWN IN PLAN ARE APPROXIMATE ONLY. ACTUAL TOP OF FOOTINGS TO BE DETERMINED AT TIME OF CONSTRUCTION AND TO BE A MINIMUM OF SIX INCHES BELOW EXISTING NATURAL
- 35. ALL DRAINAGE FACILITIES TO BE MAINTAINED BY HOMEOWNER. 36. SEE ARCHITECTURAL AND STRUCTURAL PLANS FOR SITE AND RETAINING WALLS LAYOUT, DIMENSIONS, AND GRADE OR FINISHED GRADE WHICHEVER IS LOWER (TYPICAL)
- 37. REFER TO ARCHITECTURAL DRAWINGS FOR BUILDING LAYOUT, DIMENSIONS AND ELEVATIONS. 38. REFER TO STRUCTURAL DRAWINGS, DETAILS AND CALCULATIONS FOR ALL PROPOSED RETAINING WALLS.
- 39. FOR CHANGE IN ELEVATION THAT ARE GREATER THAN 30", PROVIDE 36" HIGH GUARDRAILS FOR TOTAL OF 42" FALL PROTECTION BARRIER U.N.O.
- 40. CONTRACTOR TO PROVIDE POSITIVE DRAINAGE AWAY FROM STRUCTURE 5% MIN SLOPE FOR FIRST 10 FEET, UNO
- 41. ALL WATER AND SEWER LINES AND CONNECTIONS MUST BE INSTALLED PER IPC 2012, MAG AND TOWN OF PARADISE VALLEY SUPPLEMENT TO MAG.
- 42. WATERPROOF ALL EXTERIOR WALLS 18" ABOVE FINISH GRADE-(BITUTHENE® 3000 HC MEMBRANE W/ GRACE PROTECTION 03 OR APPROVED EQUAL)
- 43. ALL PIPES AND FITTINGS SHALL BE INSTALLED PER MANUFACTURE'S SPECIFICATIONS AND DETAILS. 44. ABANDONMENT OF EXISTING AND INSTALLATION OF NEW SEPTIC SYSTEMS SHALL BE PERFORMED IN ACCORDANCE WITH THE MARICOPA COUNTY ENVIRONMENTAL SERVICES DEPARTMENT RULES AND STANDARDS, AND WILL REQUIRE SEPARATE PERMIT
- 45. COORDINATE RIPRAP COLOR WITH LANDSCAPE PLANS AND DETAILS. 46. VERIFY AND COORDINATE WITH LANDSCAPE PLANS FINAL LOCATION AND GRATE TYPE OF SPECIFIED AREA DRAINS AND TRENCH DRAINS.
- 47. VERIFY AND COORDINATE WITH ARCHITECTURAL AND LANDSCAPE PLANS LOCATION AND HEIGHT OF ALL SITE WALLS
- 48. DISTURBED AREA: TOTAL ACRES = 0.5 ACRES < 1 ACRE; NPDES PERMIT IS NOT REQUIRED. 49. REFER TO ARCHITECTURAL PLANS AND DETAILS FOR DEMOLITION AND REMOVAL OF ANY EXISTING BUILDING STRUCTURES, SITE WALLS, POOL AND PAVEMENT ETC.
- 50. REFER TO GEOTECHNICAL REPORT FOR SPECIFIC RECOMMENDATIONS AND MAXIMUM ALLOWED FILL AND CUT SLOPES.

LOCATED IN A PORTION OF THE NW 1/4 OF 1/4 OF SECTION 17, T.2N, R.4E OF THE ICOPA COUNTY, ARIZONA GILA & SALT RIVER BASE AND

PRELIMINARY GRADING & DRAINAGE PLAN TONN RESIDENCE 5429 E SOLANO DR., PARADISE VALLEY, AZ 85253

LOT 19 - STONE CANYON EAST

RECORDED IN BOOK 81 OF MAPS, PAGE 34, M.C.R.,

1. MARICOPA ASSOCIATION OF GOVERNMENTS (M.A.G.) UNIFORM STANDARD SPECIFICATIONS AND DETAILS FOR PUBLIC WORKS CONSTRUCTION (LATEST EDITION INCLUDING LATEST REVISION AND CURRENT SUPPLEMENTS THEREOF PER THE LOCAL TOWN OR CITY) ARE INCORPORATED INTO THIS PLAN IN THEIR ENTIRETY.

ND SECTION CORNER 1/4 QUARTER
1/4 QUARTER
1/4 QUARTER
•
BRASS CAP FLUSH
FOUND 1/2" REBAR & TAG OR AS NOTED
SET 1/2" REBAR & TAG OR AS NOTED
CALCULATED POINT
PROPERTY LINE
EASEMENT LINE
MONUMENT LINE
SIGN WATER METER
WATER METER
FIRE HYDRANT
GAS METER
IRRIGATION CONTROL BOX
SEWER CLEANOUT
IRRIGATION CONTROL VALVE
SEWER MANHOLE
CABLE TV RISER CABLE TV BOX
GAS MARKER
MAILBOX
CATV, PHONE
SEWER LINE
WATER LINE
ELECTRIC LINE
COMMUNICATIONS LINE
FIBER OPTIC LINE
TREE EXIST. SPOT ELEVATION
EXISTING DISTURBED AREA
FLOW LINE
DRAINAGE FLOW ARROW
PROPOSED SPOT ELEVATION
, PROPOSED CONTOUR
TOP OF RAILING/NON-RET. W TOP OF RETAINING WALL
FINISH GRADE TOP OF FOOTING
FINISH GRADE AT BOTTOM OF
CATCH BASIN
STORM DRAIN PIPE
HISTORIC NATURAL GRADES PER FCDMC AERIAL TOPOGRAF
RETAINING WALL RETAINING AGAINST THE BUILI

BACK OF CURB

- BUILDING SETBACK LINE BSL BW BOTTOM OF WALL
- C11 CURVE LABEL
- CONCRETE, CALCULATED
- CENTERLINE
- TPV TOWN OF PARADISE VALLEY DE DRAINAGE EASEMENT
- ESMT EASEMENT
- EX, EXISTING EXIST.
- EXISTING GRADE EG FINISH GRADE
- FFF FINISH FLOOR ELEVATION
- FLOW LINE
- FOUND FND G GUTTER, GAS
- INV INVERT
- L11 LINE LABEL MARICOPA ASSOCIATION OF GOVERNMENTS MAG
- (M) MEASURED
- MCR MARICOPA COUNTY RECORDER PAVEMENT
- PUE PUBLIC UTILITY EASEMENT
- (R) RECORDED
- RADIUS R/W RIGHT OF WAY
- TANGENT, TELEPHONE
- WEST, WATERLINE
- TOP OF PARAPET
- TOP OF CURB TOP OF GRATE
- TOP OF FOOTING
- TOP OF RAILING TOP OF RETAINING WALL TRW
- TW TOP OF WALL WM WATER METER

DISTURBED AREA CALCULATIONS

44,542 S.F. (1.0225 AC.)

AREA OF LOT:

TOTAL FLOOR AREA:	6,267 S.F.
FLOOR AREA RATIO:	14.07% < 25%
(TOTAL FLOOR AREA/AREA OF LOT)	
BUILDING PAD SLOPE:	12.5%
VERTICAL:	17 FT
HORIZONTAL:	136 FT
ALLOWABLE NET DISTURBED AREA:	20,213 S.F. (45.38%)
EXISTING GROSS DISTURBED AREA:	18,846 S.F.
LESS EXISTING BUILDING FOOTPRINT:	<u>3,668 S.F.</u>
EXISTING NET DISTURBED AREA:	15,178 S.F. (34.1%)
PROPOSED GROSS DISTURBED AREA:	19,381 S.F.
LESS TEMPORARY AREAS OF DISTURE TO BE RESTORED AND REVEGETATED:	
LESS 25% CREDIT FOR NEW PAVERS UNDER 18" OF NATURAL GRADE: 3,3	•
LESS BUILDING FOOTPRINT AREA:	4,694 S.F.
PROPOSED NET DISTURBED AREA:	13,858 S.F. < 20,213 S.
ALLOWED SLOPES STEEPER	
THAN NATURAL GRADE (5% MAX.):	2,227 S.F. (5%)
PROPOSED SLOPES STEEPER	
THAN NATURAL GRADE (AREA):	2,092 S.F. (4.7%)
EARTHWORK BASED ON HISTORIC VAC	CANT SITE CONDITION:
VOLUME OF CUT:	3,369 C.Y.
VOLUME OF FILL:	8 C.Y.
TOTAL CUT&FILL:	3,377 C.Y.

GRADING PERMIT FEE: \$3,255.15

HILLSIDE ASSURANCE @ 35 TIMES GRADING PERMIT FEE: \$113,930.25 2. A NEW SINGLE FAMILY RESIDENCE IS PROPOSED FOR THIS SITE. ALL QUANTITIES LISTED ON THESE PLANS ARE ESTIMATES ONLY. THE CONTRACTOR SHALL MAKE THEIR OWN DETERMINATION OF THE QUANTITIES AND BASE THEIR BIDS ON THEIR ESTIMATES.

EARTHWORK QUANTITIES (CURRENT CONDITION) CUT: 331 C.Y.

FILL: 108 C.Y. NET CUT: 223 C.Y.

ALL QUANTITIES LISTED ON THESE PLANS ARE ESTIMATES ONLY. NO SHRINK OR SWELL IS ASSUMED. THE CONTRACTOR SHALL MAKE THEIR OWN DETERMINATION OF THE QUANTITIES AND BASE THEIR BIDS ON THEIR ESTIMATES.

UTILITIES NOTES

HORIZONTAL AND VERTICAL LOCATIONS OF ALL EXISTING UTILITIES SHOWN ON THE PLAN ARE APPROXIMATE ONLY AND WILL BE FIELD VERIFIED BY CONTRACTOR PRIOR TO START OF CONSTRUCTION WORK. CALL BLUE STAKE @ (602) 263-1100.

FIRE SPRINKLER SYSTEM

OTTOM OF WALL FIRE SPRINKLER SYSTEM TO BE INSTALLED PER THE REQUIREMENTS OF THE TOWN OF PARADISE VALLEY AND IN ACCORDANCE WITH I.B.C. SECT. 904.2.2 AMD. AND I.F.C. SECT. 1003.2.1 AMD.

FLOOD INSURANCE RATE MAP (FIRM) DATA

COMMUNITY #	PANEL #	SUFFIX	BASED FLOOD
040049	1765 OF 4425	L	
MAP #	PANEL DATE	ZONE	ELEVATION
04013C	10/16/2013	X*	N/A

*AREAS DETERMINED TO BE OUTSIDE THE 0.2% ANNUAL CHANCE FLOODPLAIN;


ON-SITE RETENTION FOR THE PRE VS. POST DEVELOPMENT RUNOFF FROM 100-YEAR, 2-HOUR STORM EVENT					
V=DxAx(Cpost-Cpre)/12=(0.95-0.80) D-RAINFALL DEPTH=2.82" A-TRIBUTARY AREA, SF Cw-WEIGHTED RUNOFF COEFFICIENT					
	AREA	RUNOFF COEFFICIENT	Volume Required	RETENTION TYPE	VOLUME PROVIDED
AREA	S.F.	Cw	C.F.	0	C.F.
A	5,206*	0.15	184	28' LONG (36" DIA) UNDERGROUND STORM WATER STORAGE	163
В	3,560 *	0.15	125	18' LONG (36" DIA) UNDERGROUND STORM WATER STORAGE	127
TOTAL			309		290

*HARDSCAPE AND ROOF ONLY

HISTORIC EARTHWORK QUANTITIES CUT: 3975 C.Y.

FILL: 9 C.Y. NET CUT: 3966 C.Y.

ALL QUANTITIES LISTED ON THESE PLANS ARE ESTIMATES ONLY. NO SHRINK OR SWELL IS ASSUMED. THE CONTRACTOR SHALL MAKE THEIR OWN DETERMINATION OF THE QUANTITIES AND BASE THEIR BIDS ON THEIR ESTIMATES.

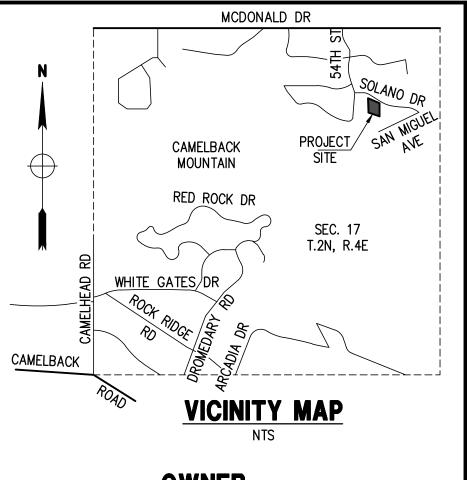

LEGAL DESCRIPTION

LOT 18 AS SHOWN ON THE PLAT OF STONE CANYON EAST RECORDED IN BOOK 81 OF MAPS, PAGE 34, MARICOPA COUNTY RECORDERS OFFICE.

BENCHMARK

BRASS CAP IN HANDHOLE LOCATED AT THE INTERSECTION OF MCDONALD DRIVE AND N. 56TH STREET SAID POINT ALSO BEING THE N.E. CORNER SECTION 17, T. 2N., R. 4E., G.&S.R.B.&M.;

ELEVATION = 1417.53 TOWN OF PARADISE VALLEY DATUM 6" AND

T.B.M.: BRASS CAP FLUSH LOCATED AT A POINT OF TANGENCY ALONG E. SOLANO DRIVE CENTERLINE NORTH OF LOT 18 OF STONE CANYON EAST. SHOWN HEREON.

ELEVATION = 1468.84

BASIS OF BEARINGS

CENTERLINE OF EAST SOLANO DRIVE WHICH BEARS S58'30'51"E AS SHOWN ON THE PLAT OF STONE CANYON EAST RECORDED IN BOOK 81 OF MAPS, PAGE 34. M.C.R.

DRAINAGE STATEMENT

- 1. ULTIMATE STORM OUTFALL IS LOCATED AT THE NORTHWEST PROPERTY LINE AT ELEVATION OF 1466.70.
- 3. PROPOSED DEVELOPMENT DOES NOT IMPACT DRAINAGE CONDITIONS OF ADJOINING LOTS.
- 4. HISTORIC DRAINAGE PATTERNS ARE PRESERVED. 5. PERMEABLE PAVERS ARE PROVIDED FOR THE PROPOSED DRIVEWAY TO
- REDUCE THE STORMWATER RUNOFF TO PRE-DEVELOPMENT CONDITIONS. 6. THE MINIMUM FINISH FLOOR ELEVATIONS SHOWN ARE SAFE FROM INUNDATION DURING A 100-YEAR PEAK RUN-OFF EVENT IF CONSTRUCTED PER APPROVED PLANS.

GRADING SPECIFICATIONS

- 1. EXCAVATION AND GRADING OF THIS SITE IS CLASSIFIED AS "ENGINEERED GRADING" PER 2015 I.B.C. AND WILL BE PERFORMED ACCORDINGLY.
- 2. THE CONTRACTOR WILL RETAIN A SOILS ENGINEER DURING CONSTRUCTION TO INSPECT PROGRESS OF CONSTRUCTION. CONCERNING PREPARATION OF GROUND TO RECEIVE FILLS, TESTING AND REQUIRED COMPACTION STABILITY OF ALL FINISH SLOPES INCLUDING CUT SLOPES.
- 3. COMPACTION SHALL COMPLY WITH M.A.G. SECTION 601 AND PROVISIONS AS SET FORTH IN THE APPROVED GEOTECHNICAL REPORTS. 4. CUT AND FILL SLOPES SHALL BE PER THE APPROVED GEOTECHNICAL
- REPORT. 5. ANY RETAINING WALLS ADJACENT TO THE PROPERTY LINES WILL BE UNDER THE SCOPE OF SPECIAL INSPECTION BY THE SOILS ENGINEER. THE DEVELOPER SHALL NOTIFY THE ADJOINING PROPERTY OWNERS IN WRITING. TEN DAYS PRIOR TO START OF CONSTRUCTION ON THESE WALLS PER SECTION 2903-B OF I.B.C. THE DEVELOPER WILL HAVE TO
- PROVIDE MEANS OF PROTECTION OF ADJACENT PROPERTY WHILE THIS WORK IS UNDER CONSTRUCTION. 6. THE USE OF HYDRAULIC RAM HAMMERS AND HEAVY EQUIPMENT SHALL BE LIMITED TO USE BETWEEN THE HOURS OF 7:00AM AND 6:00PM
- MONDAY THROUGH SATURDAY WITH NO WORK ON SUNDAY. GEOTECHNICAL ENGINEER SHALL INSPECT AND ACCEPT THE INTEGRITY OF THE EXISTING ROCK CUTS AND ANCHORS.

OWNER TONN INVESTMENTS. L.L.C. 4350 E. CAMELBACK RD. PHOENIX, AZ. 85018 P: 602-684-1000 CONTACT: SCOTT TONN EMAIL: STONN@TONNINV.COM

SITE DATA

172-47-063 APN: ADDRESS: 5429 E SOLANO DRIVE PARADISE VALLEY, AZ 85253 ZONING: R-43 (HILLSIDE) LOT AREA: 44,542 S.F. (1.0225 AC.)

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PLAN

Reliminary & Drainage Ver Sheet

PRI G &

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ICE DR., Z 855

RESIDENC Solano 'Alley, Az

TON 5429 Radise

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ARCHITECT

A-I-R, INC, 7610 E MCDONALD DR., SUITE K, SCOTTSDALE, AZ 85250 P: 480 329 1888

LAND SURVEYOR

SITE CONSULTANTS, INC. 113 S ROCKFORD DR TEMPE, AZ 85281 P: 480 894 2820

SHEET INDEX

SHFFT C-1	_	COVER SHEET
		OVERALL SITE TOPOGRAPH
SHEET O Z		HISTORIC CONTOURS
		DISTURBANCE CALCULATION
		DETAILS
		DETTILO
SHEET C-3	-	GRADING & DRAINAGE PLAN


UTILITIES

WATER: EPCOR WATER SANITARY SEWER: SEPTIC ELECTRIC: ARIZONA PUBLIC SERVICE TELEPHONE: CENTURY LINK, COX COMMUNICATION NATURAL GAS: SOUTHWEST GAS CABLE TV: CENTURY LINK, COX COMMUNICATIONS

APPROVAL

TOWN ENGINEER TOWN OF PARADISE VALLEY

DATE

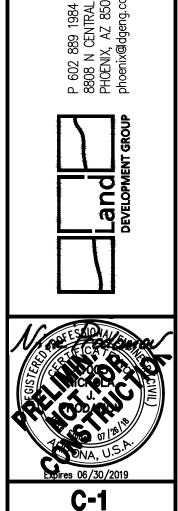

OF .

BLUE STAKE, INC. Call 811 or click Arizona811.com

Contact Arizona 811 at least two full

orking days before you begin excavati

