The Scherr Residence

5416 E. Desert Jewel Drive, Paradise Valley, Arizona

A-0 COVER SHEET

C-1 COVER SHEET - GRADING & DRAINAGE PLAN

C-2 GRADING & DRAINAGE IMPROVEMENT PLAN

S-1 BOUNDARY & TOPOGRAPHIC SURVEY

A-1.0 SITE PLAN

A-2.0 RENDERING & SITE PHOTOS

A-3.0 EXTERIOR BUILDING LIGHTING PLAN

A-4.0 EXTERIOR ELEVATIONS A-4.1 EXTERIOR ELEVATIONS A-5.0 BUILDING SECTIONS

A-5.1 BUILDING SECTIONS

A-7.0 EXTERIOR MATERIALS

A-6.0 MASSING MODEL





Scherr Residence

5416 E. Desert Jewel Drive, Paradise Valley, AZ

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MARK	DATE	DESCRIPTION

ISSUE: 9/19/17 - CONCEPT REVIEW

PROJECT NO: CAD DWG FILE:

DRAWN BY: CK

CHECKED BY: BK

SHEET TITLE:

COVER

BOUNDARY & TOPOGRAPHIC SURVEY 5416 E DESERT JEWEL DR., PARADISE VALLEY, AZ 85253

LOT 27 - VISTA RICA


A SUBDIVISION PLAT RECORDED IN BOOK 171 OF MAPS, PAGE 28, MCR., LOCATED IN A PORTION OF THE SE 1/4 OF THE SW 1/4 OF THE SE 1/4 OF SECTION 32, T.3N, R.4E OF THE GILA & SALT RIVER BASE AND MERIDIAN, MARICOPA COUNTY, ARIZONA

BOOK 171, PAGE 28, MCR

8015 N 54TH ST

RADISE VALLEY, AZ 85253

S89°59'14"W (M&R)

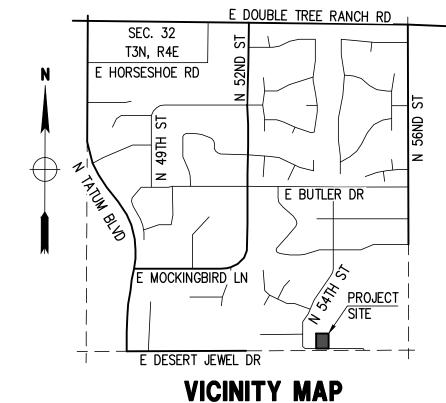

GENERAL NOTES

- THE PREMISES SURVEYED HAVE NO KNOWN DISCREPANCIES, BOUNDARY LINE CONFLICTS, ENCROACHMENTS, OVERLAPPING OF IMPROVEMENTS, EASEMENTS OR RIGHT-OF-WAYS EXCEPT AS SHOWN, AND HAS ACCESS TO OR FROM A DEDICATED ROADWAY
- AS SHOWN ARE BASED ON INFORMATION PROVIDED BY THE HEREON ARE IN THE EXACT LOCATION INDICATED ALTHOUGH HE DOES CERTIFY THAT THEY ARE LOCATED AS ACCURATELY AS
- ZONING OR OTHER LAND USE REGULATIONS, AND ANY OTHER FACTS WHICH AN ACCURATE AND CURRENT TITLE SEARCH MAY
- THE DESCRIPTION OF PROPERTY BOUNDARIES AND EASEMENTS BOOK 171 OF MAPS, PAGE 28, AND DEED REC. DOC. 2017-0040925, RECORDS OF MARICOPA COUNTY, ARIZONA.
- PART OF THIS SURVEY IS NOTED HEREON. ONLY THE DOCUMENTS NOTED HEREON WERE SUPPLIED OR AVAILABLE TO THE SURVEYOR AT THE TIME OF THE SURVEY. THERE MAY EXIST OTHER DOCUMENTS OF RECORD, WHICH WOULD AFFECT THIS PARCEL.
- 7. ANY INFORMATION SHOWN WHICH MAY VARY FROM THE CONTENTS OF THE REPORT(S) NOTED ABOVE, REPRESENTS INFORMATION AND MEASUREMENTS FOUND DURING THE COURSE OF THE SURVEY.
- ON-SITE PLANT INFORMATION SHOWN HEREON IS FOR REFERENCE ONLY. SURVEYOR ASSUMES NO LIABILITY FOR THE EVALUATION, SALVAGEABILITY, REMOVAL AND/RELOCATION OF ON-SITE PLANT
- 9. ALL MEASURED BEARINGS AND DISTANCES EQUAL RECORD UNLESS NOTED OTHERWISE.
- 10. THE SURVEY MAP WAS PREPARED WITHOUT THE BENEFIT OF A TITLE REPORT.
- 11. ANY AERIAL MAPS SHOWN ON THIS PLAN ARE FOR REFERENCE ONLY AND DO NOT NECESSARILY DEPICT THE EXACT CURRENT

OWNER

JASON SCHERR 6843 LOST GARDEN TER PARKLAND, FL 33076

SITE DATA

ADDRESS: 5416 E DESERT JEWEL DR PARADISE VALLEY, AZ 85253 LOT AREA: 43,655 S.F (1.002 AC.)

LEGAL DESCRIPTION

LOT 27, OF VISTA RICA, ACCORDING TO THE PLAT OF RECORD IN THE OFFICE OF THE COUNTY RECORDER OF MARICOPA COUNTY, ARIZONA, RECORDED IN BOOK 171 OF MAPS, PAGE 28.

CONTAINING 43,655 S.F (1.002 AC.); MORE OR LESS.

THE SOUTH LINE OF LOTS 26.27 AND 28 BASED ON THE FOUND MONUMENTATION SHOWN ON THE SURVEY, THE BEARING OF WHICH IS N89°49'14"E, PER PLAT OF VISTA RICA, BOOK 171, PAGE 28, MCR.

BENCHMARK

BRASS CAP FLUSH AT THE INTERSECTION OF MOCKINGBIRD LANE AND 56TH STREET HAVING AN ELEVATION OF 1349.97 TOWN OF PARADISE VALLEY (NAVD 88) DATUM, GDACS# 26101-1

SURVEY REFERENCES

- 1. EASEMENTS, RESTRICTIONS, RESERVATIONS, CONDITIONS AND SETBACK LINES AS SET FORTH ON THE PLAT RECORDED IN BOOK 171 OF MAPS, PAGE 28, MCR.
- 2. WARRANTY DEED RECORDED IN DOC. NO. 2017-0040925, M.C.R.

UTILITIES

WATER: CITY OF PHOENIX SANITARY SEWER: TOWN OF PARADISE VALLEY ELECTRIC: ARIZONA PUBLIC SERVICE TELEPHONE: CENTURY LINK, COX COMMUNICATIONS NATURAL GAS: SOUTHWEST GAS CABLE TV: CENTURY LINK, COX COMMUNICATIONS

SCALE 1" = 20'


FLOOD INSURANCE RATE MAP (FIRM) DATA

<u> </u>			· •• • • • • • • • • • • • • • • • • •	
COMMUNITY # 040049	PANEL # 1765 OF 4425	SUFFIX L	BASED FLOOD	
MAP # 04013C	PANEL DATE 10/16/2013	ZONE X*	ELEVATION N/A	

*AREAS DETERMINED TO BE OUTSIDE THE 0.2% ANNUAL CHANCE FLOODPLAIN

CERTIFICATE OF SURVEY

THIS IS TO CERTIFY THAT THIS MAP AND THE SURVEY ON WHICH IT IS BASED WERE MADE IN ACCORDANCE WITH THE CURRENT "MINIMUM STANDARDS FOR ARIZONA BOUNDARY AND TOPOGRAPHIC SURVEYS", AND THAT THE SURVEY SHOWN HEREON IS TRUE AND CORRECT TO THE BEST OF MY KNOWLEDGE AND BELIEF AND WAS SURVEYED AND DRAWN UNDER MY

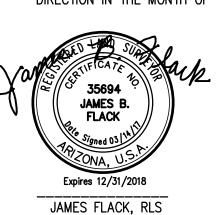

03/14/17

F			
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DIRECTION IN THE MONTH OF MARCH, 2017.

OF

FOUND REBAR, CAP ILLEGIBLE	on A		
54TH ST	S89'59'14"W (M&R) FOUND REBAR, CAP ILLEGIBLE	176.30' (M&R)	-1-
FOUND REBAR NO TAG	S89°59'14"W		
		EXIST. SSMH RIM=1416.18 INV(W)=1407.88 INV(E)=1408.18	s —/

LEGEND

 $\triangleright 0$

-0-0-0-

SECTION CORNER

1/4 QUARTER

SCRIBED "X" IN CONCRETE

BRASS CAP IN HANDHOLE

FOUND REBAR OR AS NOTED

SET 1/2" REBAR & TAG

CALCULATED POINT

SEWER MANHOLE

WATER METER

WATER VALVE

FIRE HYDRANT

TELEPHONE PEDESTAL

COMMUNICATIONS LINE

EXISTING CONTOUR

PALO VERDE TREE

ROCK OUTCROPPING

CACTUS

EXIST. DRAINAGE FLOW

EXIST. SPOT ELEVATION

CABLE TV RISER

BRASS CAP FLUSH

ABBREVIATIONS

CURVE LABEL

CENTERLINE

ELEVATION

EASEMENT

FINISH GRADE FLOW LINE

GUTTER, GAS

LINE LABEL

MEASURED

MANHOLE PAVEMENT

RECORDED

RETAINING

RIGHT OF WAY

TOP OF GRATE

WEST, WATERLINE

WATER METER

TANGENT, TELEPHONE TOP OF CURB

TOWN OF PARADISE VALLEY TOP OF RETAINING WALL

WALL DRAINAGE OPENING

RADIUS

JOINT USE & BENEFIT EASEMENT

PUBLIC UTILITY EASEMENT

INVERT

EX, EXIST. EXISTING

ESMT

BUILDING SETBACK LINE

DRAINAGE EASEMENT

EXISTING GRADE



TOWN OF PARADISE VALLEY NOTES

- GRADING SHALL BE IN CONFORMANCE WITH 2015 IBC.
- PRIOR TO FIRST FOOTING INSPECTION OF ANY TYPE. ALL PROPERTY PINS SHALL BE PLACED BY A REGISTERED LAND SURVEYOR OF THE STATE OF ARIZONA. AND PROPERTY LINES MUST BE PHYSICALLY IDENTIFIED PRIOR TO INSPECTION.
- WHERE EXCAVATION IS TO OCCUR THE TOP 4" OF EXCAVATED NATIVE SOIL SHALL REMAIN ON THE SITE AND SHALL BE REUSED IN A MANNER THAT TAKES ADVANTAGE OF THE NATURAL SOIL SEED BANK IT CONTAINS. ALL CONSTRUCTION SHALL CONFORM TO THE LATEST MARICOPA ASSOCIATION OF GOVERNMENTS (M.A.G.)
- SPECIFICATIONS AND STANDARD DETAILS. ALL EXTERIOR SITE LIGHTING SHALL COMPLY WITH REQUIREMENTS OF SECTION 2208 OF THE TOWN OF PARADISE VALLEY ZONING ORDINANCES FOR FUTURE TYPE, LOCATION, HEIGHT, WATTAGE BASED UPON
- A DUST CONTROL PLAN MEETING THE REQUIREMENTS OF RULE 310 OF THE MARICOPA COUNTY AIR POLLUTION CONTROL REGULATIONS, AS AMENDED, IS REQUIRED.
- A SEPARATE PERMIT IS NECESSARY FOR ANY OFFSITE CONSTRUCTION. AN APPROVED GRADING AND DRAINAGE PLAN SHALL BE ON THE JOB SITE AT ALL TIMES. DEVIATIONS FROM
- THE PLAN MUST BE PRECEDED BY AN APPROVED PLAN REVISION. EAVE PROJECTIONS INTO REQUIRED SETBACKS ARE LIMITED TO A MAXIMUM OF 24" PURSUANT TO SECTION
- 1008 OF THE TOWN OF PARADISE VALLEY ZONING ORDINANCES. . ALL STRUCTURES AND LANDSCAPING WITHIN THE SIGHT VISIBILITY TRIANGLE SHALL HAVE A 2 FOOT MAXIMUM
- ALL NEW AND EXISTING ELECTRICAL SERVICE TO BE BURIED UNDERGROUND PER THE TOWN OF PARADISE
- 2. POOL, SPA, BARBECUE AND ANY PROPOSED STRUCTURES OVER 8 INCHES ABOVE GRADE REQUIRE SEPARATE
- 13. POOLS SHALL BE CONSTRUCTED BY SEPARATE PERMIT AND SECURED FROM UNWANTED ACCESS PER SECTION
- 5-2-2 OF THE TOWN OF PARADISE VALLEY ORDINANCES. 4. A SETBACK CERTIFICATION IS REQUIRED AND MUST BE GIVEN TO TOWN INSPECTOR AT STEM WALL
- HEIGHT, WIDTH AND BREAK AWAY FEATURES. 6. ALL PATIOS, WALKS, AND DRIVES TO SLOPE AWAY FROM BUILDING AND GARAGES AT A MINIMUM SLOPE OF 1/4" PER FOOT UNLESS SPECIFIED OTHERWISE. ALL LAWN AREAS ADJOINING WALKS OR SLABS WILL BE
- MINUS 6" BELOW FINISHED FLOOR UNLESS SPECIFIED OTHERWISE. . ALL MATERIAL TO BE UNDER SLABS AND WALKS SHALL BE COMPACTED TO NOT LESS THAN 95% PER ASTM

GRADED TO 2" BELOW THE TOP OF SLAB. TYPICAL FINISHED GRADE AROUND PERIMETER OF BUILDING IS

- 18. SOILS COMPACTION TEST RESULTS MUST BE SUBMITTED TO THE TOWN ENGINEER'S OFFICE FOR BUILDING PADS THAT HAVE ONE (1) FOOT OR MORE OF FILL MATERIAL INDICATED. THIS INFORMATION MUST BE SUPPLIED PRIOR TO REQUEST FOR FINAL INSPECTION.
- TRENCH BED SHALL BE FREE OF ROCKS AND DEBRIS. 20. REGULATION II RULE 20-3 OF THE MARICOPA COUNTY HEALTH DEPARTMENT, BUREAU OF AIR POLLUTION
- CONTROL SHALL BE OBSERVED AND ENFORCED. ALL WORK REQUIRED TO COMPLETE THE CONSTRUCTION COVERED BY THIS PLAN SHALL BE IN ACCORDANCE WITH THE M.A.G. STANDARD SPECIFICATIONS AND DETAILS AND CURRENT SUPPLEMENTS THEREOF PER THE LOCAL CITY OR TOWN UNLESS SPECIFIED OTHERWISE IN THESE PLANS OR ELSEWHERE IN THE CONTRACT DOCUMENTS. CONTRACTORS SHALL FAMILIARIZE THEMSELVES WITH ALL REQUIRED STANDARD SPECIFICATIONS, DETAILS AND SUPPLEMENTS PRIOR TO BIDDING THE WORK FOR THE CONSTRUCTION COVERED BY THIS PLAN.
- 22. THE CONTRACTOR IS TO COMPLY WITH ALL LOCAL STATE, AND FEDERAL LAWS AND REGULATIONS APPLICABLE TO THE CONSTRUCTION COVERED BY THIS PLAN.
- 23. THE CONTRACTOR IS RESPONSIBLE FOR OBTAINING AND COMPLYING WITH ALL PERMITS REQUIRED TO COMPLETE ALL WORK COVERED BY THIS PLAN.
- 24 . ALL CONSTRUCTION IN THE PUBLIC RIGHTS-OF-WAY OR IN EASEMENTS GRANTED FOR PUBLIC USE MUST CONFORM TO THE LATEST MARICOPA ASSOCIATION OF GOVERNMENTS (MAG) UNIFORM STANDARD SPECIFICATIONS AND UNIFORM STANDARD DETAILS FOR PUBLIC WORKS CONSTRUCTION.
- 25. THE TOWN ONLY APPROVES THE SCOPE, NOT THE DETAIL, OF ENGINEERING DESIGNS; THEREFORE, I CONSTRUCTION QUANTITIES ARE SHOWN ON THESE PLANS, THEY ARE NOT VERIFIED BY THE TOWN. 26. THE APPROVAL OF PLANS IS VALID FOR SIX (6) MONTHS. IF AN ENCROACHMENT PERMIT FOR THE
- CONSTRUCTION HAS NOT BEEN ISSUED WITHIN SIX MONTHS, THE PLANS MUST BE RESUBMITTED TO THE TOWN
- 7. A PUBLIC WORKS INSPECTOR WILL INSPECT ALL WORKS WITHIN THE TOWN OF PARADISE VALLEY RIGHTS-OF-WAY AND IN EASEMENTS. NOTIFY INSPECTION SERVICES 24 HOURS PRIOR TO BEGINNING CONSTRUCTION BY CALLING 480- 312-5750.
- B. WHENEVER EXCAVATION IS NECESSARY, CALL THE BLUE STAKE CENTER, 602—263—1100, TWO WORKING DAYS BEFORE EXCAVATION BEGINS. THE CENTER WILL SEE THAT THE LOCATION OF THE UNDERGROUND UTILITY LINES IS IDENTIFIED FOR THE PROJECT. CALL "COLLECT" IF NECESSARY
- 9. ENCROACHMENT PERMITS ARE REQUIRED FOR ALL WORK IN PUBLIC RIGHTS—OF—WAY AND EASEMENTS GRANTED FOR PUBLIC PURPOSES. AN ENCROACHMENT PERMIT WILL BE ISSUED BY THE TOWN ONLY AFTER THE REGISTRANT HAS PAID A BASE FEE PLUS A FEE FOR INSPECTION SERVICES. COPIES OF ALL PERMITS MUST BE RETAINED ON-SITE AND BE AVAILABLE FOR INSPECTION AT ALL TIMES. FAILURE TO PRODUCE THE REQUIRED PERMITS WILL RESULT IN IMMEDIATE SUSPENSION OF ALL WORK UNTIL THE PROPER PERMIT DOCUMENTATION IS OBTAINED.
- O. ALL EXCAVATION AND GRADING THAT IS NOT IN THE PUBLIC RIGHTS-OF-WAY OR NOT IN EASEMENTS GRANTED FOR PUBLIC USE MUST CONFORM TO CHAPTER 70. EXCAVATION AND GRADING. OF THE LATEST EDITION OF THE IBC BY THE ICC. A PERMIT FOR THIS GRADING MUST BE SECURED FROM THE TOWN FOR A FEE ESTABLISHED BY THE UNIFORM BUILDING CODE.
- EXCAVATIONS SHALL COMPLY WITH REQUIREMENTS OF OSHA EXCAVATION STANDARDS (29 CFR, PART 1926, SUBPART P). UNDER NO CIRCUMSTANCES WILL THE CONTRACTORS BE ALLOWED TO WORK IN A TRENCH LOCATED WITHIN THE TOWN'S RIGHT-OF-WAY WITHOUT PROPER SHORING OR EXCAVATION METHODS. ON DEMOLITION, GRADING, REMODELING AND NEW CONSTRUCTION PROJECTS, PERMITTEE MUST NOTIFY
- ADJACENT PROPERTY OWNERS REGARDING THE NATURE OF THE PROJECT. THE tIME PERIOD FOR CONSTRUCTION, AND ANY UNUSUAL ACTIVITIES THAT MAY CAUSE DISRUPTION OF THE NORMAL COURSE OF TRAFFIC DURING CONSTRUCTION. 33. ALL PERMITTEES MUST POST A 6 SQUARE FOOT (2'X3') IDENTIFICATION SIGN, MADE OF DURABLE MATERIAL,
- IN THE FRONT YARD OF SUBJECT PROPERTY AND NOT IN THE TOWN RIGHT-OF-WAY. THE SIGN MAY NOT EXCEED A MAXIMUM OF 6 FEET IN HEIGHT FROM GRADE TO TOP OF THE SIGN. THE SIGN MUST INCLUDE THE PERMITTEE OR COMPANY NAME, PHONE NUMBER. TYPE OF WORK, AND ADDRESS OF PROJECT. WHEN DEEMED NECESSARY, A 6-FOOT HIGH CHAIN LINK FENCE MUST BE INSTALLED AROUND THE CONSTRUCTION AREA TO PREVENT ANY POTENTIAL SAFETY HAZARD FOR THE PUBLIC. THE FENCE SHALL BE
- SETBACK AT LEAST 10 FEET FROM ALL RIGHTS-OF-WAY AND HAVE A 50-FOOT STREET CORNER SITE TRIANGLE WHERE APPLICABLE. CLEAR ACCESS FOR NEIGHBORING PROPERTIES AND EMERGENCY VEHICLES MUST BE MAINTAINED AT ALL TIMES. CONSTRUCTION RELATED VEHICLES MUST BE LEGALLY PARKED ONLY ON ONE SIDE OF THE STREET OR
- JOB SITE PROPERTY. IF A STAGING AREA IS NEEDED ON A PROPERTY OTHER THAN THE CONSTRUCTION SITE FOR CONSTRUCTION SUPPLIES AND EQUIPMENT, THE PERMITTEE MUST OBTAIN PROPERTY OWNER AND TOWN APPROVAL FIRST AND MUST INFORM THE ADJACENT PROPERTY OWNERS OF THE LOCATION OF STAGING AREA, AND TIME AND HOURS DURING THE DAY THE AREA WILL BE USED.
- E. EXCEPT AS OUTLINED IN ITEM 4, ALL CONSTRUCTION DEBRIS AND EQUIPMENT MUST BE CONTAINED ON SITE AT ALL TIMES. CONTRACTOR AND PROPERTY OWNER MUST MAINTAIN THE JOB SITE FREE OF LITTER AND UNSIGHTLY MATERIALS AT ALL TIMES. CONSTRUCTION MATERIALS ARC PROHIBITED IN THE TOWN RIGHT-OF-WAY OR NEAR ADJACENT PROPERTIES.
- . BUILDING CONSTRUCTION MUST NOT START SOONER THAN SUNRISE AND MUST STOP NO LATER THAN SUNSET. ALSO, ORDINANCE #561 IMPOSES RESTRICTIONS ON CONSTRUCTION WORK ON SATURDAYS, SUNDAYS AND MAJOR BUSINESS HOLIDAYS. HILLSIDE PROJECTS MAY HAVE ADDITIONAL RESTRICTIONS. EQUIPMENT WITH AUDIBLE REVERSE DIRECTION WARNINGS MUST NOT BE OPERATED PRIOR TO 7:00 A.M.
- 38. THE USE AND OPERATION OF FUEL—FIRED GENERATORS ON ANY CONSTRUCTION SITE, NEW, EXISTING OR
- REMODELING, IS PROHIBITED UNLESS DUE TO A HARDSHIP TOWN APPROVAL IS OBTAINED. THE CONTRACTOR AND PROPERTY OWNER WILL BE LIABLE FOR ANY DAMAGE DONE TO ANY PUBLIC PROPERTY AS A RESULT OF ANY CONSTRUCTION OR CONSTRUCTION RELATED ACTIVITIES. NO CERTIFICATE OF
- OCCUPANCY WILL BE ISSUED UNTIL ALL AFFECTED RIGHTS-OF-WAY ARE CLEANED AND/OR REPAIRED TO THEIR ORIGINAL CONDITION AND UNTIL ANY AND ALL DAMAGES TO AFFECTED PROPERTIES ARE RESTORED TO ORIGINAL CONDITION, OR UNTIL SUCH TIME THAT A WRITTEN, SIGNED AND LEGALLY BINDING AGREEMENT HAS BEEN REACHED BY THC PARTIES INVOLVED TO REMEDY ANY VIOLATION WITHIN A REASONABLE TIME PERIOD, AND UNTIL ALL REQUIRED FEES ARE PAID IN FULL
- 10. THE NATURAL FLOW OF RAINWATER AND OTHER SURFACE DRAINAGE FROM THE PROPERTY MAY NOT BE ALTERED IN ANY WAY.
- I. A KEY SWITCH SHALL BE REQUIRED ON ALL NEW AND EXISTING ELECTRIC ENTRY CONTROL GATES. THE KEY SWITCH SHALL BE INSTALLED IN A LOCATION ON THE GATE CONTROL PANEL THAT IS READILY VISIBLE AND ACCESSIBLE. KNOX BOX ORDER FORMS ARE AVAILABLE AT THE PARADISE VALLEY BUILDING DEPARTMENT.
- 12. ALL EQUIPMENT OF ALL TRADES ON OR AFFECTING THE JOB MUST BE CLEANED ONLY IN A PRE-DETERMINED AND DESIGNATED AREA. DEBRIS AND RUNOFF FROM SAID AREA MAY NOT EXTEND BEYOND THE BUILDING
- 43. PROPERTY OWNER. BUILDER. OR GENERAL CONTRACTOR WILL BE RESPONSIBLE FOR CONTROLLING DUST FROM THE SITE AT ALL TIMES. ALL MEANS NECESSARY SHALL BE USED BY THE BUILDER OR GENERAL CONTRACTOR TO CONTROL THE EXISTENCE OF DUST CAUSED BY ANY EARTHWORK, SPRAY APPLICATION OF MATERIALS, OR OTHER DUST-CAUSING PRACTICES REQUIRED BY THE CONSTRUCTION PROCESS.
- 14. AN INSPECTION FEE WILL BE CHARGED IF THE INSPECTION IS REQUIRED AS A RESULT OF A CODE VIOLATION. 45. FOR DEMOLITION INSPECTION OWNER OR PERMITTEE SHALL NOTIFY OSHA FOR ASBESTOS INSPECTION. ALL DEMOLITIONS AND ALL RENOVATION ACTIVITIES THAT WILL DISTURB FRIABLE ASBESTOS CONTAINING MATERIALS MUST BE REPORTED TO THE MARICOPA COUNTY ENVIRONMENTAL SERVICES DEPARTMENT.

PRELIMINARY GRADING & DRAINAGE PLAN SCHERR RESIDENCE

5416 E DESERT JEWEL DR., PARADISE VALLEY, AZ 85253


LOT 27 - VISTA RICA, A SUBDIVISION PLAT RECORDED IN BOOK 171 OF MAPS, PAGE 28, MCR., LOCATED IN A PORTION OF THE SE 1/4 OF THE SW 1/4 OF THE SE 1/4 OF SECTION 32, T.3N, R.4E OF THE GILA & SALT RIVER BASE AND MERIDIAN, MARICOPA COUNTY, ARIZONA

ENGINEERS NOTES


- MARICOPA ASSOCIATION OF GOVERNMENTS (M.A.G.) UNIFORM STANDARD SPECIFICATIONS AND DETAILS FOR PUBLIC WORKS CONSTRUCTION (LATEST EDITION INCLUDING LATEST REVISION AND CURRENT SUPPLEMENTS THEREOF PER THE LOCAL TOWN OR CITY) ARE INCORPORATED INTO THIS PLAN IN THEIR ENTIRETY.
- ALL WORK REQUIRED TO COMPLETE THE CONSTRUCTION COVERED BY THIS PLAN SHALL BE IN ACCORDANCE WITH THE M.A.G. STANDARD SPECIFICATIONS AND DETAILS AND CURRENT SUPPLEMENTS THEREOF PER THE LOCAL CITY OR TOWN UNLESS SPECIFIED OTHERWISE IN THESE PLANS OR ELSEWHERE IN THE CONTRACT DOCUMENTS. CONTRACTORS SHALL FAMILIARIZE THEMSELVES WITH ALL REQUIRED STANDARD SPECIFICATIONS, DETAILS AND SUPPLEMENTS PRIOR TO BIDDING THE WORK FOR THE CONSTRUCTION COVERED BY THIS PLAN.
- GRADING SHALL BE IN CONFORMANCE WITH 2012 IBC SEC. 1803 AND APPENDIX J. 5% MINIMUM SLOPE AWAY FROM BUILDING FOR A MINIMUM 10', U.N.O.
- ALL CONSTRUCTION SHALL CONFORM TO THE LATEST MARICOPA ASSOCIATION OF GOVERNMENTS (M.A.G.) SPECIFICATIONS AND STANDARD DETAILS.
- 6. A DUST CONTROL PLAN MEETING THE REQUIREMENTS OF RULE 310 OF THE MARICOPA COUNTY AIR POLLUTION CONTROL REGULATIONS, AS AMENDED, IS REQUIRED.
- A SEPARATE PERMIT IS NECESSARY FOR ANY OFFSITE CONSTRUCTION.
- 8. AN APPROVED GRADING AND DRAINAGE PLAN SHALL BE ON THE JOB SITE AT ALL TIMES. DEVIATIONS FROM THE PLAN MUST BE PRECEDED BY AN APPROVED PLAN REVISION.
- ALL DRAINAGE PROTECTIVE DEVICES SUCH AS SWALES, INTERCEPTOR DITCHES, PIPES, PROTECTIVE BERMS, BARRIER WALLS, CONCRETE CHANNELS OR OTHER MEASURES DESIGNED TO PROTECT ADJACENT BUILDINGS OR PROPERTY FROM STORM RUNOFF MUST BE COMPLETED PRIOR TO BUILDING CONSTRUCTION.
- 10. ALL STRUCTURES AND LANDSCAPING WITHIN THE SIGHT VISIBILITY TRIANGLE SHALL HAVE A 2 FOOT MAXIMUM
- 11. ALL PATIOS, WALKS, AND DRIVES TO SLOPE AWAY FROM BUILDING AND GARAGES AT A MINIMUM SLOPE OF 1/4" PER FOOT UNLESS SPECIFIED OTHERWISE. ALL LAWN AREAS ADJOINING WALKS OR SLABS WILL BE GRADED TO 2" BELOW THE TOP OF SLAB. TYPICAL FINISHED GRADE AROUND PERIMETER OF BUILDING IS MINUS 6" BELOW FINISHED FLOOR UNLESS SPECIFIED OTHERWISE.
- 12. ALL MATERIAL TO BE UNDER SLABS AND WALKS SHALL BE COMPACTED TO NOT LESS THAN 95% PER ASTM D698. 13. THE QUANTITIES AND SITE CONDITIONS DEPICTED IN THESE PLANS ARE FOR INFORMATIONAL PURPOSES ONLY AND ARE SUBJECT TO ERROR AND OMISSION. CONTRACTORS SHALL SATISFY THEMSELVES AS TO ACTUAL QUANTITIES AND SITE CONDITIONS PRIOR TO BIDDING THE WORK FOR THE CONSTRUCTION COVERED BY THIS PLAN.
- 14. THE CONTRACTOR IS RESPONSIBLE FOR OBTAINING AND COMPLYING WITH ALL PERMITS REQUIRED TO COMPLET
- 15. THE CONTRACTOR IS RESPONSIBLE FOR ALL METHODS, SEQUENCING, AND SAFETY CONCERNS ASSOCIATED WITH THIS PROJECT DURING CONSTRUCTION, UNLESS SPECIFICALLY ADDRESSED OTHERWISE IN THIS PLAN OR ELSEWHERE UTILITIES IN THE CONSTRUCTION AREA. THE CONTRACTOR IS RESPONSIBLE FOR ANY DAMAGE TO UTILITIES AND/OR
- ADVANCE FOR BLUE STAKE (1-800-STAKE-IT) PRIOR TO ANY EXCAVATION. 17. THE CONTRACTOR IS RESPONSIBLE FOR ALL COORDINATION OF CONSTRUCTION AFFECTING UTILITIES AND THE
- COORDINATION OF ANY NECESSARY UTILITY RELOCATION WORK. RECOMMENDATIONS SET FORTH IN THE SOILS (GEOTECHNICAL) REPORT FOR THIS PROJECT IN ADDITION TO THE
- 19. THE CONTRACTOR IS TO VERIFY THE LOCATION AND THE ELEVATIONS OF ALL EXISTING UTILITIES AT POINTS OF TIE-IN PRIOR TO COMMENCING ANY NEW CONSTRUCTION. SHOULD ANY LOCATION OR ELEVATION DIFFER FROM
- COORDINATION BETWEEN ALL PARTIES IS ESSENTIAL PART OF CONTRACT. 22. CONTRACTOR IS RESPONSIBLE FOR PROJECT AND SITE CONDITIONS. AND TO WORK WITH WEATHER CONDITIONS AS
- AND GUTTER, OR OTHER SURFACE CONSTRUCTION. SHOULD EXISTING LOCATIONS, ELEVATIONS, CONDITION, OR PAVEMENT CROSS-SLOPE DIFFER FROM THAT SHOWN ON THESE PLANS, RESULTING IN THE DESIGN INTENT REFLECTED ON THESE PLANS NOT ABLE TO BE CONSTRUCTED. THE CONTRACTOR SHALL NOTIFY THE OWNER'S AGENT IMMEDIATELY FOR DIRECTION ON HOW TO PROCEED PRIOR TO COMMENCEMENT OF CONSTRUCTION. THE CONTRACTOR ACCEPTS RESPONSIBILITY FOR ALL COSTS ASSOCIATED WITH CORRECTIVE ACTION IF THESE
- PLACE BEFORE STARTING CULVERT WORK. 25. ALL ON-SITE UTILITIES PER OTHERS.

- 31. MECHANICAL EQUIPMENT SHALL BE SCREENED TO A MINIMUM OF ONE FOOT ABOVE TOP OF EQUIPMENT.
- 32. ANY FUTURE IMPROVEMENTS SHOWN HEREON SHALL REQUIRE A SEPARATE PERMIT. 33. ANY POINTS OF DRAINAGE CONCENTRATION SHOULD BE PROTECTED AGAINST EROSION WITH NATIVE STONE.
- SITE PLAN TO DETERMINE FINAL HOUSE, WALL, STEP, ETC., LOCATIONS AND ELEVATIONS. 35. ALL DRAINAGE FACILITIES TO BE MAINTAINED BY HOMEOWNER. 36. SEE ARCHITECTURAL AND STRUCTURAL PLANS FOR SITE AND RETAINING WALLS LAYOUT, DIMENSIONS, AND
- GRADE OR FINISHED GRADE WHICHEVER IS LOWER (TYPICAL). 37. REFER TO ARCHITECTURAL DRAWINGS FOR BUILDING LAYOUT, DIMENSIONS AND ELEVATIONS. 38. REFER TO STRUCTURAL DRAWINGS, DETAILS AND CALCULATIONS FOR ALL PROPOSED RETAINING WALLS.
- 39. FOR CHANGE IN ELEVATION THAT ARE GREATER THAN 30", PROVIDE 36" HIGH GUARDRAILS FOR TOTAL OF 42" FALL PROTECTION BARRIER U.N.O.
- 41. ALL WATER AND SEWER LINES AND CONNECTIONS MUST BE INSTALLED PER IPC 2012, MAG AND TOWN OF
- PARADISE VALLEY SUPPLEMENT TO MAG. 42. WATERPROOF ALL EXTERIOR WALLS 18" ABOVE FINISH GRADE—(BITUTHENE® 3000 HC MEMBRANE W/ GRACE
- PROTECTION 03 OR APPROVED EQUAL) 43. ALL PIPES AND FITTINGS SHALL BE INSTALLED PER MANUFACTURE'S SPECIFICATIONS AND DETAILS.
- SEPARATE PERMIT. 45. COORDINATE RIPRAP COLOR WITH LANDSCAPE PLANS AND DETAILS.
- 47. VERIFY AND COORDINATE WITH ARCHITECTURAL AND LANDSCAPE PLANS LOCATION AND HEIGHT OF ALL SITE
- 48. DISTURBED AREA: TOTAL ACRES = 1.65 ACRES < 1 ACRE; NPDES PERMIT IS NOT REQUIRED. 49. REFER TO ARCHITECTURAL PLANS AND DETAILS FOR DEMOLITION AND REMOVAL OF ANY EXISTING BUILDING STRUCTURES, SITE WALLS, POOL AND PAVEMENT ETC.
- 50. REFER TO GEOTECHNICAL REPORT FOR SPECIFIC RECOMMENDATIONS AND MAXIMUM ALLOWED FILL AND CUT

LEGEND

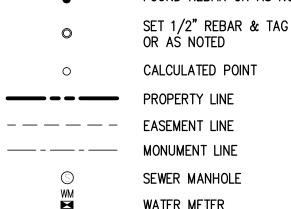

- WATER METER WATER VALVE FIRE HYDRANT
- CABLE TV RISER CATV, PHONE
- WATER LINE ELECTRIC LINE
- GAS LINE -0-0-0-
- FACILITIES CAUSED DURING THEIR CONSTRUCTION OPERATIONS. THE CONTRACTOR SHALL CALL 48 HOURS IN
- 18. ALL PAVING, GRADING, EXCAVATION, TRENCHING, PIPE BEDDING, CUT, FILL AND BACKFILL SHALL COMPLY WITH THE REFERENCED REQUIRED SPECIFICATIONS AND DETAILS.
- THAT SHOWN ON THESE PLANS, THE CONTRACTOR SHALL CONTACT THE OWNER'S AGENT.
- 20. CONTRACTOR TO VERIFY AND COORDINATE ALL DIMENSIONS AND SITE LAYOUT WITH ARCHITECTURE'S FINAL SITE PLAN AND FINAL BUILDING DIMENSIONS BEFORE STARTING WORK. REPORT DISCREPANCIES TO OWNER'S AGENT.
- THE PROJECT SITE MAY BE LOCATED IN A FLOOD PRONE AREA AND SUBJECT TO FLOODING AND ITS HAZARDS. 23. THE CONTRACTOR IS TO VERIFY THE LOCATION, ELEVATION, CONDITION, AND PAVEMENT CROSS-SLOPE OF ALL EXISTING SURFACES AT POINTS OF TIE-IN AND MATCHING, PRIOR TO COMMENCEMENT OF GRADING, PAVING, CURB
- 24. CONTRACTOR IS RESPONSIBLE TO COORDINATE UTILITY CROSSINGS AT CULVERT CROSSINGS BEFORE STARTING WORK ON CULVERT. COORDINATE WITH OWNER REPRESENTATIVE. VERIFY UTILITY LINES AND/OR CONDUITS ARE IN
- 26. THIS PROJECT REQUIRES A REGULAR ONGOING MAINTENANCE PROGRAM FOR THE DESIGNED DRAINAGE SYSTEM(S) TO PRESERVE THE DESIGN INTEGRITY AND THE ABILITY TO PERFORM ITS OPERATIONAL INTENT. FAILURE TO PROVIDE MAINTENANCE WILL JEOPARDIZE THE DRAINAGE SYSTEM(S)' PERFORMANCE AND MAY LEAD TO IT'S
- INABILITY TO PERFORM PROPERLY AND/OR CAUSE DAMAGE ELSEWHERE IN THE PROJECT 27. IF A DISCREPANCY IS FOUND BETWEEN ENGINEER'S PLAN OR SURVEYOR'S STAKING AND THE ARCHITECTURAL PLAN. ENGINEER SHALL BE NOTIFIED IMMEDIATELY. FAILURE TO NOTIFY ENGINEER SHALL NEGATE ENGINEER'S
- 28. ALL DISTURBED AREAS ARE TO BE ROPED AND ROPING MUST MATCH PLAN.
- 29. VEGETATION OUTSIDE OF CONSTRUCTION AREA TO REMAIN.
- 30. AREAS OUTSIDE THE WALL AND CUT AND FILL SLOPES SHALL BE REVEGETATED WITH SIMILAR PLANT TYPES AND DENSITIES FOUND ON THE SITE. REVEGETATION SHALL BE COMPLETED PRIOR TO OCCUPANCY AND THE ISSUANCE OF A CERTIFICATE OF OCCUPANCY.
- 34. THIS PLAN IS DESIGNED TO SHOW SITE GRADING AND DRAINAGE CONTRACTOR SHALL USE THE ARCHITECTURAL
- DETAILS. TOP OF FOOTING ELEVATIONS SHOWN IN PLAN ARE APPROXIMATE ONLY. ACTUAL TOP OF FOOTINGS TO BE DETERMINED AT TIME OF CONSTRUCTION AND TO BE A MINIMUM OF SIX INCHES BELOW EXISTING NATURAL
- 40. CONTRACTOR TO PROVIDE POSITIVE DRAINAGE AWAY FROM STRUCTURE 5% MIN SLOPE FOR FIRST 10 FEET,
- 44. ABANDONMENT OF EXISTING AND INSTALLATION OF NEW SEPTIC SYSTEMS SHALL BE PERFORMED IN ACCORDANCE WITH THE MARICOPA COUNTY ENVIRONMENTAL SERVICES DEPARTMENT RULES AND STANDARDS, AND WILL REQUIRE
- 46. VERIFY AND COORDINATE WITH LANDSCAPE PLANS FINAL LOCATION AND GRATE TYPE OF SPECIFIED AREA DRAINS

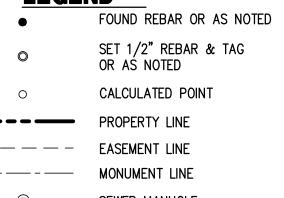

AREA OF LOT:

TOTAL FLOOR AREAS

FLOOR AREA RATIO:

BUILDING PAD SLOPE:

ALLOWED SLOPES STEEPER

PROPOSED SLOPES STEEPER

VOLUME OF CUT:

VOLUME OF FILL:

TOTAL CUT&FILL:

YARD OF CUT+FILL:

THAN NATURAL GRADE (AREA):

HILLSIDE ASSURANCE @ \$25/CUBIC

(TOTAL FLOOR AREA/AREA OF LOT)

ALLOWABLE NET DISTURBED AREA: 8.116 S.F. (18.59%)

LESS 25% OF PROP. PAVERS D/W: (4,233 S.F.) 1,058 S.F.

THAN NATURAL GRADE (5% MAX.): 2,183 S.F. (5%)

PROPOSED NET DISTURBED AREA: 8,089 S.F. < 8,116 S.F.


GROSS EXISTING DISTURBED AREA: 0 S.F.

LESS TEMPORARY AREAS OF DISTURBANCE


GROSS PROPOSED DISTURBED AREA: 17,594 S.F.


TO BE RESTORED AND REVEGETATED: 2,372 S.F.

LESS BUILDING FOOTPRINT AREA: 6,075 S.F.

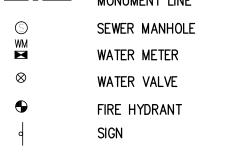


- TELEPHONE PEDESTAL SEWER LINE
- COMMUNICATIONS LINE
- ---1321___.
 - EXISTING CONTOUR EXIST. DRAINAGE FLOW
 - EXIST. SPOT ELEVATION CACTUS
 - PALO VERDE TREE

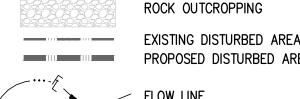

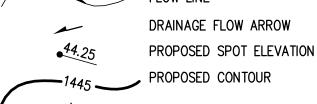

TR/TW: 28.33 /FG: 24.83 TOP OF RAILING/NON-RET. WALL TF: 21.00 TOP OF RETAINING WALL (BW: 22.00) FINISH GRADE

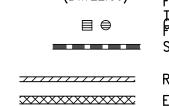

STORM DRAIN PIPE RETAINING WALL/AGAINST BUILDING EXTENDED BUILDING STEM WALL

REVEGETATED AREA

A DDDEVIA TIONS

<u>ARR</u>	<u>REVIATIONS</u>
ВС	BACK OF CURB
BSL	BUILDING SETBACK LINE
BW	BOTTOM OF WALL
С	CONCRETE, CALCULATED
TPV	TOWN OF PARADISE VALLEY
DE	DRAINAGE EASEMENT
ESMT	EASEMENT
EXIST.	EXISTING
EG	EXISTING GRADE
FG	FINISH GRADE
FFE	FINISH FLOOR ELEVATION
F_	FLOW LINE
FND	FOLIND

GUTTER, GAS INVERT INV MARICOPA ASSOCIATION OF GOVERNMENTS MEASURED MARICOPA COUNTY RECORDER PAVEMENT

PUBLIC UTILITY EASEMENT

RECORDED RADIUS RIGHT OF WAY TANGENT, TELEPHONE WEST, WATERLINE TOP OF PARAPET TOP OF CURB TOP OF GRATE TOP OF FOOTING

TOP OF RAILING

TOP OF RETAINING WALL

TOP OF WALL WATER METER

DISTURBED AREA CALCULATIONS EARTHWORK QUANT.

CUT: 2.360 C.Y. FILL: 999 C.Y.
NET CUT: 1,360 C.Y.

ARE ESTIMATES ONLY. NO SHRINK OR SWELL IS ASSUMED. THE CONTRACTOR ON THEIR ESTIMATES.

ID NUMBER	MAX. HEIGHT	LENGTH
	FT	FT
1	4.5	93.00
2	8.0	77.00
3	8.0	28.00
4	8.0	59.00
5	8.0	59.00
6	4.0	34.00
7	8.0	65.00
TOTAL		415.00

KEYNOTE

MAXIMUM LENGTH OF RETAINING WALLS CONTAINING 43,655 S.F (1.002 AC.); MORE OR LESS. VISIBLE FROM ANY POINT ON THE PROPERT LINE = 258' < 300'. BASIS OF BEARINGS ALL WALL LENGTHS LISTED ABOVE ARE FOR PERMITTING PURPOSES ONLY. CONTRACTOR IS RESPONSIBLE FOR VERIFYING ACCURACY OF MONUMENTATION SHOWN ON THE SURVEY, THE BEARING OF WHICH IS WALL QUANTITIES AS SHOWN. REFER TO N89°49'14"E, PER PLAT OF VISTA RICA, BOOK 171, PAGE 28, MCR. ARCHITECTURAL AND STRUCTURAL PLANS AND DETAILS FOR WALL CONSTRUCTION,

HEIGHT AND FINISH.

GRADING SPECIFICATIONS

ALL QUANTITIES LISTED ON THESE PLANS ARE ESTIMATES ONLY.

QUANTITIES AND BASE THEIR BIDS ON THEIR ESTIMATES.

THE CONTRACTOR SHALL MAKE THEIR OWN DETERMINATION OF THE

1. EXCAVATION AND GRADING OF THIS SITE IS CLASSIFIED AS "ENGINEERED GRADING" PER 2015 I.B.C. AND WILL BE 2. THE CONTRACTOR WILL RETAIN A SOILS ENGINEER DURING CONSTRUCTION TO INSPECT PROGRESS OF

CONSTRUCTION. CONCERNING PREPARATION OF GROUND TO RECEIVE FILLS. TESTING AND REQUIRED COMPACTION STABILITY OF ALL FINISH SLOPES INCLUDING CUT SLOPES. 3. COMPACTION SHALL COMPLY WITH M.A.G. SECTION 601 AND PROVISIONS AS SET FORTH IN THE SOILS REPORT 4. BEARING MATERIALS FOR FILL UNDER RESIDENCE PAD IF NATIVE MATERIAL IS USED. LARGE ROCK FRAGMENTS

43,655 S.F (1.002 AC.)

6,409 S.F.

20.7%

14.68% < 25%

2,183 S.F. (5%)

2,360 C.Y.

999 C.Y.

3.359 C.Y.

MUST BE REMOVED THAT ARE IN EXCESS OF SIX INCHES. REMAINING MATERIAL MUST BE SMALLER PARTICLES OF SAND AND ROCK THAT CAN BE COMPACTED INTO A DENSE CONDITION. MAXIMUM PARTICLE SIZE 6 INCHES PERCENT PASSING NO. 200 SIEVE 25% MAX.

SAFETY AND ALL ONSITE AND OFFSITE IMPROVEMENTS.

PROTECT THE UNDISTURBED NATURAL AREAS.

TOTAL

5. CUT-SLOPES: MAXIMUM ROCK CUT SLOPE TO BE 1.0 FEET HORIZONTAL TO 3.0 FEET VERTICAL PER GEOTECHNICAL

6. FILL SLOPES: MAXIMUM FILL SLOPE TO BE 2.0 FEET HORIZONTAL TO 1.0 FEET VERTICAL 7. COMPACTION FILL MATERIAL MUST BE PLACED ON LEVELED BENCHES CUT INTO UNDISTURBED EXISTING HILLSIDE. PLACE FILL IN HORIZONTAL LIFTS OF THICKNESS COMPATIBLE WITH THE COMPACTION EQUIPMENT USED. COMPACT TO A MINIMUM OF 95 PERCENT OF THE MAXIMUM A.S.T.M. DENSITY AT THE OPTIMUM MOISTURE CONTENT OF \pm TWO PERCENT. THIS PERTAINS TO ALL ENGINEERED STRUCTURAL FILL SUPPORTING STRUCTURES AND INCLUDING FILL UNDER ANY OF THE RETAINING WALLS. COMPACTION TEST RESULTS SHALL BE SUBMITTED TO THE SOILS ENGINEER AND TOWN FLOOD INSURANCE RATE MAP (FIRM) DATA OF PARADISE VALLEY BUILDING AND SAFETY DEPARTMENT.

TOP OF FOOTING OF PARADISE VALLEY BUILDING AND SAFETY DEPARTMENT.

8. ANY RETAINING WALLS ADJACENT TO THE PROPERTY LINES WILL BE UNDER THE SCOPE OF SPECIAL INSPECTION BY THE SOILS ENGINEER. THE DEVELOPER SHALL NOTIFY THE ADJOINING PROPERTY OWNERS IN WRITING, TEN DAYS PRIOR TO START OF CONSTRUCTION ON THESE WALLS PER SECTION 2903-B OF IBC. THE DEVELOPER WILL HAVE TO PROVIDE MEANS OF PROTECTION OF ADJACENT PROPERTY WHILE THIS WORK IS UNDER CONSTRUCTION.

> 9. ALL EXPOSED CUT AND FILL SHALL BE TREATED WITH AN APPROVED AGING AGENT TO MINIMIZE TO VISUAL 10. NO CERTIFICATE OF OCCUPANCY SHALL BE ISSUED UNTIL ALL HILLSIDE STIPULATIONS AND ALL TOWN CODE REQUIREMENTS ARE COMPLIED INCLUDING, BUT NOT LIMITED TO LANDSCAPING, GROUND RESTORATION, FIRE FLOW, FIRE

> 11. ALL OUTDOOR LIGHTING SHALL BE IN CONFORMANCE WITH ARTICLE XXII OF THE TOWN ZONING ORDINANCE. 12. ALL EXCESS FILL MATERIAL SHALL BE REMOVED FROM THE SITE WITH NO NEW SPILL SLOPES. 13. THE USE OF HYDRAULIC RAM HAMMERS, OR OTHER HEAVY EQUIPMENT USED TO CUT THROUGH ROCK, INCLUDING MACHINERY WITH AUDIBLE BACK UP WARNING DEVICES SHALL BE LIMITED TO USE BETWEEN THE HOURS OF 7:00AM OR SUNRISE, WHICHEVER IS LATER, AND 6:00PM OR SUNSET, WHICHEVER IS EARLIER, MONDAY THROUGH FRIDAY, WITH LIMITED WORK ON SATURDAY AND NO WORK ON SUNDAY OR LEGAL HOLIDAYS.

14. CONSTRUCTION STAKING AND/OF FENCING SHALL BE PLACED AROUND THE CONSTRUCTION SITE SO AS TO

ON-SITE RETENTION FOR THE PRE VS. POST DEVELOPMENT RUNOFF FROM 100-YEAR, 2-HOUR STORM EVENT V = DxAx(Cw - 0.75)/12- RAINFALL DEPTH=2.82" | A - TRIBUTARY AREA, SF | Cw - WEIGHTED RUNOFF COEFFICIENT RUNOFF VOLUME **DRAINAGE** COEFFICIENT REQUIRED PROVIDED RETENTION TYPE AREA S.F. C.F. С 43,655 410 (2) - 20' DEEP (48" DIA) DRYWELLS 0.79

410

WEIGHTED RUNOFF COEFFICIENT, Cw AREA A					
SURFACE TYPE	RUNOFF COEFFICIENT	AREA	C*AREA		
	С	SF			
ROOF	0.95	6,665	6,332		
PAVEMENT	0.95	1,464	1,391		
PERMEABLE PAVEMENT	0.75	3,588	2,691		
LANDSCAPE	0.75	31,938	23,954		
TOTAL 43,655 34,36					
Cw = C	0.79				

ALL QUANTITIES LISTED ON THESE PLANS SHALL MAKE THEIR OWN DETERMINATION OF THE QUANTITIES AND BASE THEIR BIDS

RETAINING WALL LINITS

IP I VIII	IIA MVF	P OIII
ID NUMBER	MAX. HEIGHT	LENGTH
	FT	FT
1	4.5	93.00
2	8.0	77.00
3	8.0	28.00
4	8.0	59.00
5	8.0	59.00
6	4.0	34.00
7	8.0	65.00
TOTAL		415.00

FOR LOCATIONS IDENTIFIED WITH # THE OFFICE OF THE COUNTY RECORDER OF MARICOPA COUNTY, ARIZONA, RECORDED IN BOOK 171 OF MAPS, PAGE 28.

BENCHMARK

BRASS CAP FLUSH AT THE INTERSECTION OF MOCKINGBIRD LANE AND 56TH STREET HAVING AN ELEVATION OF 1349.97 TOWN OF PARADISE VALLEY (NAVD 88) DATUM, GDACS# 26101-1

E DOUBLE TREE RANCH RD

E BUTLER DR

ARCHITECT

KENDLE DESIGN COLLABORATIVE

6115 N CATTLETRACK ROAD

SCOTTSDALE, AZ 85250

P: 480 951 8558

T3N, R4E

HORSESHOE RD

MOCKINGBIRD LN

E DESERT JEWEL [

VICINITY MAP

OWNER

JASON SCHERR

6843 LOST GARDEN TER

PARKLAND, FL 33076

SITE DATA

168-75-029

LOT AREA: 43,655 S.F (1.002 AC.)

LEGAL DESCRIPTION

ADDRESS: 5416 E DESERT JEWEL DR

PARADISE VALLEY, AZ 85253

LOT 27, OF VISTA RICA, ACCORDING TO THE PLAT OF RECORD IN

THE SOUTH LINE OF LOTS 26,27 AND 28 BASED ON THE FOUND

SANITARY SEWER: TOWN OF PARADISE VALLEY ELECTRIC: ARIZONA PUBLIC SERVICE TELEPHONE: CENTURY LINK, COX COMMUNICATIONS NATURAL GAS: SOUTHWEST GAS CABLE TV: CENTURY LINK, COX COMMUNICATIONS

SHEET INDEX

SHEET C-1 - COVER SHEET SHEET C-2 - GRADING & DRAINAGE PLAN

<u>FLOOD IN</u>	SUKANCE K	AIE M	<u>ap (fikm.</u>	<u>) </u>
COMMUNITY # 040049	PANEL # 1765 OF 4425	SUFFIX L	BASED FLOOD	
MAP #	PANEL DATE 10/16/2013	ZONE X*	ELEVATION N/A	

10/10/2013 *AREAS DETERMINED TO BE OUTSIDE THE 0.2% ANNUAL CHANCE FLOODPLAIN

DRAINAGE STATEMENT

1. ULTIMATE STORM OUTFALL IS LOCATED AT THE NORTHWEST PROPERTY CORNER AT ELEVATION OF 1413.70.

2. A NEW SINGLE FAMILY RESIDENCE AND POOL IS PROPOSED FOR THIS SITE.

REDUCE THE STORMWATER RUNOFF TO PRE-DEVELOPMENT CONDITIONS.

DURING A 100-YEAR PEAK RUN-OFF EVENT IF CONSTRUCTED PER

6. THE MINIMUM FINISH FLOOR ELEVATIONS SHOWN ARE SAFE FROM INUNDATION

3. PROPOSED DEVELOPMENT DOES NOT IMPACT DRAINAGE CONDITIONS OF ADJOINING LOTS. 4. HISTORIC DRAINAGE PATTERNS ARE PRESERVED. 5. PERMEABLE PAVERS ARE PROVIDED FOR THE PROPOSED DRIVEWAY TO

APPROVED PLANS.

1003.2.1 AMD.

UTILITIES NOTES HORIZONTAL AND VERTICAL LOCATIONS OF ALL EXISTING UTILITIES SHOWN ON THE PLAN ARE APPROXIMATE ONLY AND WILL BE FIELD VERIFIED BY CONTRACTOR PRIOR TO START OF CONSTRUCTION WORK. CALL BLUE STAKE @ (602) 263-1100.

FIRE SPRINKLER SYSTEM

FIRE SPRINKLER SYSTEM TO BE INSTALLED PER THE REQUIREMENTS OF THE TOWN OF PARADISE VALLEY AND IN ACCORDANCE WITH I.B.C. SECT. 904.2.2 AMD. AND I.F.C. SECT.


APPROVAL


TOWN ENGINEER TOWN OF PARADISE VALLEY


DATE CALL TWO WORKING DAYS BEFORE YOU DIG (602) 263 1100 BLUE STAKE CENTER

RELIMINARY & DRAINAGE OVER SHEET

CHERR RE E DESER' DISE VALLE

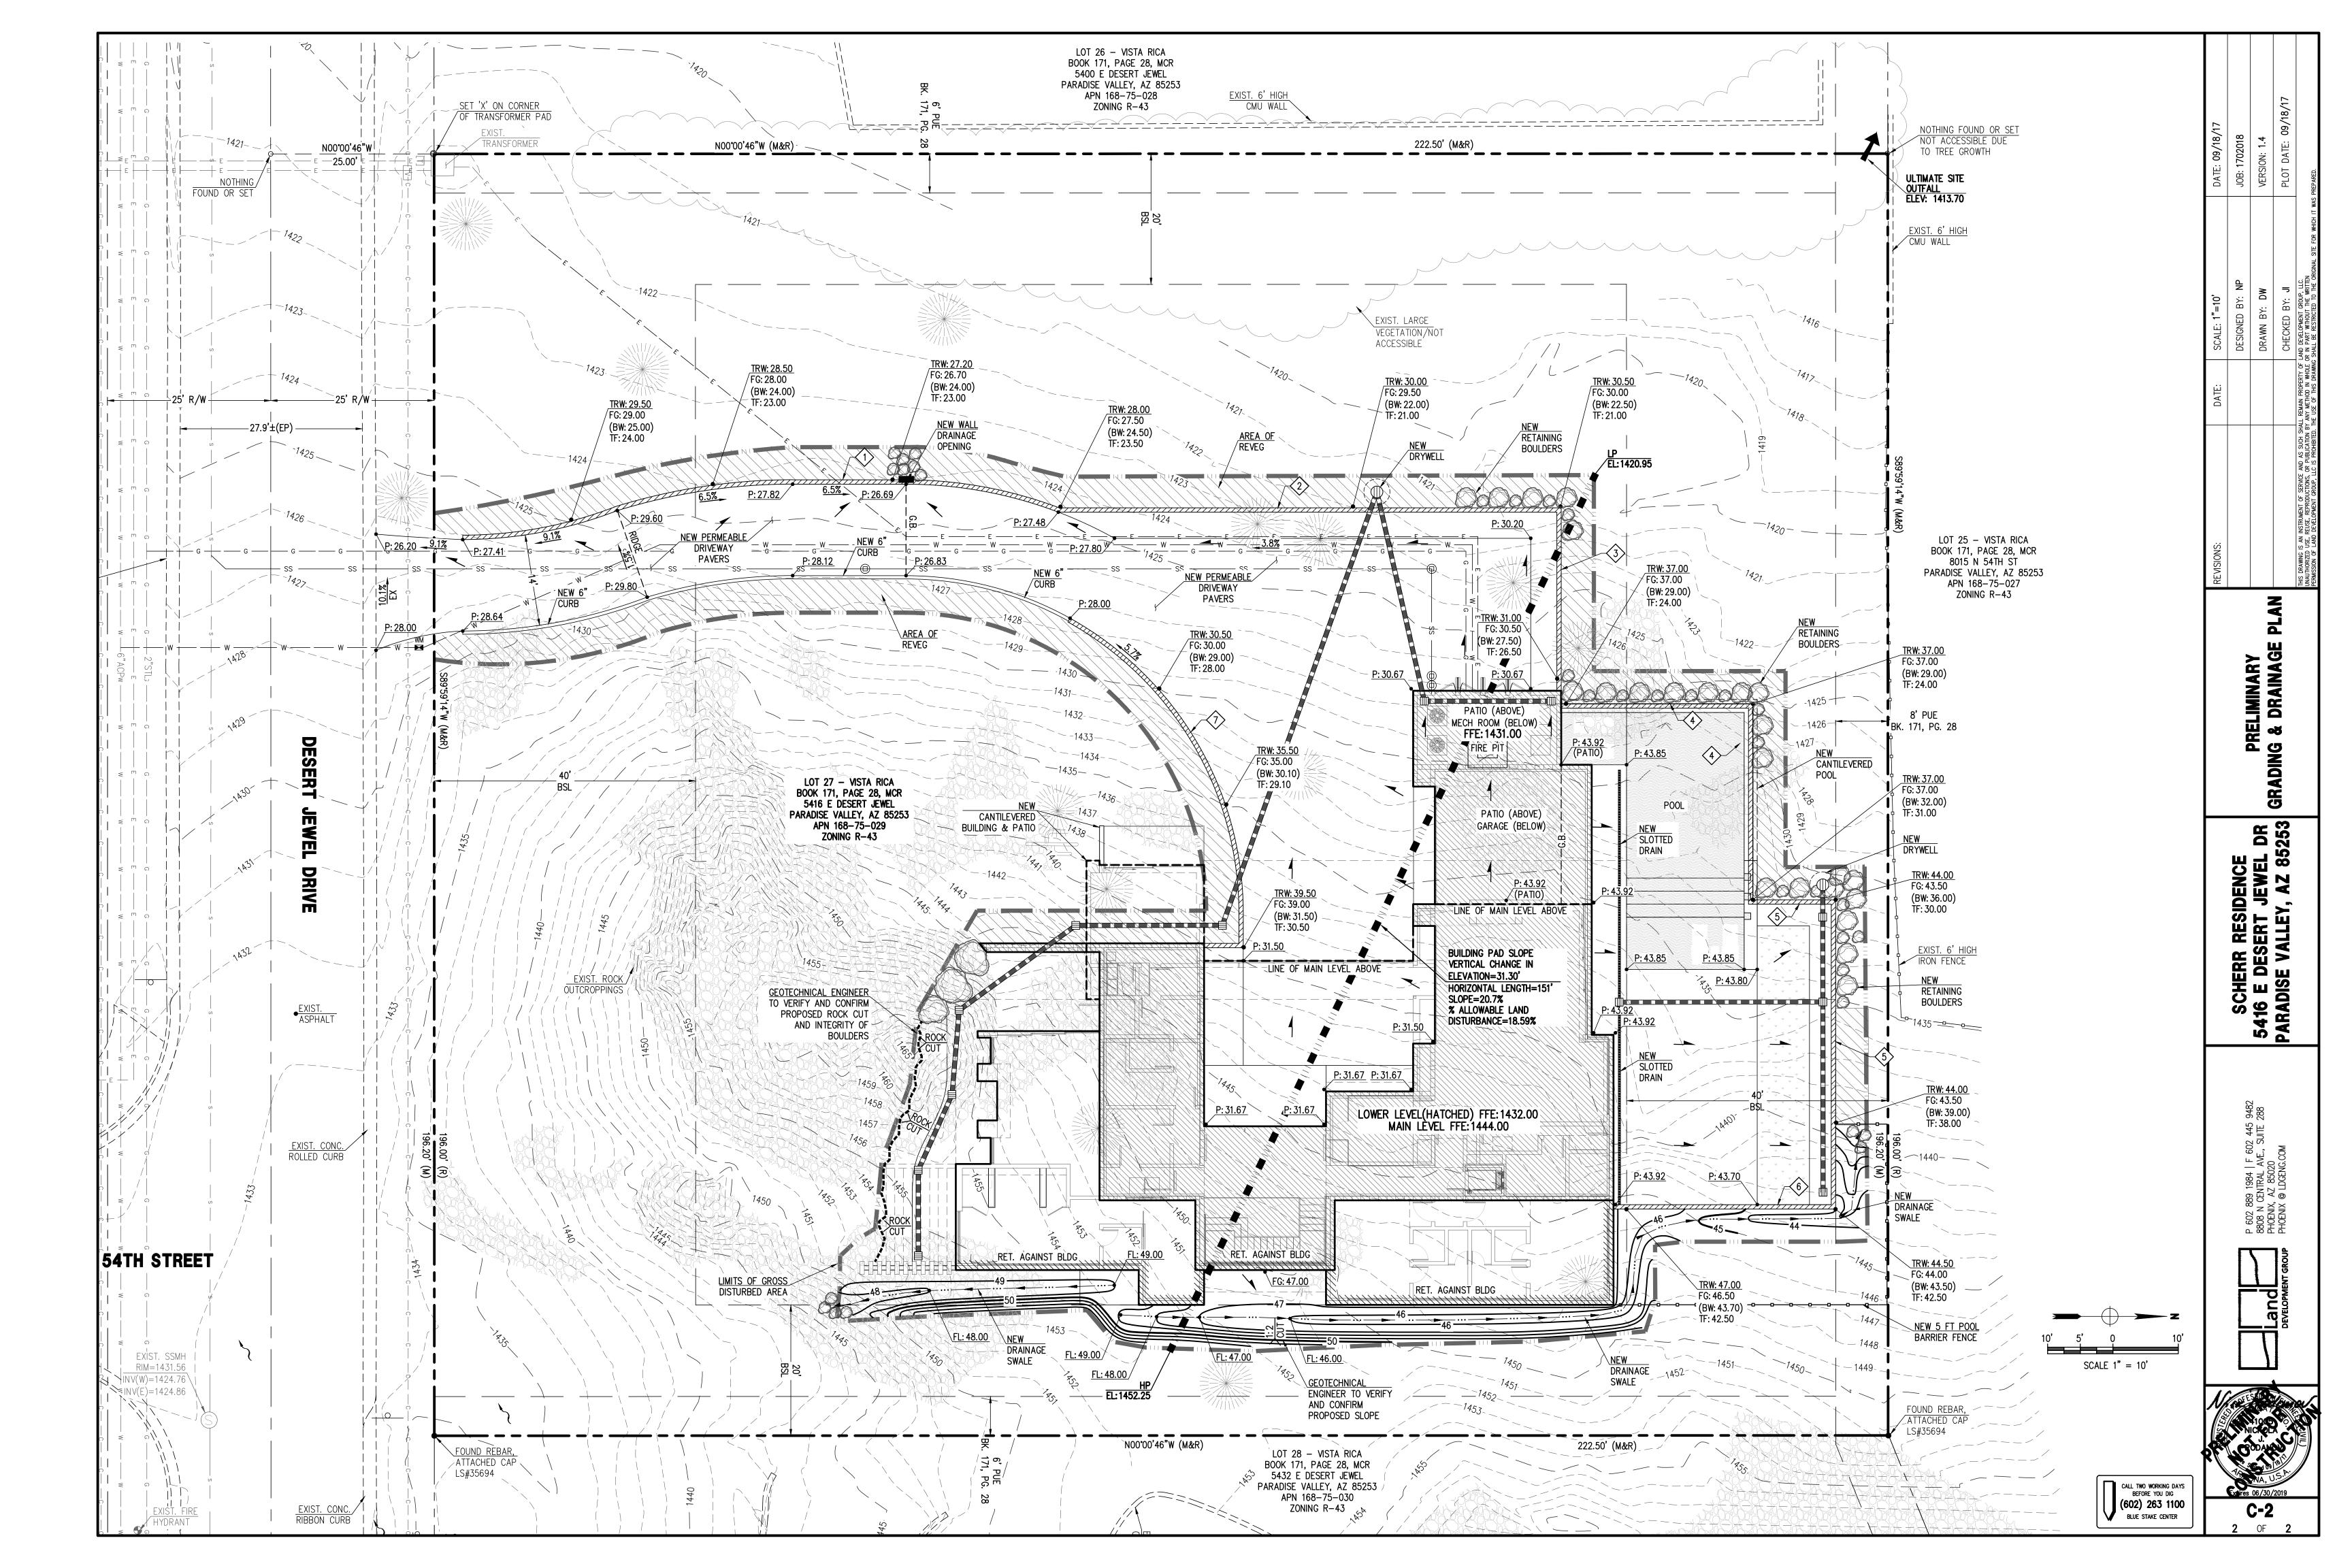

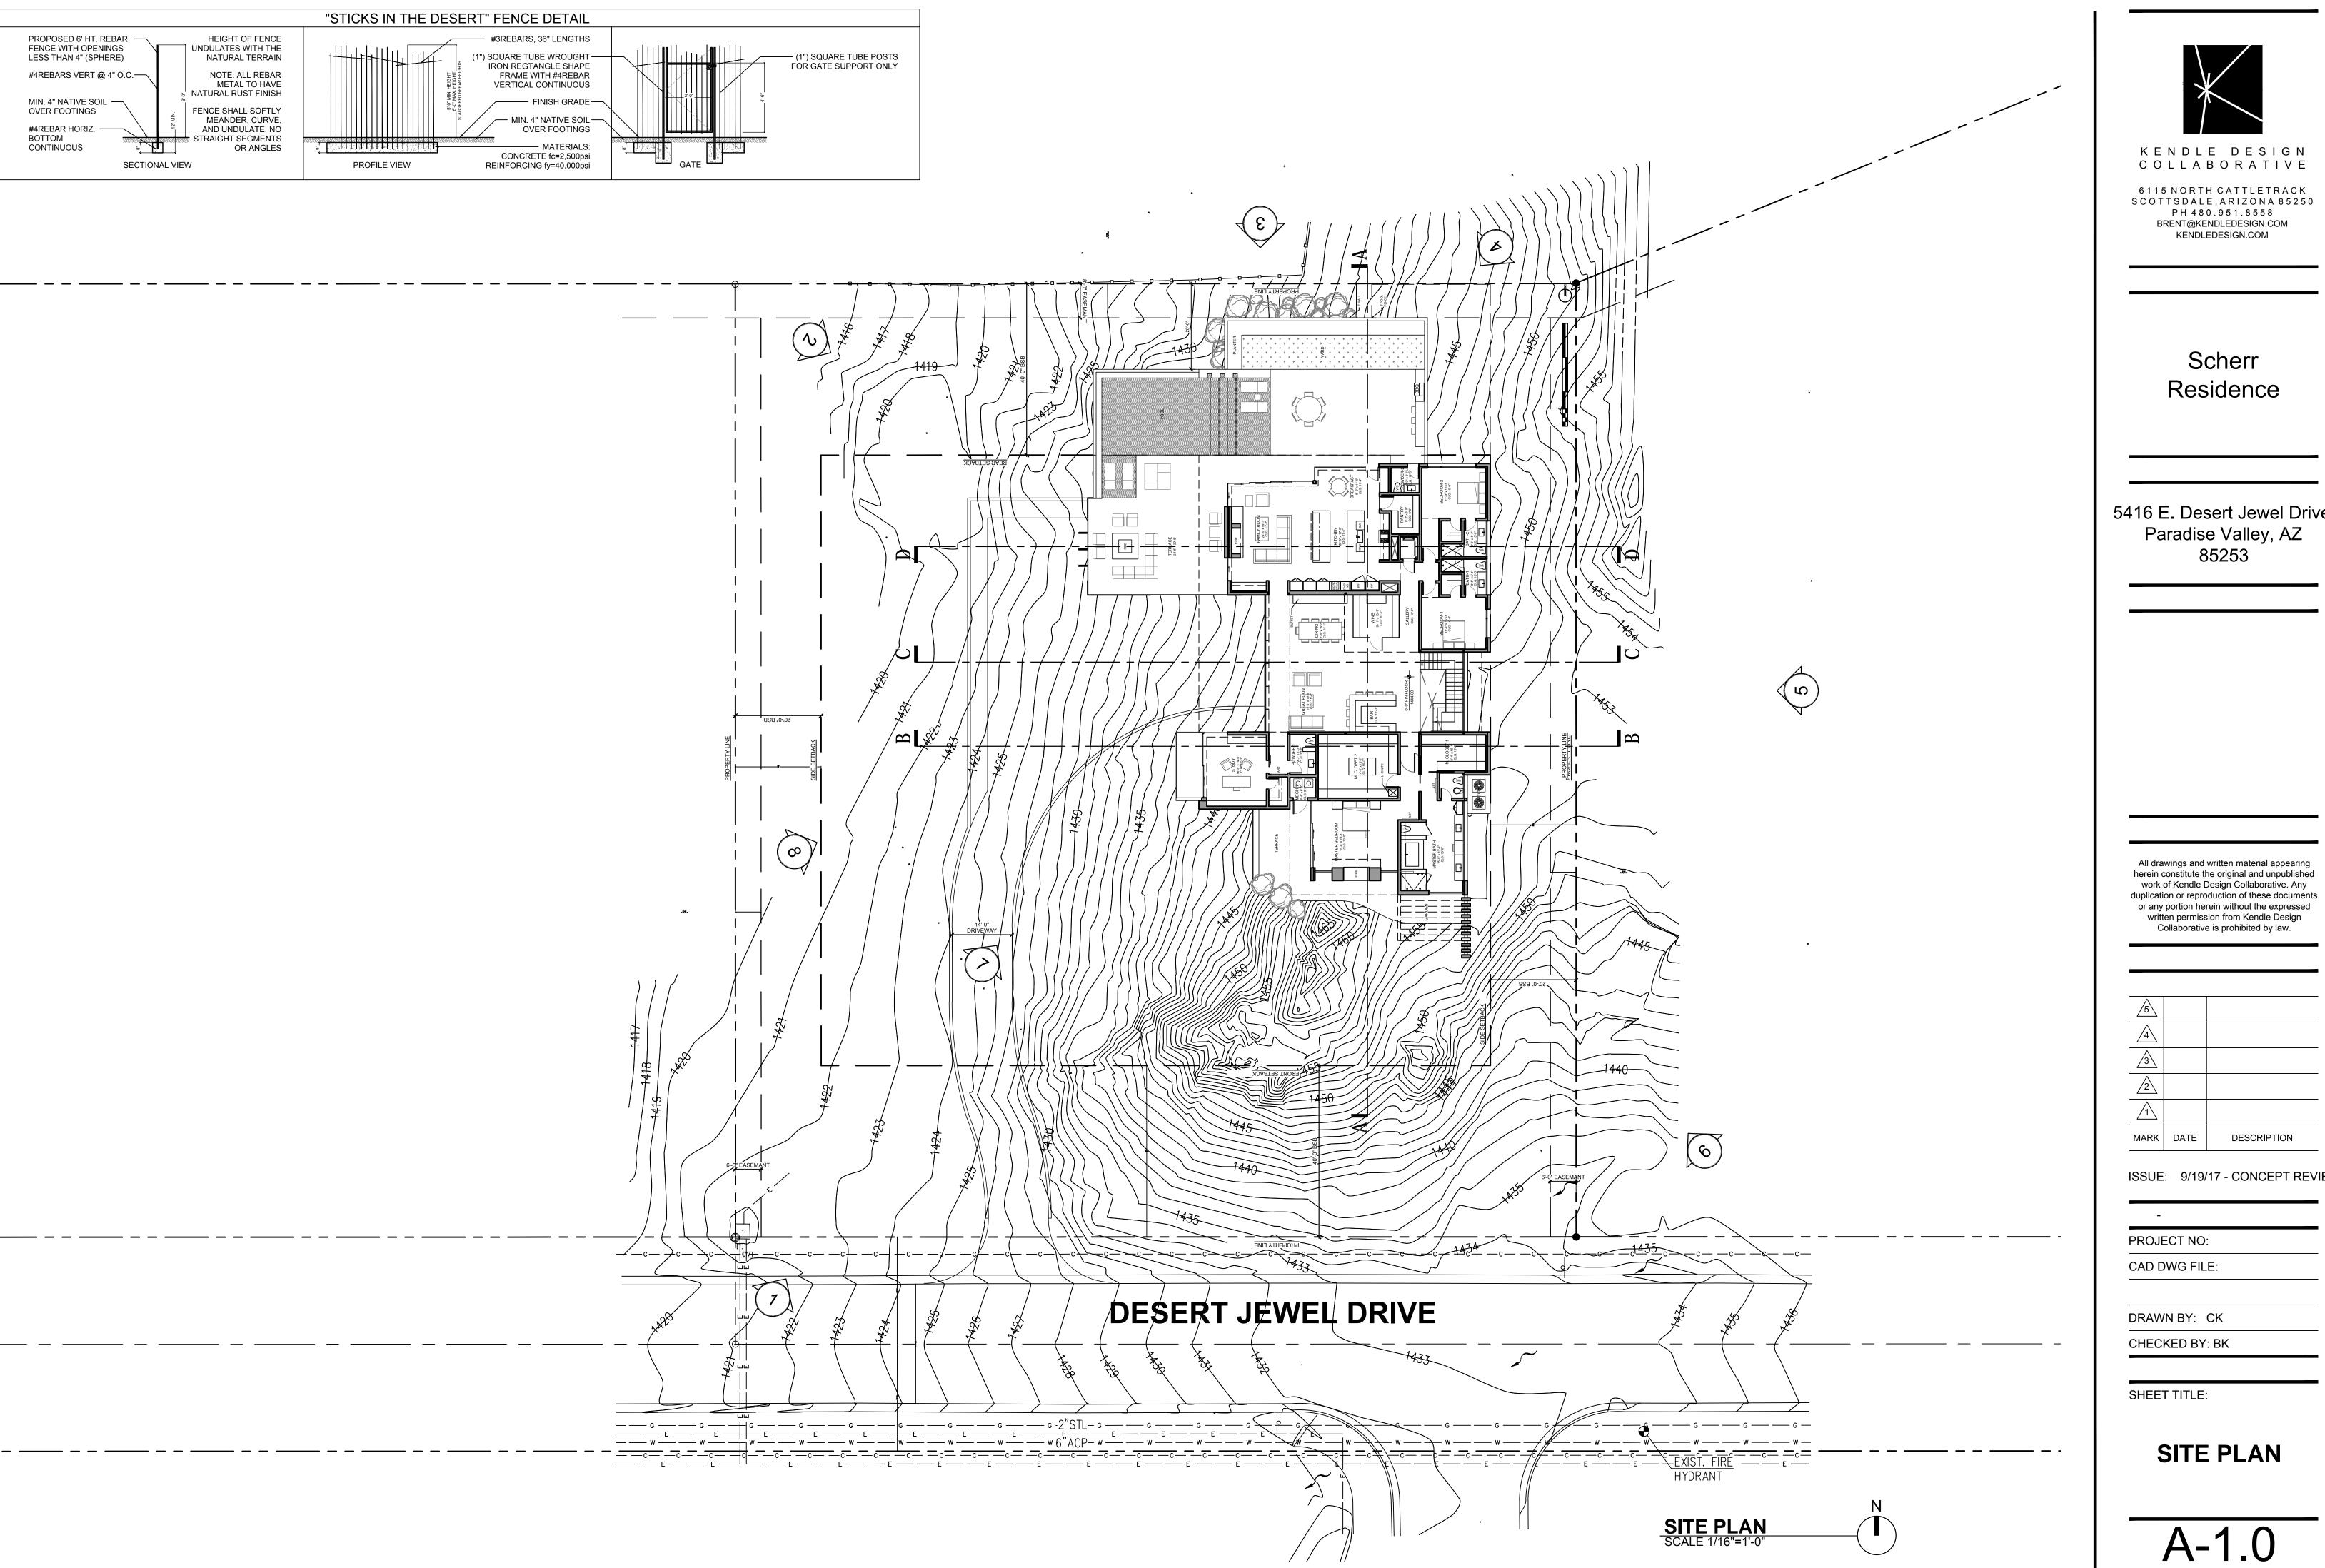

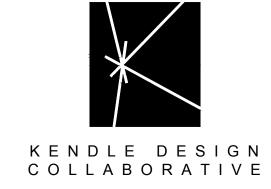

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Scherr Residence

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MARK	DATE	DESCRIPTION

ISSUE: 9/19/17 - CONCEPT REVIEW


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CAD DWG FILE:

DRAWN BY: CK CHECKED BY: BK

SHEET TITLE:

SITE PLAN



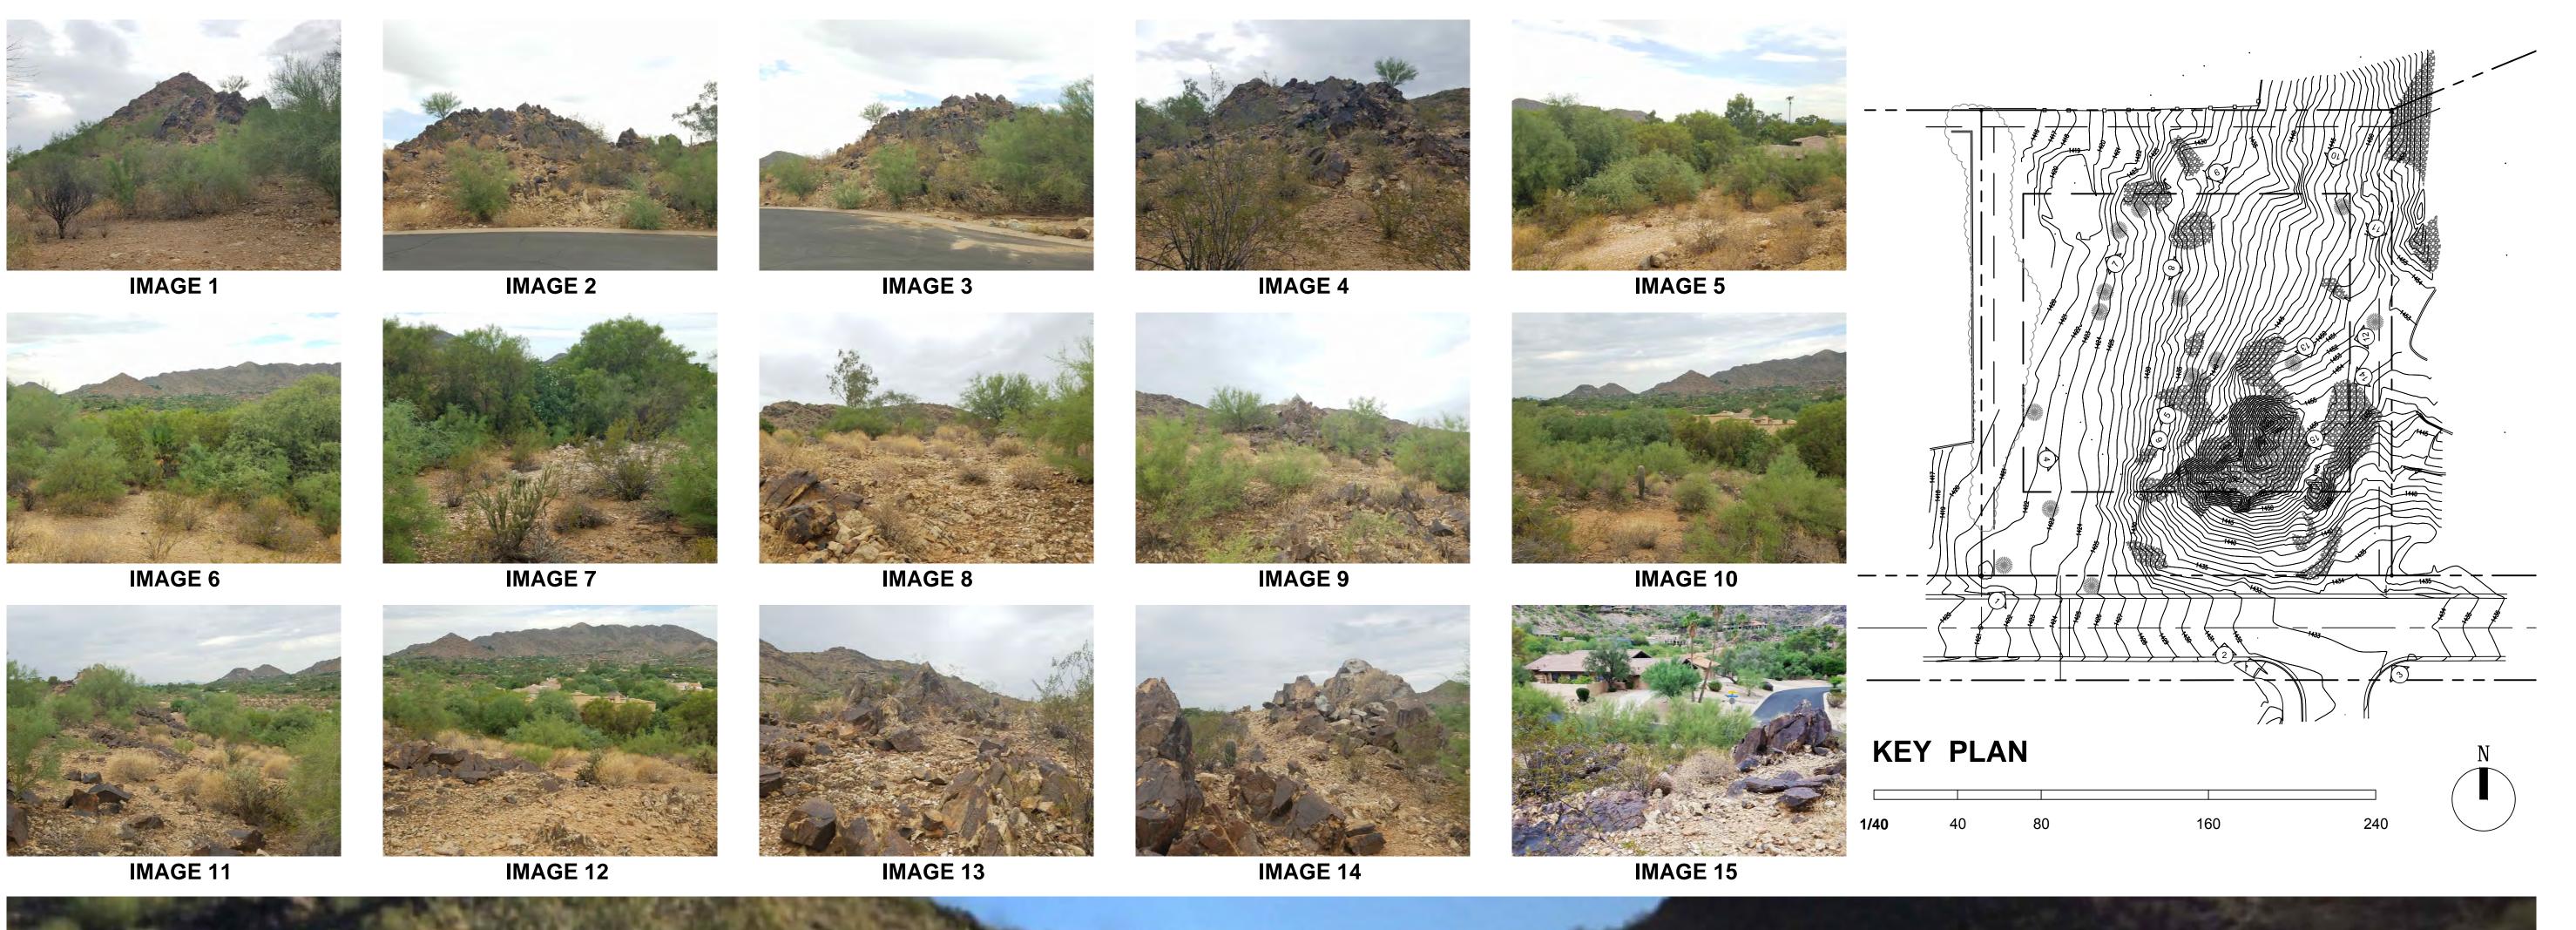

RENDERING

NTS



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ISSUE: 0/10/17 CONCEPT DEVI

DESCRIPTION

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CHECKED BY: BK


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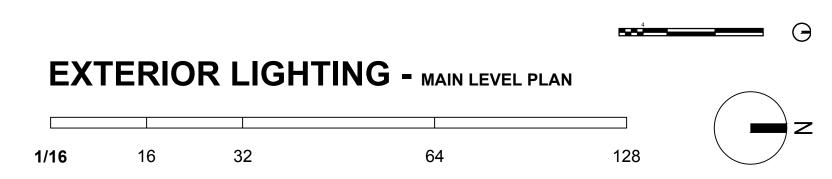
RENDERING & SITE PHOTOS


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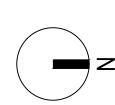
BUILDING LIGHTING FIXTURE SCHEDULE


TYPE	QTY	MFR	DESCRIPTION	LUMENS	WATTAGE
1	4	BEGA	BEGA K35 - 3500K COLOR TEMPERATURE	146 LM	2.3 W
2	2	CSL	LED STEPLIGHT, BRONZE SERIES SS3008-BZ	120 LM	3 W
3	26	JUNO	4" IC 700 LUMEN INTERNALLY ADJUSTABLE LED DOWN LIGHT	700LM	11.5 W
4	3	SORAA	SORAA MR16 9W - 2700K COLOR TEMPERATURE	590 LM	9W






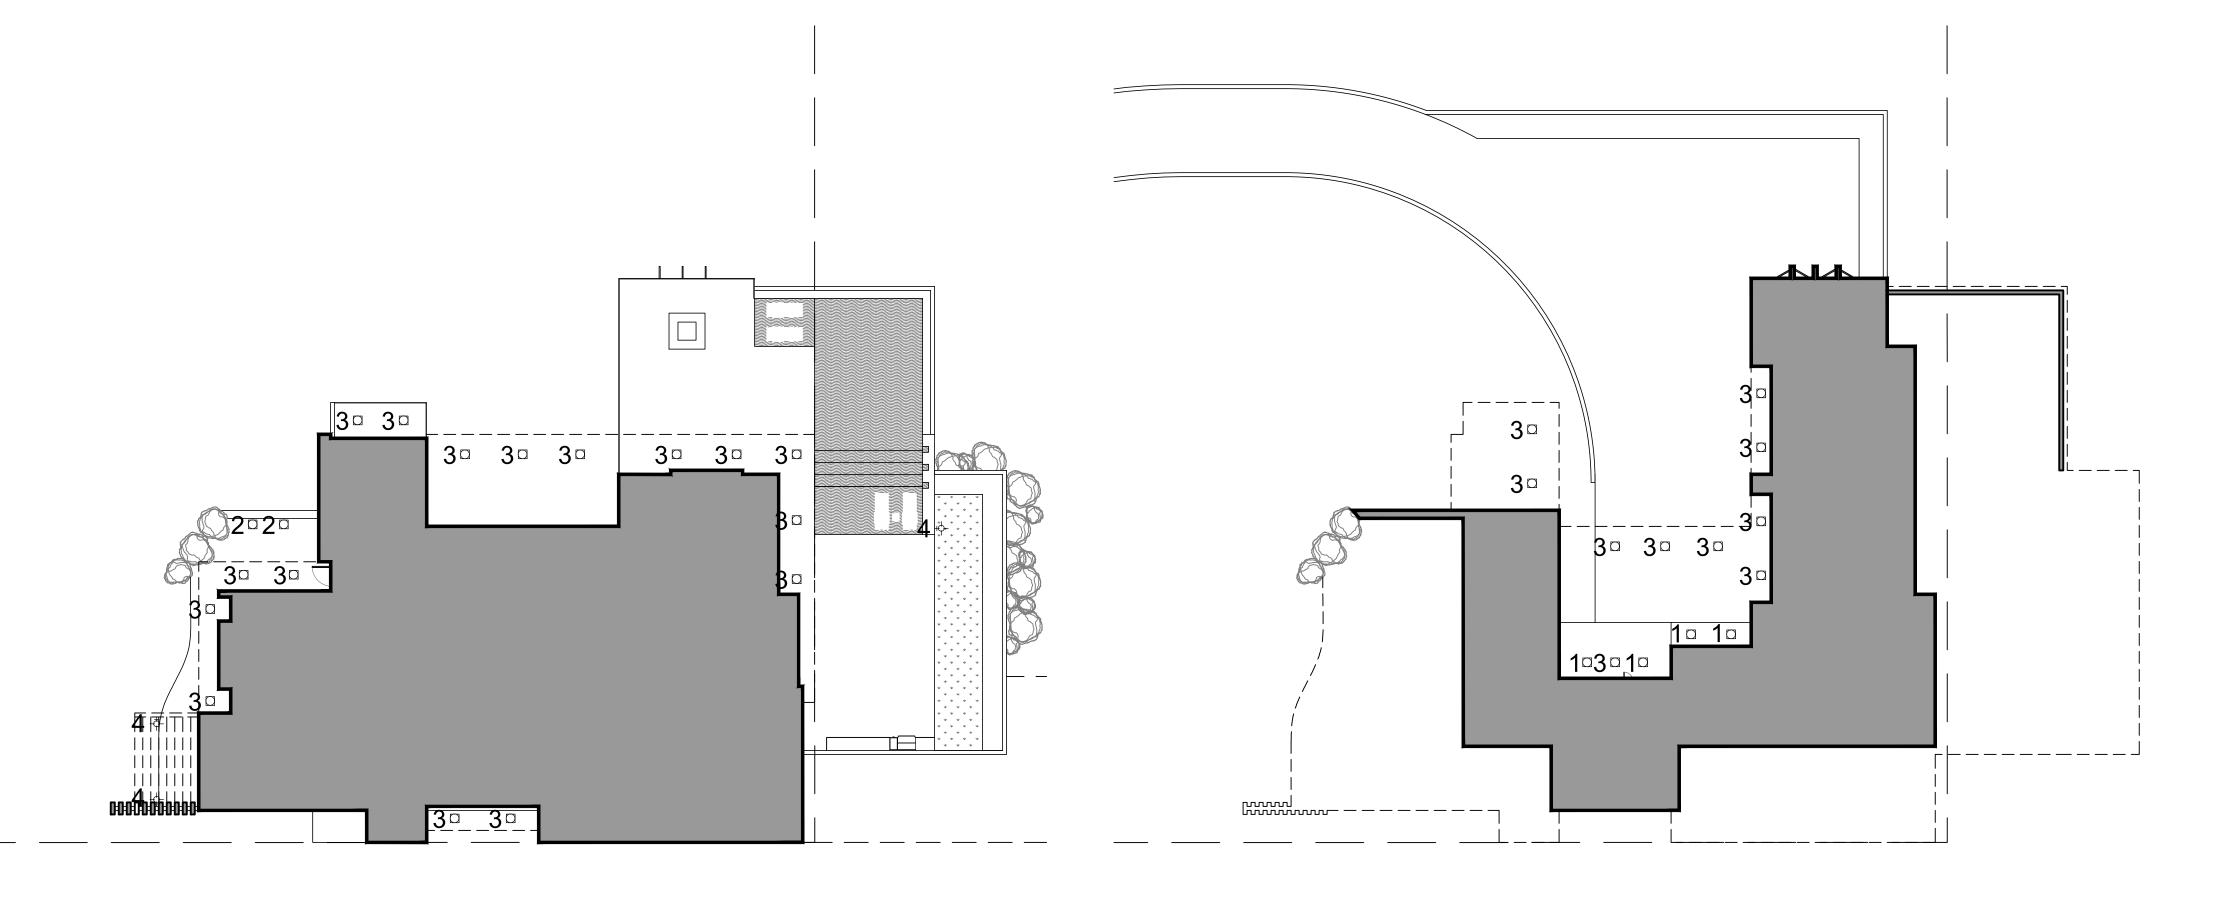

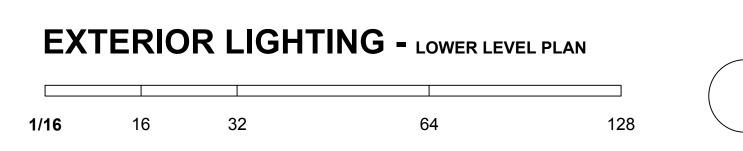


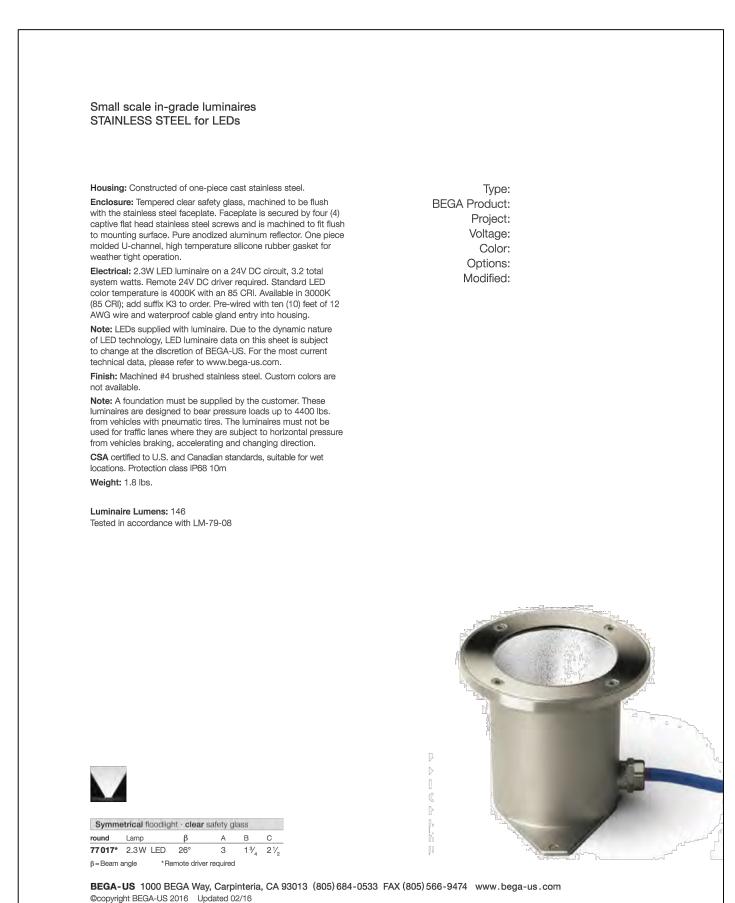

FIXTURE TYPE: 1

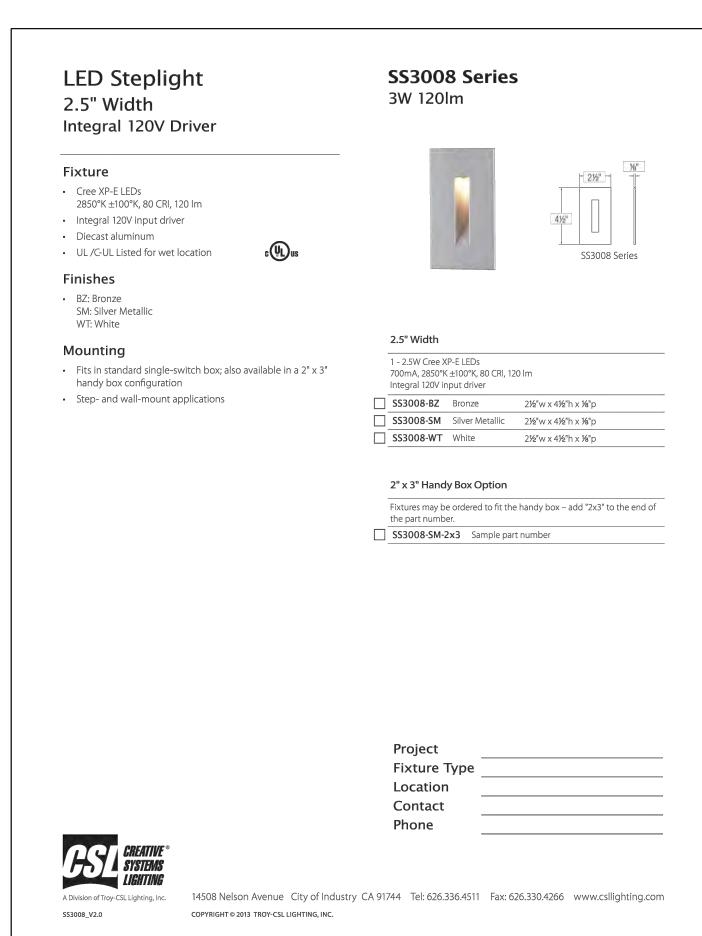

FIXTURE TYPE: 2

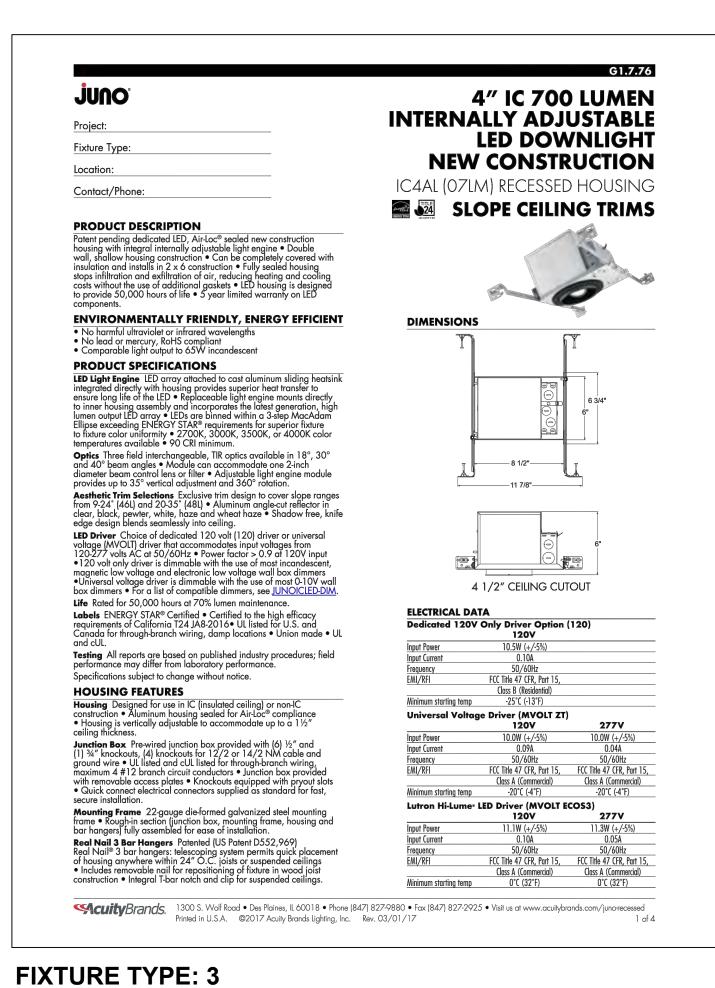



FIXTURE TYPE: 4



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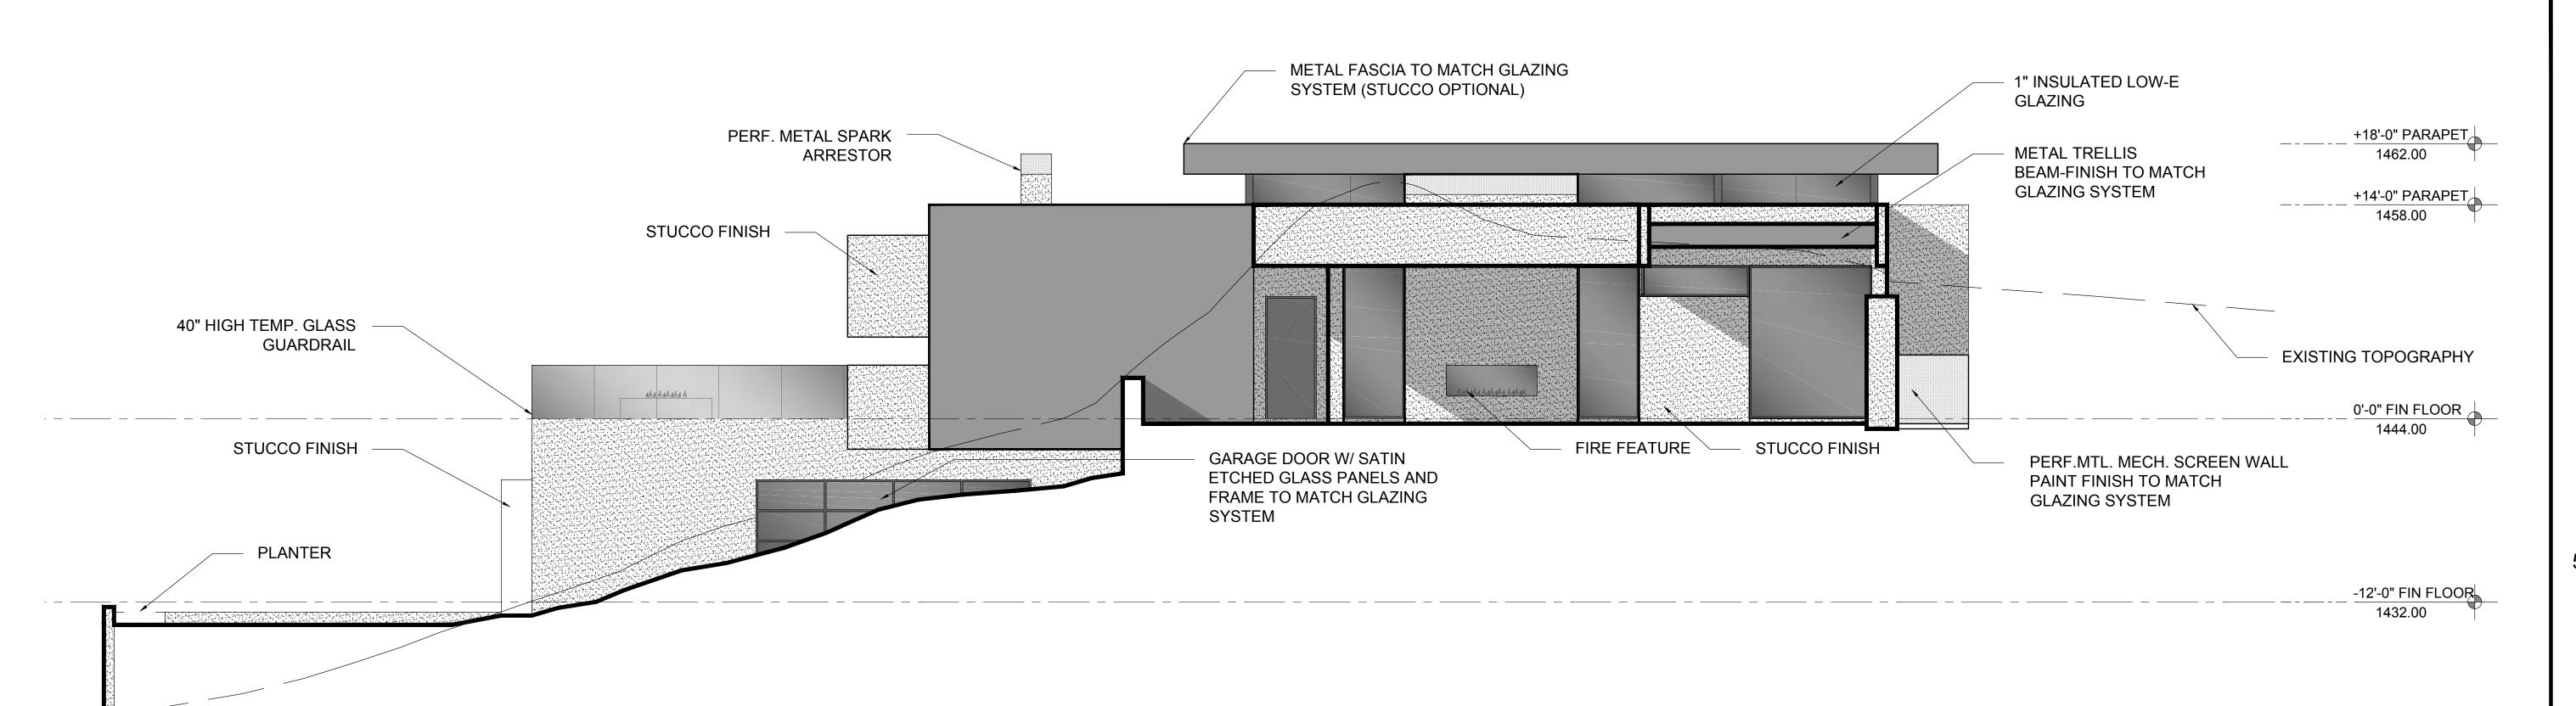
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CHECKED BY: BK


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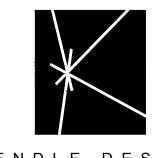
EXTERIOR
BULIDING
LIGHTING PLAN

A - 3.0



SOUTH ELEVATION 3/16 4 8 16 2



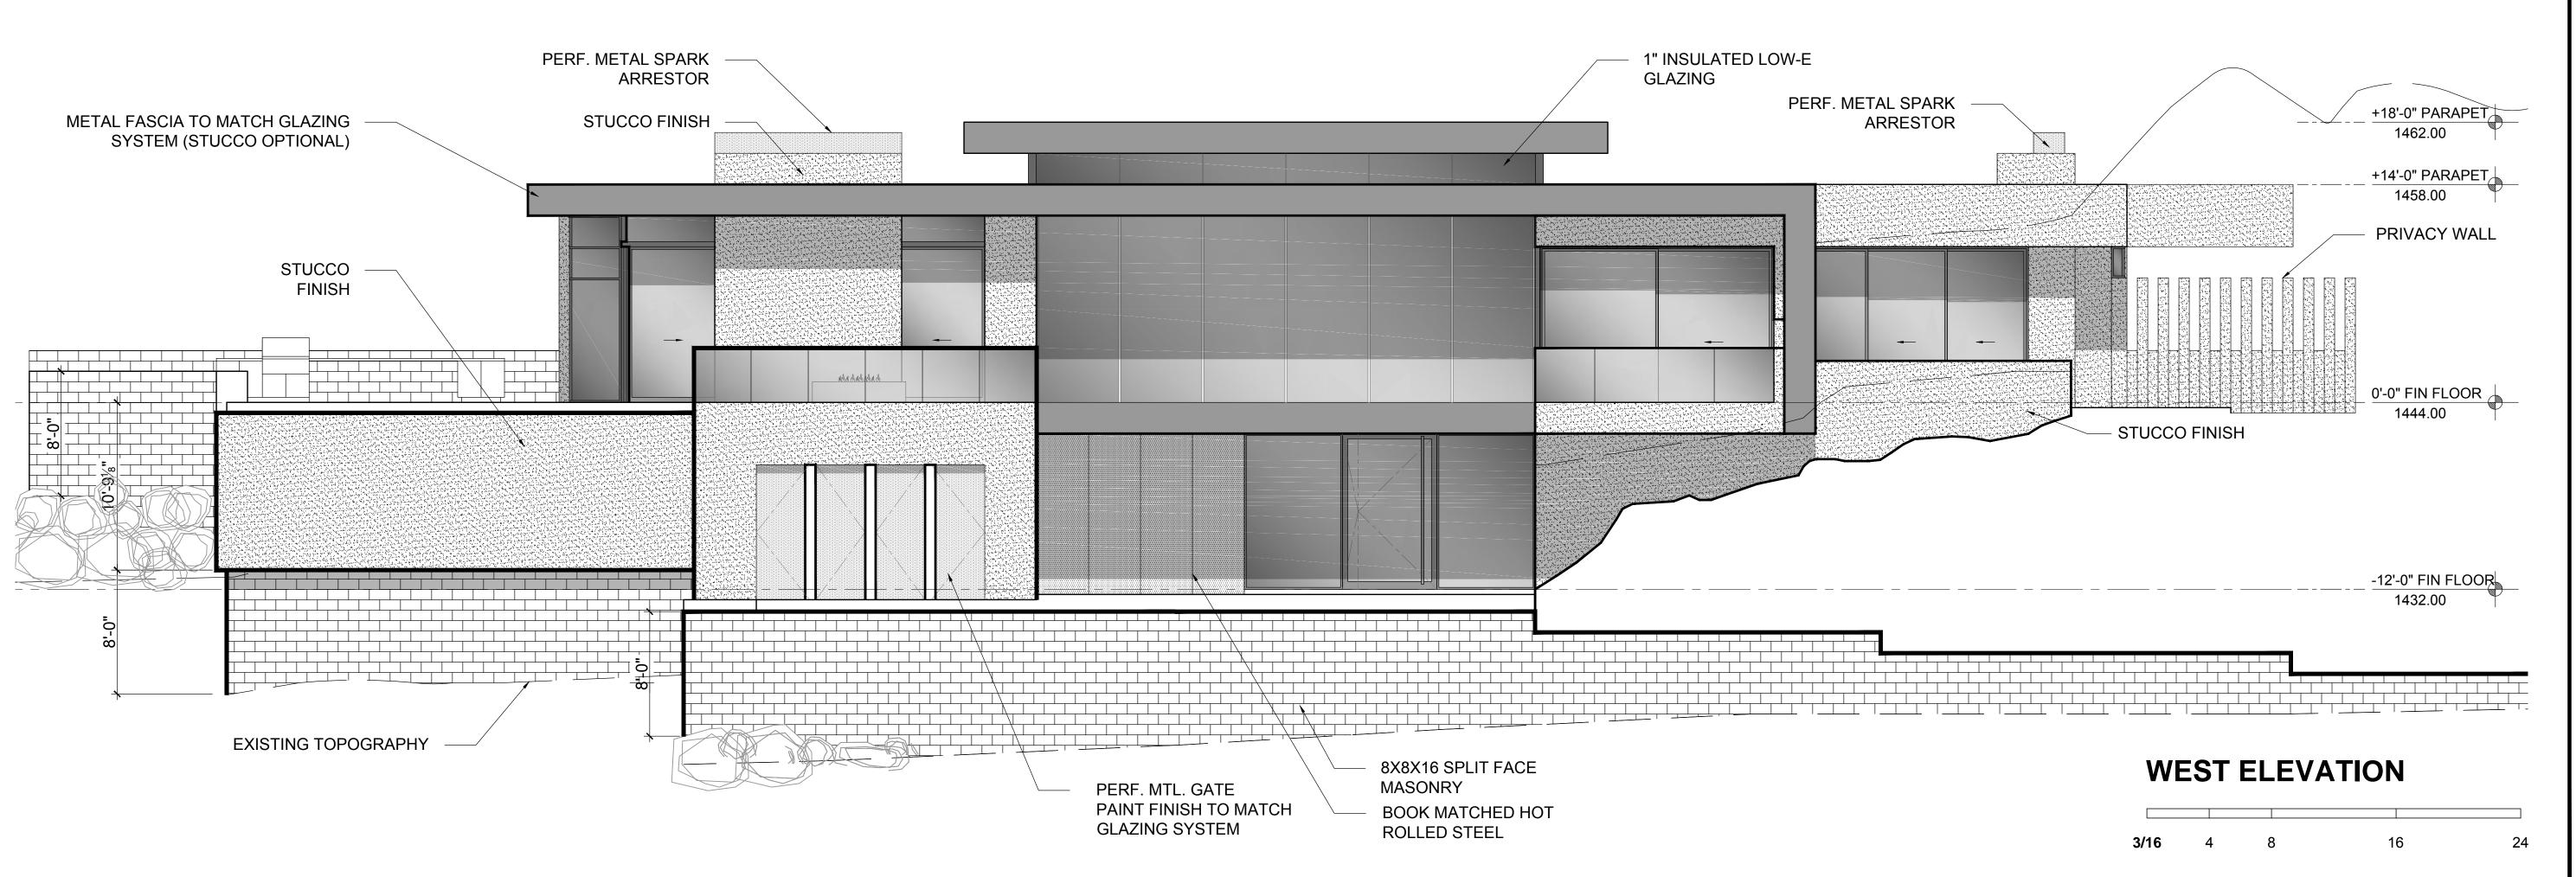

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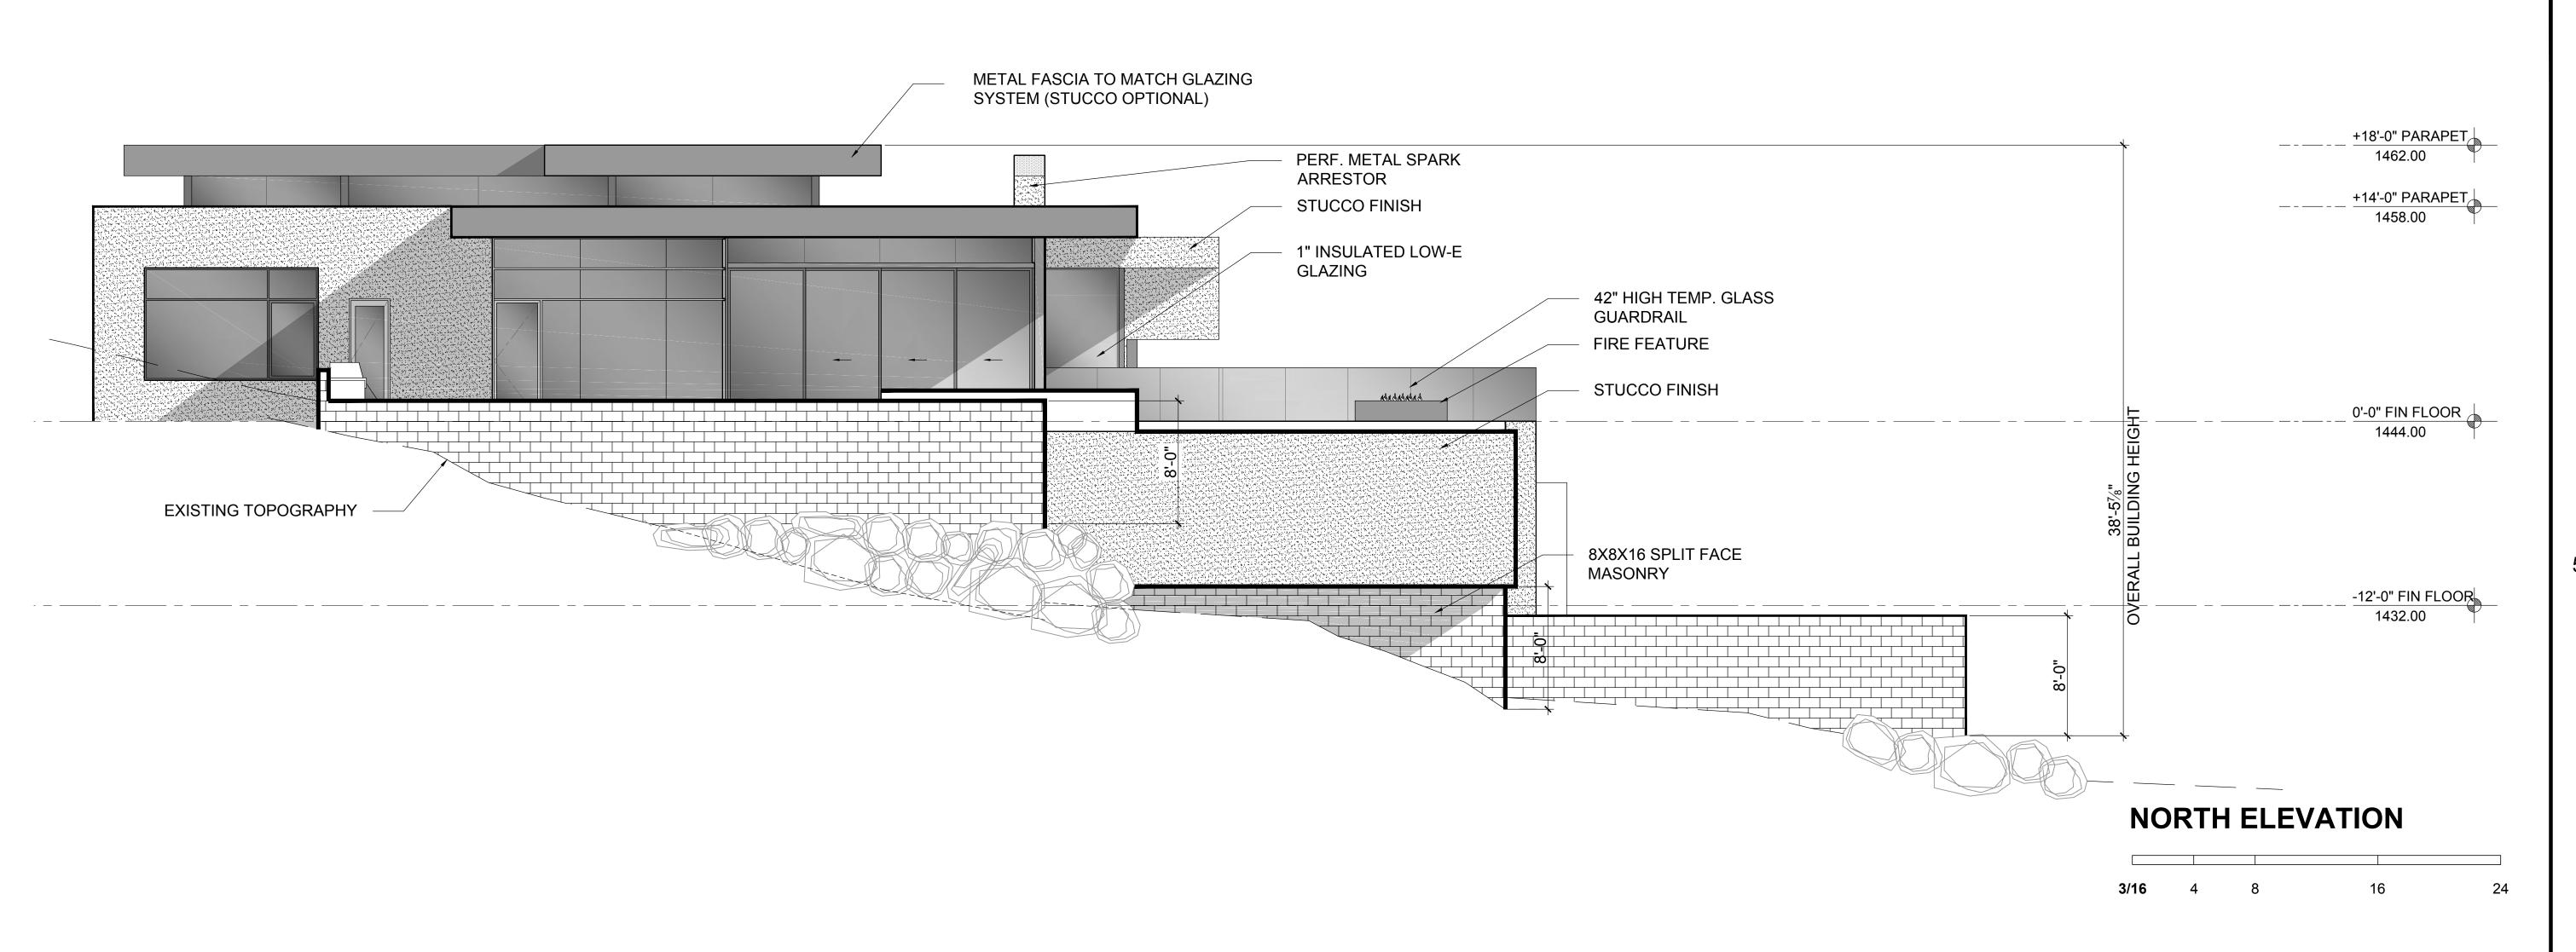
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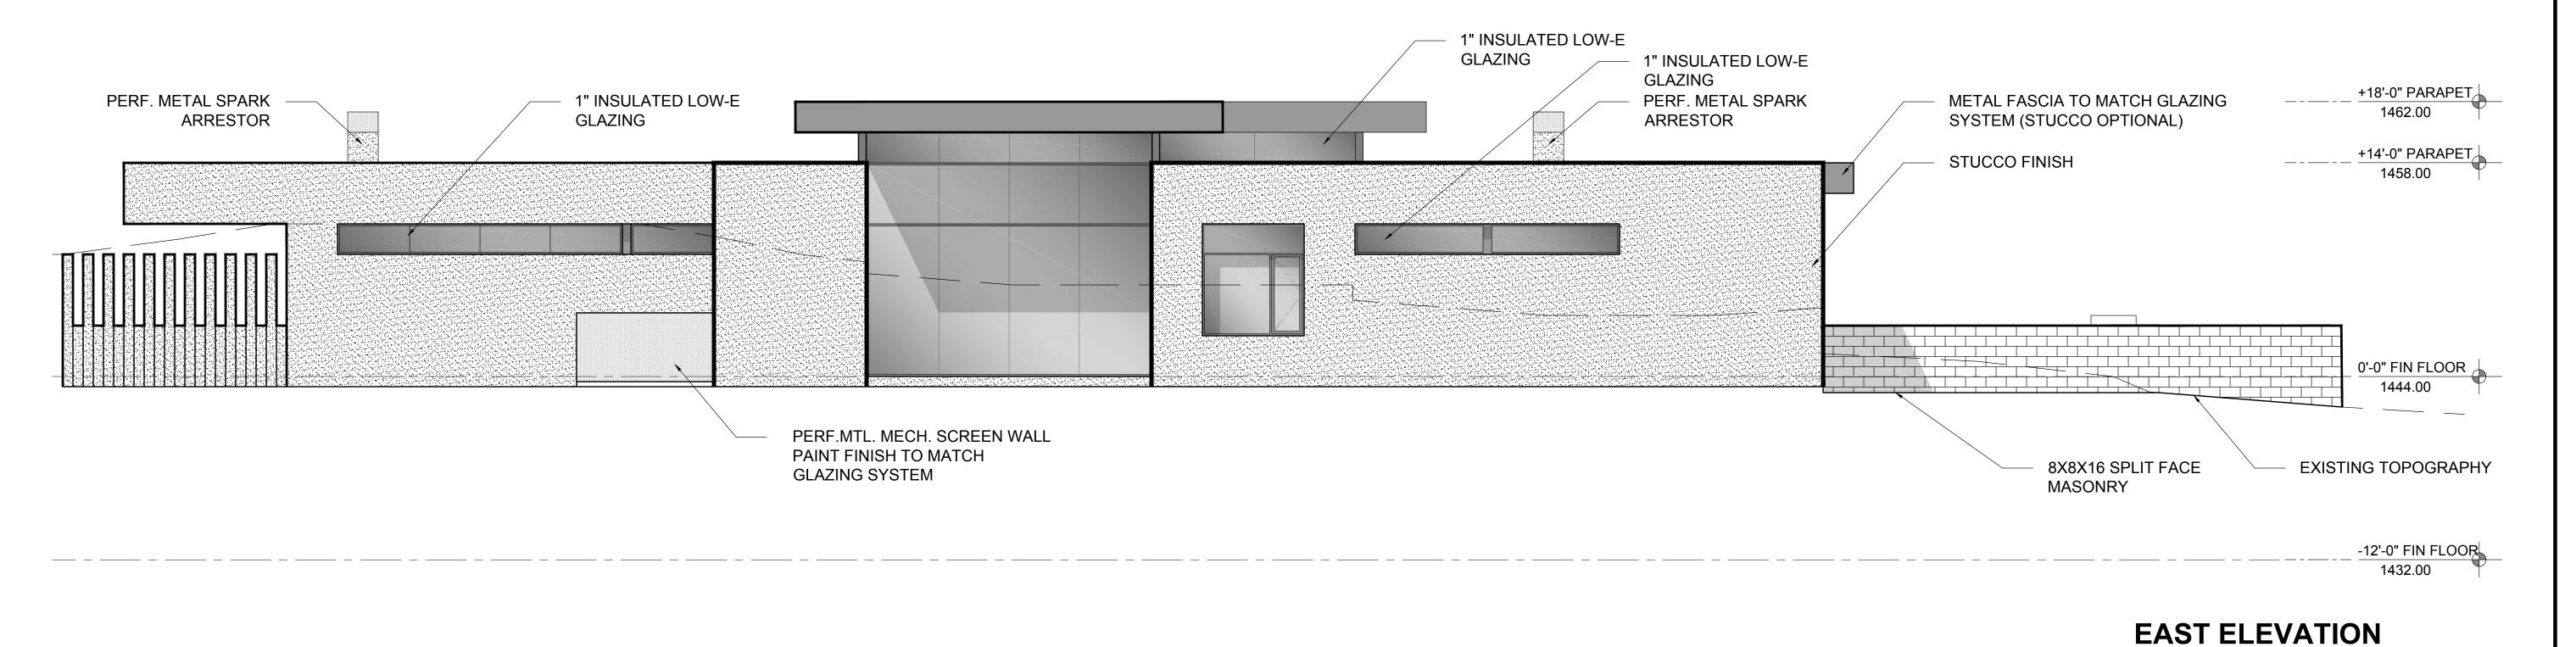
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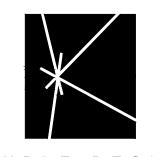
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EXTERIOR ELEVATIONS

A-4.0







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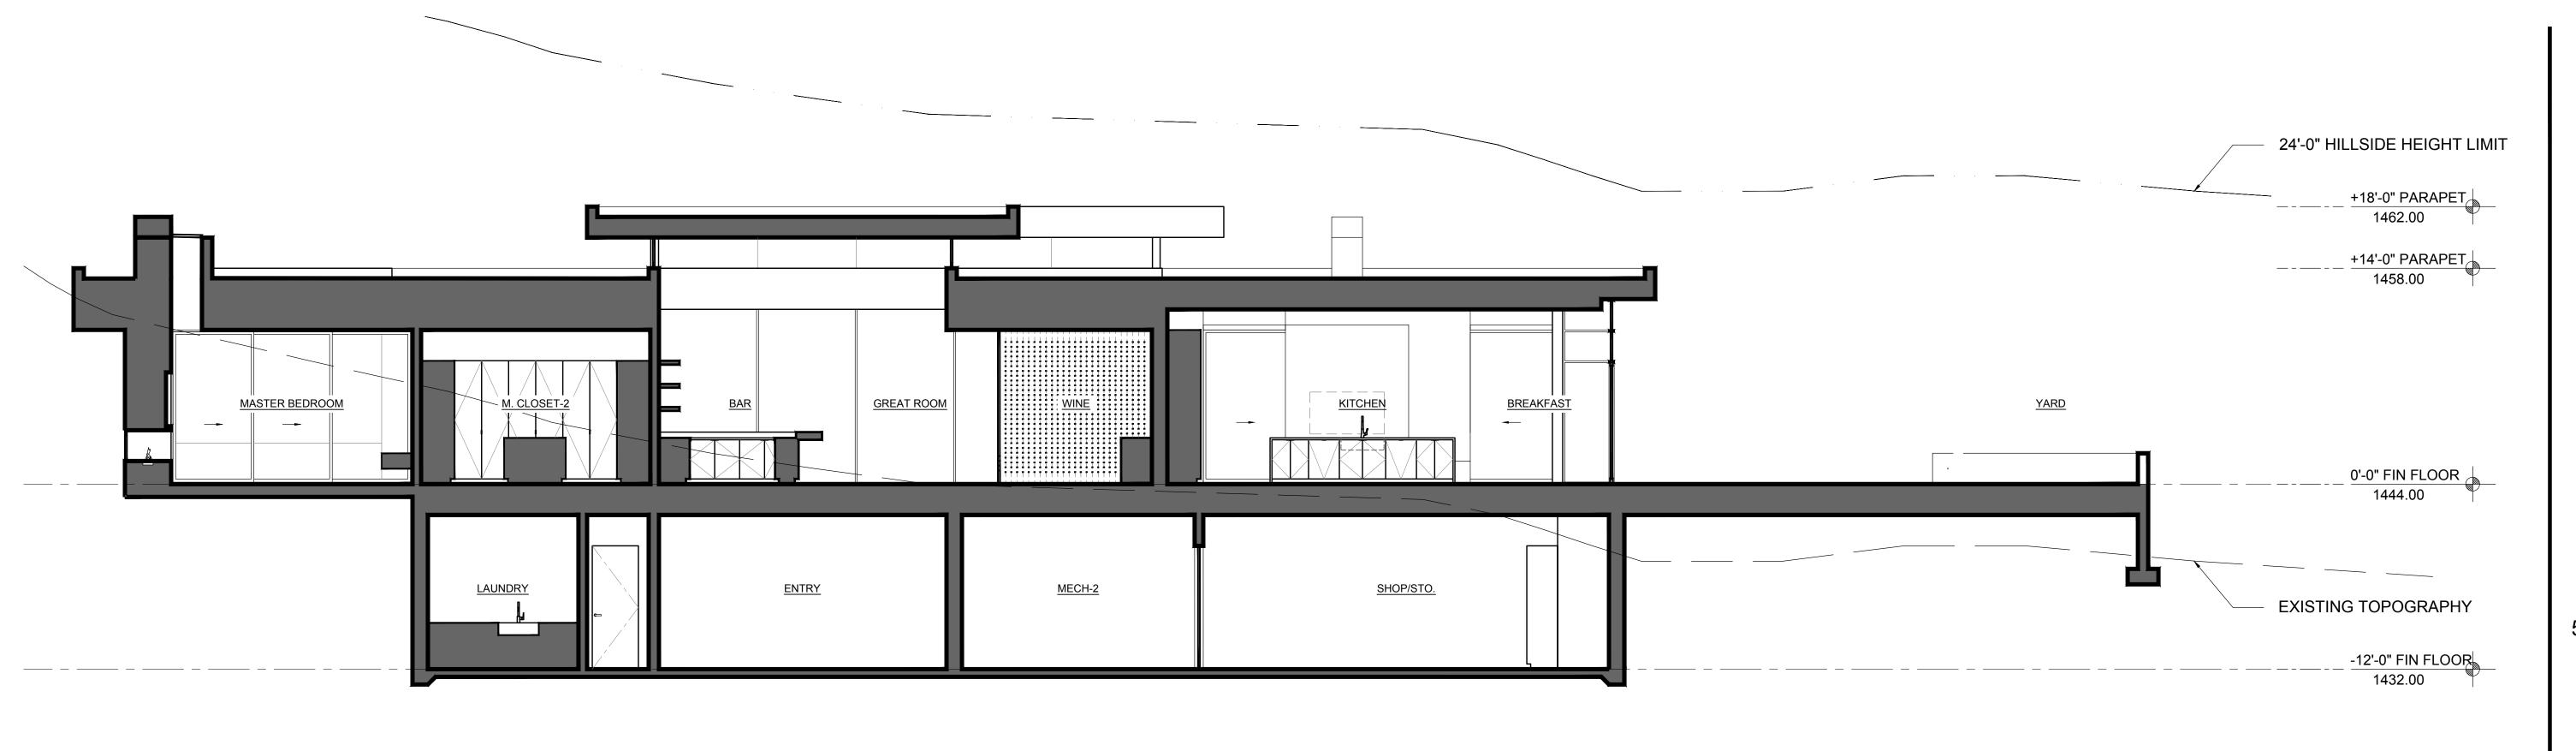
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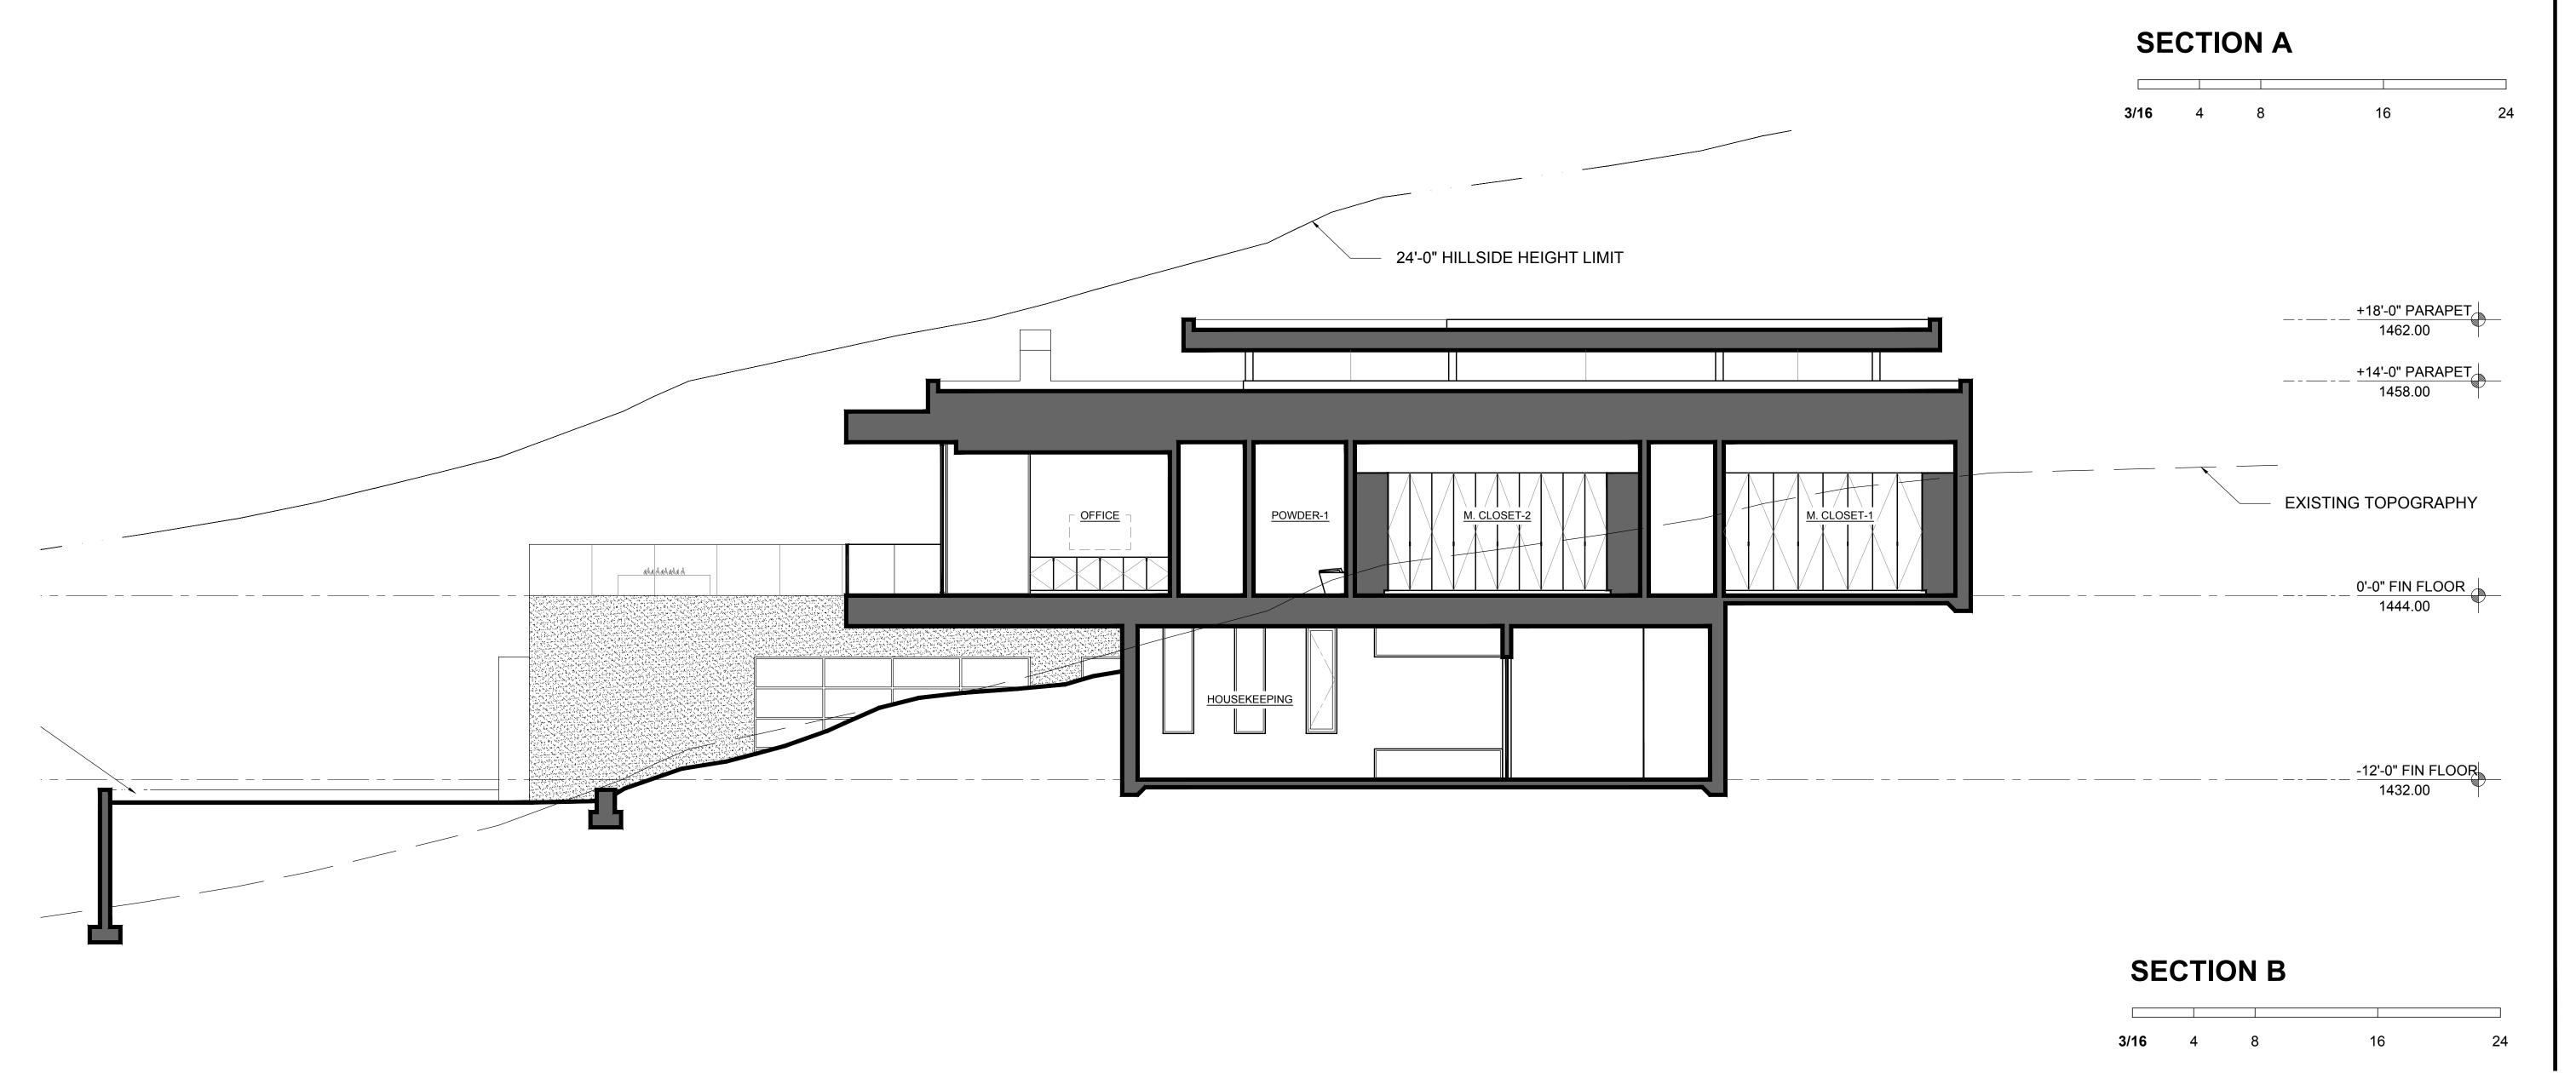
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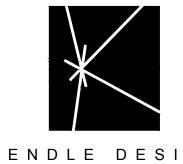
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EXTERIOR ELEVATIONS

A-4 1







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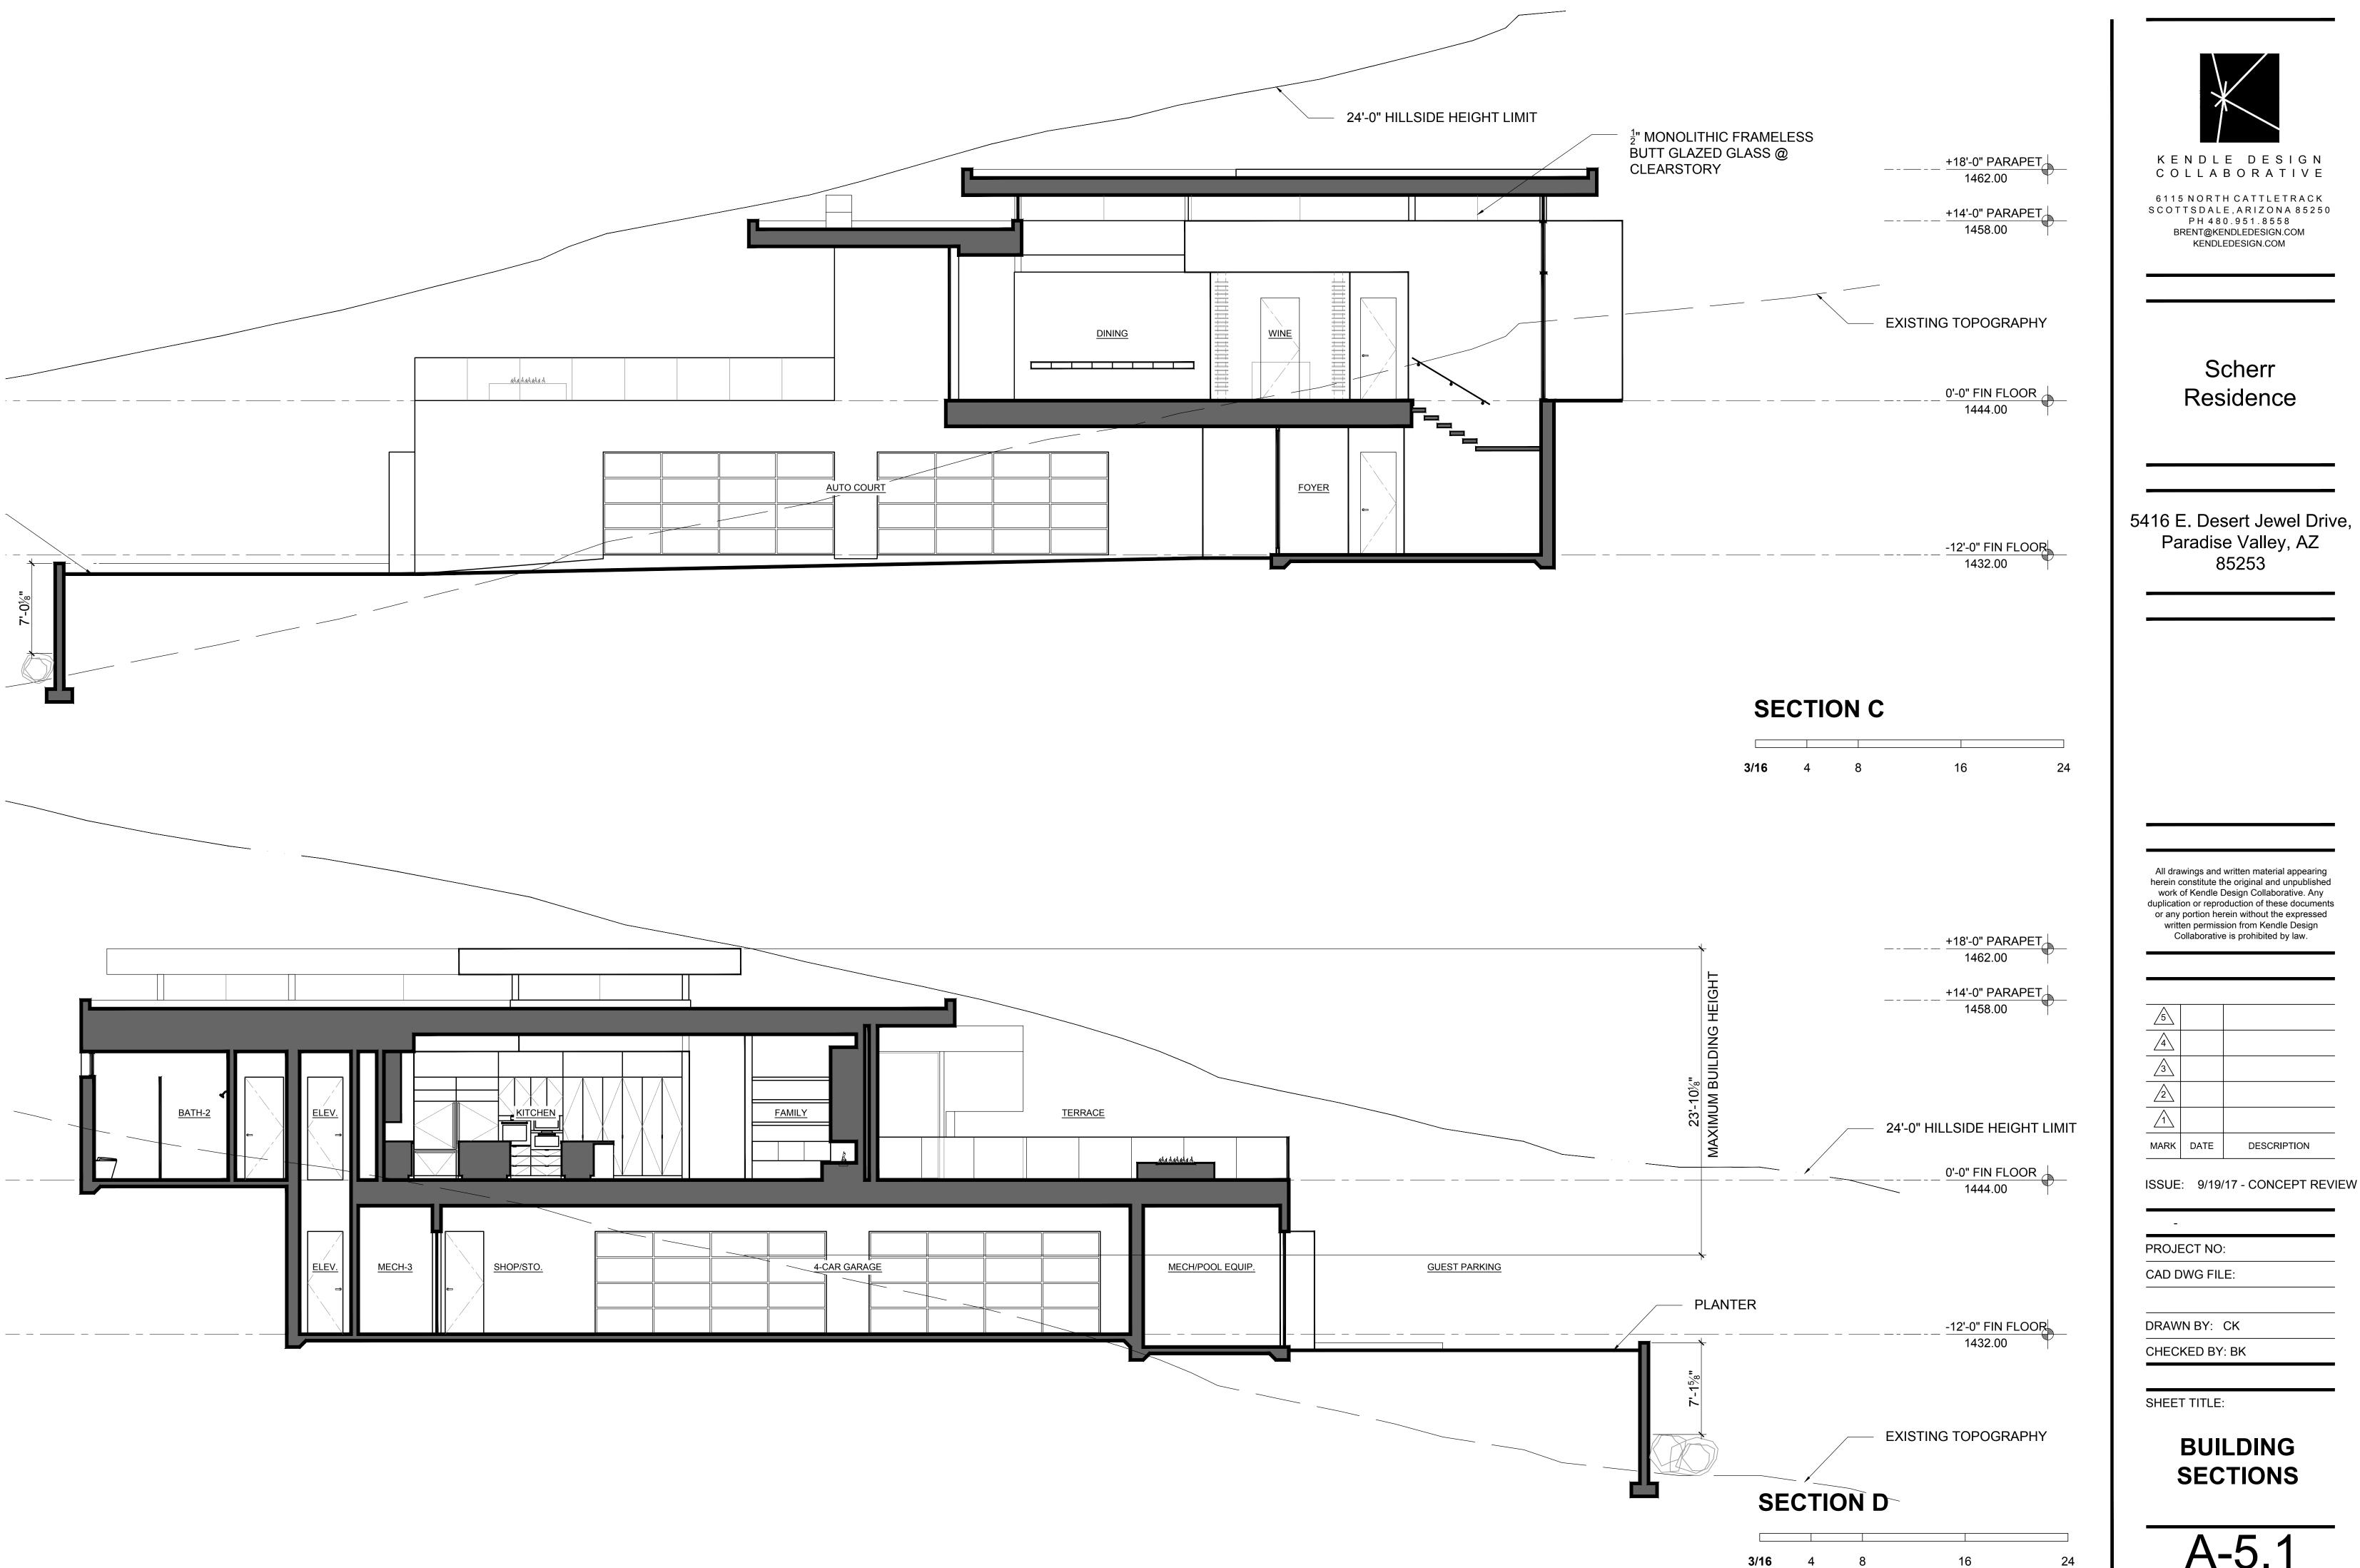
MARK DATE

DRAWN BY: CK
CHECKED BY: BK

SHEET TITLE:

BUILDING SECTIONS

A-5.0









VIEW 2



VIEW 3






VIEW 5





KEY PLAN

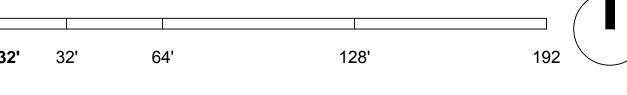


VIEW 6



VIEW 7



VIEW 8

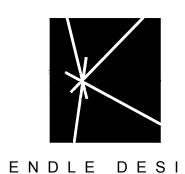

6115 NORTH CATTLETRACK SCOTTS DALE, ARIZONA 85250 PH 480.951.8558 BRENT@KENDLEDESIGN.COM KENDLEDESIGN.COM

Scherr Residence

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MADK	DATE	DESCRIPTION

ISSUE: 9/19/17 - CONCEPT REVI

PROJECT NO:
CAD DWG FILE:

DRAWN BY: CK
CHECKED BY: BK

SHEET TITLE:

MASSING MODEL

A-6.0

GLAZINGCLEAR, LOW-E INSULATED GLAZING
IN DARK BRONZE ANODIZED FRAME SPLIT FACE CMU TBD STUCCO SMOOTH SAND FINISH. MATCH BENJAMIN GARAGE DOORS
TRANSLUCENT PANELS W/ FRAME HOT ROLLED STEEL TBD METAL 2 STUCCO PAINTED TO MATCH WINDOW SYSTEM FINISH LRV: 2.5 SMOOTH SAND FINISH. MATCH BENJAMIN MOORE HC-166 KENDALL CHARCOAL MOORE AF-675 FUSION TO MATCH METAL 2 LRV: 12.6 LRV 36.3

FLAT ROOFDURO-LAST SINGLE PLY ROOF

LRV: 25

MEMBRANE. COLOR: DARK GREY

GUARDRAIL

42" HIGH TEMP. GLASS, CLEAR

PERMEABLE PAVERS

HARDSCAPE

LRV: TBD

TO MATCH INTERIOR: TBD

METAL 1

LRV: 2.5

KYNAR 500 COLOR: MATTE BLACK



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MADK	DATE	DESCRIPTION

ISSUE: 9/19/17 - CONCEPT REVIEW

PROJECT NO:

CAD DWG FILE:

DRAWN BY: CK
CHECKED BY: BK

SHEET TITLE:

EXTERIOR MATERIALS

A - 7.0