
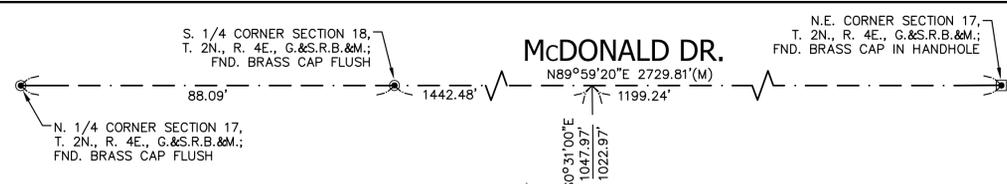


TOPOGRAPHIC SURVEY


BEING A PORTION OF THE NORTHEAST QUARTER OF SECTION 17, TOWNSHIP 2 NORTH, RANGE 4 EAST, OF THE GILA & SALT RIVER BASE & MERIDIAN, MARICOPA COUNTY, ARIZONA

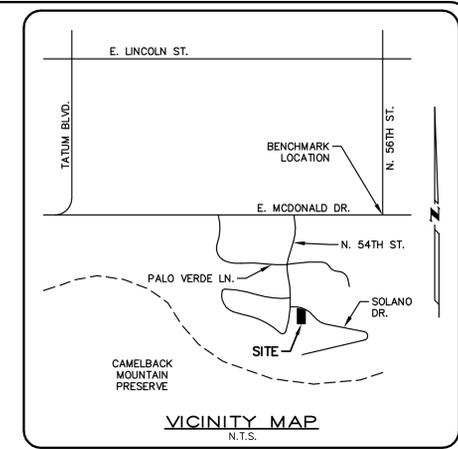

- LEGEND**
- PROPERTY LINE
 - - - RIGHT OF WAY LINE
 - - - SECTION LINE
 - - - CENTER LINE
 - - - EASEMENT LINE
 - - - CONTOUR LINE
 - - - UNDERGROUND UTILITY
 - - - EDGE OF PAVEMENT
 - M.B. MAIL BOX
 - CTV UNDERGROUND CABLE TV
 - CT.R. CABLE TV RISER
 - CT.VLT. CABLE TV VAULT
 - E UNDERGROUND ELECTRIC
 - E.M. ELECTRIC METER
 - E.O. ELECTRIC OUTLET
 - E.T. ELECTRIC TRANSFORMER
 - E.VLT. ELECTRIC VAULT
 - G UNDERGROUND GAS
 - G.M. GAS METER
 - S UNDERGROUND SEWER
 - S.C.O. SEWER CLEAN-OUT
 - SM SEWER MANHOLE
 - S.S. SEWER SERVICE
 - D UNDERGROUND STORM DRAIN
 - R.D. ROOF DRAIN
 - T UNDERGROUND TELEPHONE
 - T.R. TELEPHONE RISER
 - W UNDERGROUND WATER
 - W.M. WATER METER
 - H.B. HOSE BIB
 - SAGUARO CACTUS
 - TREE (TRUNK SIZE & TYPE)
 - (R) RECORD
 - (M) MEASURED
 - FND. FOUND
 - R.O.W. RIGHT OF WAY
 - M.C.R. MARICOPA COUNTY RECORDER OFFICE
 - A.P.N. ASSESSOR PARCEL NUMBER
 - B BRICK ELEVATION
 - TC TOP CURB ELEVATION
 - G GUTTER ELEVATION
 - P PAVEMENT ELEVATION
 - C CONCRETE ELEVATION
 - NG NATURAL GROUND
 - INV INVERT
 - TB TOP BANK
 - BB BOTTOM BANK
 - TW TOP WALL

CURVE TABLE

CURVE #	RADIUS	LENGTH	DELTA	TANGENT
C1	107.51'	60.05'	32°00'08"	30.83
C2	132.51'	74.01'	32°00'09"	38.00

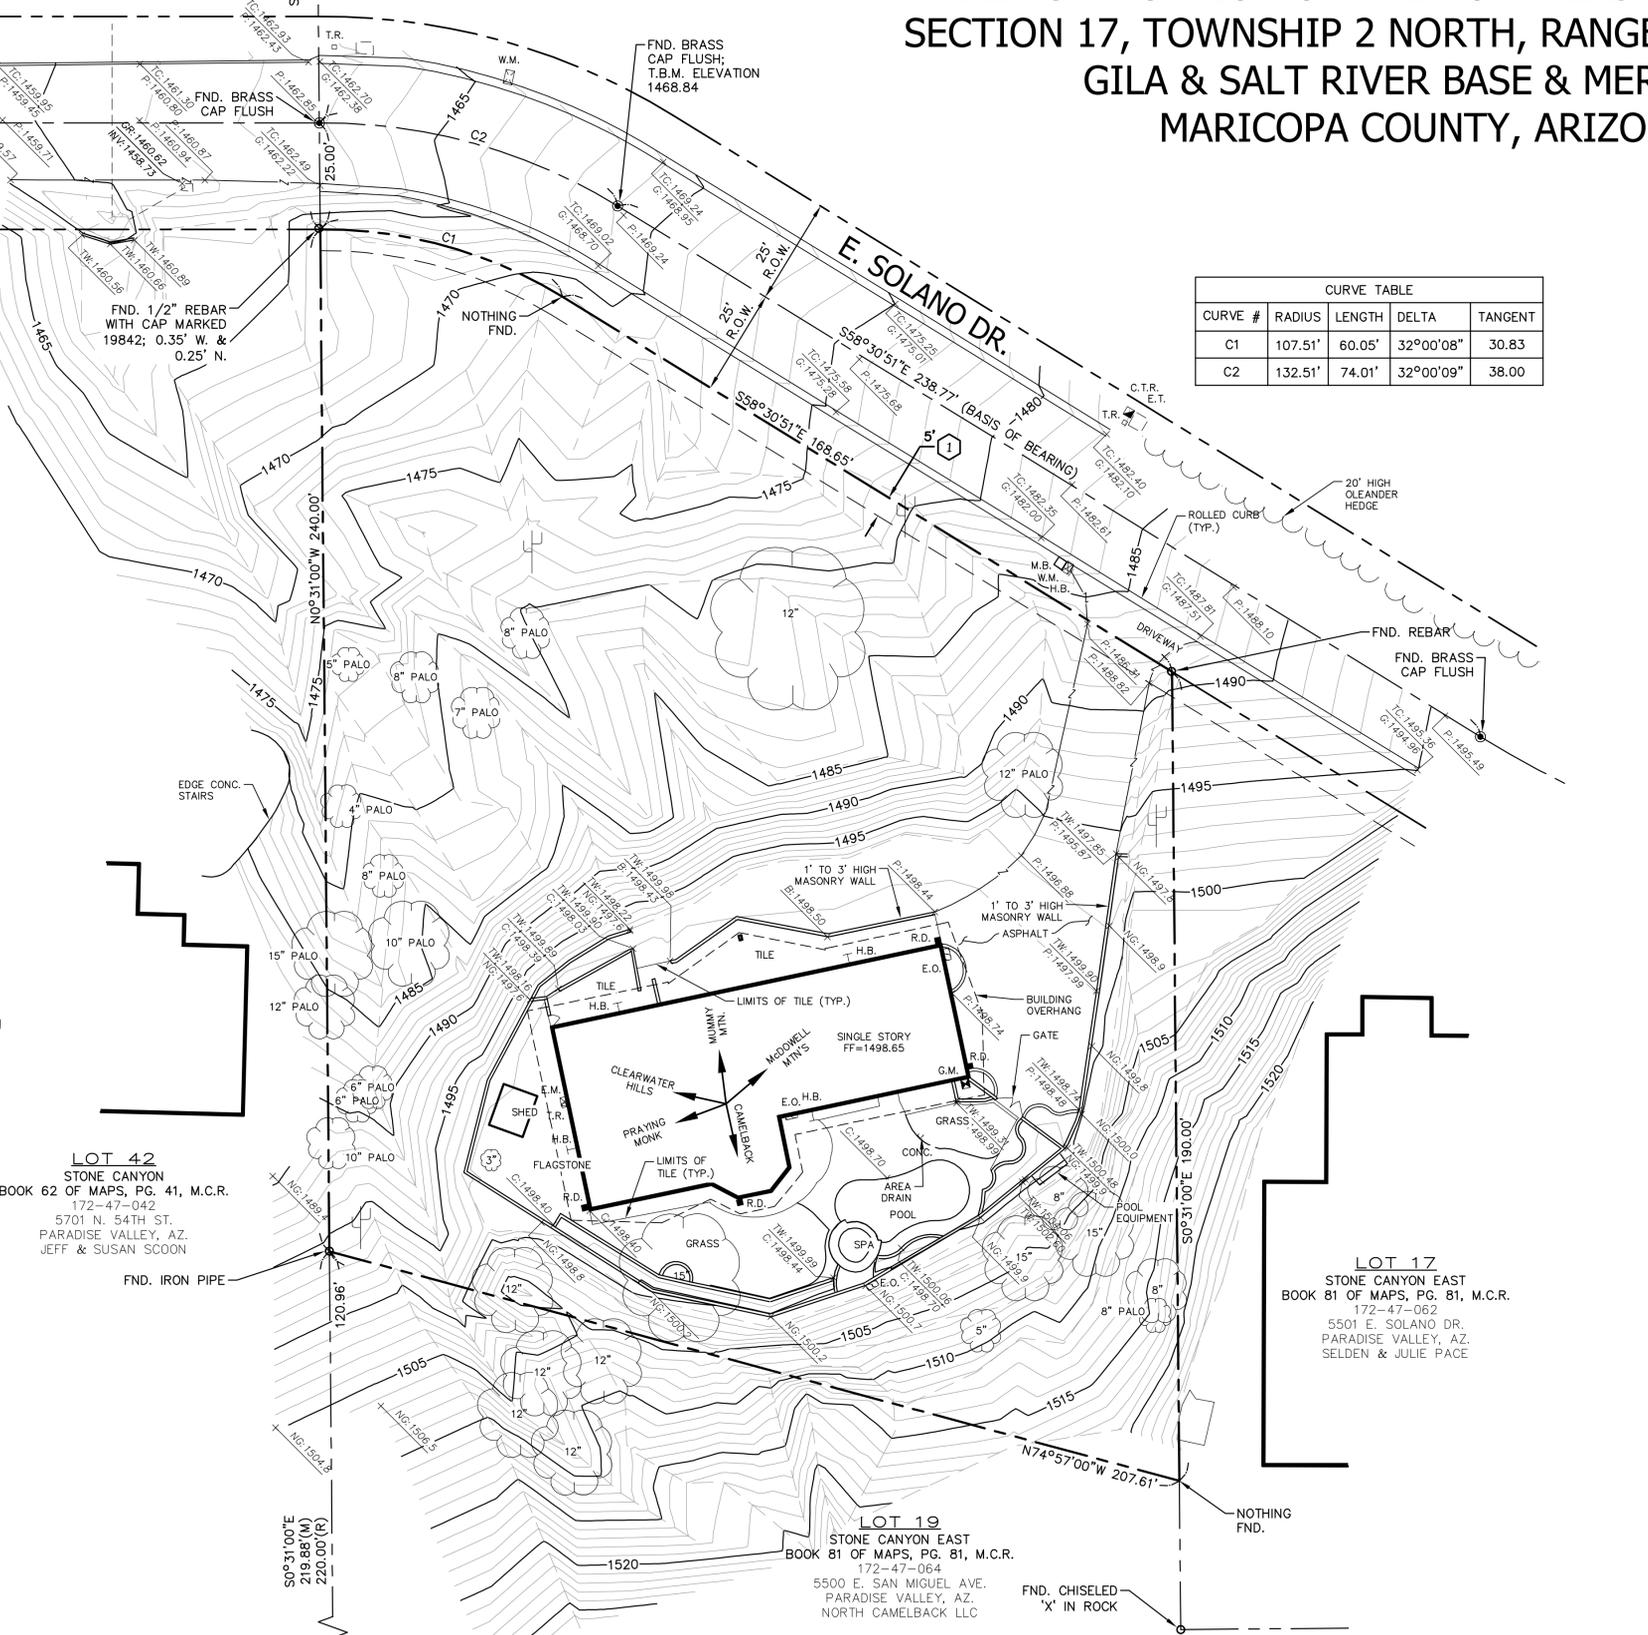

LOT 42
STONE CANYON
BOOK 62 OF MAPS, PG. 41, M.C.R.
172-47-042
5701 N. 54TH ST.
PARADISE VALLEY, AZ.
JEFF & SUSAN SCOON

LOT 17
STONE CANYON EAST
BOOK 81 OF MAPS, PG. 81, M.C.R.
172-47-062
5501 E. SOLANO DR.
PARADISE VALLEY, AZ.
SELDEN & JULIE PACE

LOT 19
STONE CANYON EAST
BOOK 81 OF MAPS, PG. 81, M.C.R.
172-47-064
5500 E. SAN MIGUEL AVE.
PARADISE VALLEY, AZ.
NORTH CAMELBACK LLC

SITE ADDRESS
5429 E. SOLANO DRIVE
PARADISE VALLEY, ARIZONA

ASSESSORS PARCEL NUMBER
A.P.N. 172-47-063

LEGAL DESCRIPTION
LOT 18 AS SHOWN ON THE PLAT OF STONE CANYON EAST RECORDED IN BOOK 81 OF MAPS, PAGE 34, MARICOPA COUNTY RECORDERS OFFICE.

SITE AREA
AREA = 44,542 SQ.FT. OR 1.0225 ACRES MORE OR LESS

BASIS OF BEARING
CENTERLINE OF EAST SOLANO DRIVE WHICH BEARS S58°30'51"E AS SHOWN ON THE PLAT OF STONE CANYON EAST RECORDED IN BOOK 81 OF MAPS, PAGE 34, M.C.R.

BENCHMARK
BRASS CAP IN HANDHOLE LOCATED AT THE INTERSECTION OF McDONALD DRIVE AND N. 56TH STREET SAID POINT ALSO BEING THE N.E. CORNER SECTION 17, T. 2N., R. 4E., G.&S.R.B.&M.;
ELEVATION = 1417.53 TOWN OF PARADISE VALLEY DATUM
T.B.M.: BRASS CAP FLUSH LOCATED AT A POINT OF TANGENCY ALONG E. SOLANO DRIVE CENTERLINE NORTH OF LOT 18 OF STONE CANYON EAST, SHOWN HEREON.
ELEVATION = 1468.84

FLOOD PLAIN
THE SUBJECT PROPERTY IS LOCATED WITHIN SHADED ZONE "X" DEFINED AS "AREAS OF 0.2% ANNUAL CHANCE FLOOD; AREAS OF 1% ANNUAL CHANCE FLOOD WITH AVERAGE DEPTHS OF LESS THAN 1 FOOT OR WITH DRAINAGE AREAS LESS THAN 1 SQUARE MILE; AND AREAS PROTECTED BY LEVEES FROM 1% ANNUAL CHANCE FLOOD; AS SHOWN ON FIRM MAP NO. 04013C1765L, DATED OCTOBER 16, 2013.

ZONING
SUBJECT PROPERTY IS CURRENTLY ZONED HILLSIDE, AS SHOWN ON TOWN OF PARADISE VALLEY, AZ. ZONING MAP, REVISED DATE 4-24-2013.

SURVEYOR'S UTILITY NOTE
UNDERGROUND UTILITIES LOCATIONS SHOWN HEREON ARE BASED ON FIELD OBSERVATIONS AND AVAILABLE MAPS OBTAINED FROM UTILITY COMPANIES AND THE CITY OF SCOTTSDALE, AZ.. ACTUAL LOCATIONS MAY VARY FROM LOCATIONS SHOWN HEREON.

EASEMENTS
① 5' WIDE EASEMENT FOR ROADWAY AS SHOWN ON THE FINAL PLAT FOR STONE CANYON EAST AS RECORDED IN BOOK 81 OF MAPS PAGE 34, M.C.R.

TITLE NOTE
THIS SURVEY WAS PERFORMED WITHOUT THE BENEFIT OF A TITLE REPORT. EASEMENTS SHOWN HEREON ARE PER THE PLAT OF RECORD, ADDITIONAL EASEMENTS MAY EXIST.

OWNER
TONN INVESTMENTS, L.L.C.
4350 E. CAMELBACK RD.
PHOENIX, AZ. 85018
TELE: 602-684-1000
CONTACT: SCOTT TONN
EMAIL: STONN@TONNINV.COM

SURVEYOR
SITE CONSULTANTS, INC.
113 SOUTH ROCKFORD DRIVE
TEMPE, ARIZONA 85281
TELE: 480-894-2820
CONTACT: GARY STOCKER, R.L.S.

CERTIFICATION:
THIS IS TO CERTIFY THAT THE TOPOGRAPHIC INFORMATION SHOWN HEREON IS TRUE TO THE BEST OF MY KNOWLEDGE AND BELIEF, AND WAS SURVEYED AND DRAWN UNDER MY DIRECTION DURING THE MONTH OF AUGUST & SEPTEMBER 2015.

Gary E. Stocker
GARY E. STOCKER, R.L.S. 9-24-15 DATE

REV. 2016-07-20
FIX ADDRESS

REV.

REV.

REV.

REV.

Site Consultants, Inc.
ENGINEERS • SURVEYORS • CONSULTANTS
113 SOUTH ROCKFORD DRIVE, TEMPE, ARIZONA 85281
TEL: (480) 894-2820, FAX: (480) 894-2847

TOPOGRAPHIC SURVEY
LOT 18 - STONE CANYON EAST
5429 E. SOLANO DRIVE
PARADISE VALLEY, AZ.




PROJECT NO.: 2080
SCALE: 1" = 20'
DRAWN BY: MGO
CHECKED BY: GES
DATE: 9-24-2015
DWG: 2080-V-TOPO

PRELIMINARY GRADING & DRAINAGE PLAN

TONN RESIDENCE

5429 E SOLANO DR., PARADISE VALLEY, AZ 85253

LOT 19 - STONE CANYON EAST
RECORDED IN BOOK 81 OF MAPS, PAGE 34, M.C.R.,
LOCATED IN A PORTION OF THE NW 1/4 OF THE SE 1/4 NE 1/4 OF SECTION 17, T.2N, R.4E OF THE
GILA & SALT RIVER BASE AND MERIDIAN, MARICOPA COUNTY, ARIZONA

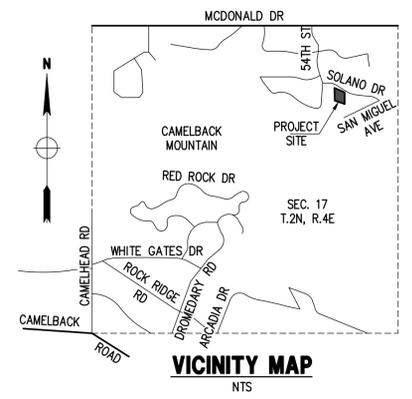


TOWN OF PARADISE VALLEY GENERAL NOTES

- PRIOR TO THE FIRST INSPECTION OF STRUCTURES WITHIN 3 FEET OF A SETBACK LINE, THE PROPERTY PINS SHALL BE PLACED BY A REGISTERED CIVIL ENGINEER OR LAND SURVEYOR OF THE STATE OF ARIZONA, AND THE PROPERTY LINE(S) IDENTIFIED.
- WHERE EXCAVATION IS TO OCCUR THE TOP 4" OF EXCAVATED NATIVE SOIL SHALL REMAIN ON THE SITE AND SHALL BE REUSED IN A MANNER THAT TAKES ADVANTAGE OF THE NATURAL SOIL SEED BANK IT CONTAINS.
- ALL WORK REQUIRED TO COMPLETE THE CONSTRUCTION COVERED BY THIS PLAN SHALL BE IN ACCORDANCE WITH THE MARICOPA ASSOCIATION OF GOVERNMENTS (M.A.G.) STANDARD SPECIFICATIONS AND DETAILS AND CURRENT SUPPLEMENTS THEREOF PER THE LOCAL MUNICIPALITY UNLESS SPECIFIED OTHERWISE IN THESE PLANS OR ELSEWHERE IN THE CONTRACT DOCUMENTS.
- THE CONTRACTOR IS TO COMPLY WITH ALL LOCAL STATE, AND FEDERAL LAWS AND REGULATIONS APPLICABLE TO THE CONSTRUCTION COVERED BY THIS PLAN.
- THE CONTRACTOR IS RESPONSIBLE FOR OBTAINING AND COMPLYING WITH ALL PERMITS REQUIRED TO COMPLETE ALL WORK COVERED BY THIS PLAN.
- ALL EXTERIOR SITE LIGHTING SHALL COMPLY WITH THE APPLICABLE REQUIREMENTS FOR TYPE, LOCATION, HEIGHT, WATTAGE, AND LUMEN BASED UPON THE FIXTURES INSTALLED PURSUANT TO SECTION 1023 OF THE TOWN OF PARADISE VALLEY ZONING ORDINANCE FOR NON-HILLSIDE PROPERTIES, SECTION 2208 OF THE TOWN OF PARADISE VALLEY ZONING ORDINANCE FOR HILLSIDE PROPERTIES, OR AS SPECIFIED IN THE SPECIAL USE PERMIT FOR SPECIAL USE PERMIT PROPERTIES.
- A DUST CONTROL PLAN AND PERMIT MEETING THE REQUIREMENTS OF RULE 310 OF THE MARICOPA COUNTY AIR POLLUTION CONTROL REGULATIONS, AS AMENDED, IS REQUIRED.
- A SEPARATE RIGHT-OF-WAY PERMIT IS NECESSARY FOR ANY OFF-SITE CONSTRUCTION.
- AN APPROVED GRADING AND DRAINAGE PLAN SHALL BE ON THE JOB SITE AT ALL TIMES. DEVIATIONS FROM THE PLAN MUST BE PRECEDED BY AN APPROVED PLAN REVISION.
- EAVE PROJECTIONS INTO REQUIRED SETBACKS ARE LIMITED TO A MAXIMUM OF 24" PURSUANT TO SECTION 1008 OF THE TOWN OF PARADISE VALLEY ZONING ORDINANCE.
- ALL STRUCTURES AND LANDSCAPING WITHIN THE SIGHT VISIBILITY TRIANGLE SHALL HAVE A 2 FOOT MAXIMUM HEIGHT.
- ALL NEW AND EXISTING ELECTRICAL SERVICE LINES SHALL BE BURIED PER THE TOWN OF PARADISE VALLEY REQUIREMENTS.
- IT SHALL BE THE RESPONSIBILITY OF THE PERMITTEE TO ARRANGE FOR THE RELOCATION AND RELOCATION COSTS OF ALL UTILITIES, AND TO SUBMIT A UTILITY RELOCATION SCHEDULE PRIOR TO THE ISSUANCE OF AN ENGINEERING CONSTRUCTION PERMIT.
- EXISTING AND/OR NEW UTILITY CABINETS AND PEDESTALS SHALL BE LOCATED A MINIMUM OF 4' BEHIND ULTIMATE BACK OF CURB LOCATION.
- POOL, SPA, BARBEQUE AND ANY PROPOSED STRUCTURES OVER 8' ABOVE GRADE REQUIRE SEPARATE PERMIT APPLICATIONS.
- POOLS SHALL BE CONSTRUCTED BY SEPARATE PERMIT AND SECURED FROM UNWANTED ACCESS PER TOWN CODE, ARTICLE 5-2.
- ALL FILL MATERIAL UNDER SLABS AND WALKS SHALL BE COMPACTED TO NOT LESS THAN 95%.
- SETBACK CERTIFICATION IS REQUIRED AND SHALL BE PROVIDED TO TOWN INSPECTOR PRIOR TO STEM WALL INSPECTION.
- FOR BUILDING PADS THAT HAVE 1 OR MORE OF FILL MATERIAL, SOILS COMPACTION TEST RESULTS ARE REQUIRED AND SHALL BE PROVIDED TO TOWN INSPECTOR PRIOR TO PRE-SLAB INSPECTION.
- FINISHED FLOOR ELEVATION CERTIFICATION IS REQUIRED AND SHALL BE PROVIDED TO TOWN INSPECTOR PRIOR TO FRAMING INSPECTION.
- MAIL BOXES SHALL COMPLY WITH THE TOWN OF PARADISE VALLEY STANDARDS FOR MAIL BOXES IN THE RIGHT-OF-WAY FOR HEIGHT, WIDTH AND BREAK AWAY FEATURES.
- ALL PATIOS, WALKS, AND DRIVES TO SLOPE AWAY FROM BUILDING AND GARAGES AT A MINIMUM SLOPE OF 1/4" PER FOOT UNLESS SPECIFIED OTHERWISE.
- TRENCH BEDDING AND SHADING SHALL BE FREE OF ROCKS AND DEBRIS.
- THE TOWN ONLY APPROVES THE SCOPE OF WORK AND NOT THE ENGINEERING DESIGN. ANY CONSTRUCTION QUANTITIES SHOWN ARE NOT VERIFIED BY THE TOWN.
- THE APPROVAL OF THE PLANS IS VALID FOR 180 DAYS. IF A PERMIT FOR CONSTRUCTION HAS NOT BEEN ISSUED WITHIN 180 DAYS, THE PERMIT MUST BE RE-NEWED.
- A TOWN INSPECTOR WILL INSPECT ALL WORK WITHIN THE TOWN'S RIGHTS-OF-WAY. NOTIFY TOWN INSPECTION SERVICES TO SCHEDULE A PRE-CONSTRUCTION MEETING PRIOR TO STARTING CONSTRUCTION.
- WHENEVER EXCAVATION IS NECESSARY, CALL ARIZONA811 BY DIALING 811 OR 602-263-1100, TWO (2) WORKING DAYS BEFORE EXCAVATION BEGINS.
- EXCAVATIONS SHALL COMPLY WITH REQUIREMENTS OF OSHA EXCAVATION STANDARDS (29 CFR, PART 1926, SUBPART P). UNDER NO CIRCUMSTANCES WILL THE CONTRACTORS BE ALLOWED TO WORK IN A TRENCH LOCATED WITHIN THE TOWN'S RIGHT-OF-WAY WITHOUT PROPER SHORING OR EXCAVATION METHODS.
- PERMIT HOLDER SHALL POST A 6 SQUARE FOOT (2'X3') IDENTIFICATION SIGN, MADE OF DURABLE MATERIAL, IN THE FRONT YARD OF SUBJECT PROPERTY AND NOT IN THE TOWN'S RIGHT-OF-WAY. THE SIGN MAY NOT EXCEED A MAXIMUM OF 6 FEET IN HEIGHT FROM GRADE TO TOP OF THE SIGN. THE SIGN MUST INCLUDE THE PERMITTEE OR COMPANY NAME, PHONE NUMBER, TYPE OF WORK, ADDRESS OF PROJECT AND TOWN CONTACT NUMBER, 480-348-3556.
- WHEN DEEMED NECESSARY, A 6-FOOT HIGH CHAIN LINK FENCE MUST BE INSTALLED AROUND THE CONSTRUCTION AREA TO PREVENT ANY POTENTIAL SAFETY HAZARD FOR THE PUBLIC. THE FENCE SHALL BE SETBACK AT LEAST 10 FEET FROM ALL RIGHTS-OF-WAY AND HAVE A 50-FOOT STREET CORNER SITE TRIANGLE WHERE APPLICABLE.
- CLEAR ACCESS FOR NEIGHBORING PROPERTIES AND EMERGENCY VEHICLES MUST BE MAINTAINED AT ALL TIMES. CONSTRUCTION RELATED VEHICLES MUST BE LEGALLY PARKED ONLY ON ONE SIDE OF THE STREET OR JOB SITE PROPERTY.
- ALL CONSTRUCTION DEBRIS AND EQUIPMENT MUST BE CONTAINED ON SITE AT ALL TIMES. CONTRACTOR AND PROPERTY OWNER MUST MAINTAIN THE JOB SITE FREE OF LITTER AND UNSIGHTLY MATERIALS AT ALL TIMES. CONSTRUCTION MATERIALS ARE PROHIBITED IN THE TOWN'S RIGHT-OF-WAY.
- CONSTRUCTION ACTIVITIES ARE PERMITTED BETWEEN THE HOURS OF 7 AM AND 5 PM MONDAY THROUGH FRIDAY. CONSTRUCTION ACTIVITIES MAY START ONE (1) HOUR EARLIER DURING THE SUMMER (MAY 1ST THROUGH SEPTEMBER 30TH).
- THE USE AND OPERATION OF FUEL-FIRED GENERATORS IS PROHIBITED UNLESS DUE TO A HARDSHIP. TOWN APPROVAL SHALL BE REQUIRED.
- THE CONTRACTOR AND PROPERTY OWNER SHALL BE LIABLE FOR ANY DAMAGE DONE TO ANY PUBLIC PROPERTY AS A RESULT OF ANY CONSTRUCTION OR CONSTRUCTION RELATED ACTIVITIES. NO CERTIFICATE OF OCCUPANCY WILL BE ISSUED UNTIL ALL AFFECTED RIGHTS-OF-WAY ARE CLEANED AND/OR REPAIRED TO THEIR ORIGINAL CONDITION AND UNTIL ANY AND ALL DAMAGES TO AFFECTED PROPERTIES ARE RESTORED TO ORIGINAL CONDITION.
- A KEYSWITCH SHALL BE REQUIRED ON ALL NEW AND EXISTING ELECTRIC ENTRY GATES. THE KEYSWITCH SHALL BE INSTALLED IN A LOCATION THAT IS EASILY VISIBLE AND ACCESSIBLE. KNOX BOX ORDER FORMS ARE AVAILABLE AT THE TOWN'S BUILDING SAFETY DEPARTMENT.
- PROPERTY OWNER, BUILDER, OR GENERAL CONTRACTOR WILL BE RESPONSIBLE FOR CONTROLLING DUST FROM THE SITE AT ALL TIMES. ALL MEANS NECESSARY SHALL BE USED BY THE BUILDER OR GENERAL CONTRACTOR TO CONTROL THE EXISTENCE OF DUST CAUSED BY ANY EARTHWORK, SPRAY APPLICATION OF MATERIALS, OR OTHER DUST-CAUSING PRACTICES REQUIRED BY THE CONSTRUCTION PROCESS.
- APPROVAL OF THESE PLANS ARE FOR PERMIT PURPOSES ONLY AND SHALL NOT PREVENT THE TOWN FROM REQUIRING CORRECTION OF ERRORS IN THE PLANS WHERE SUCH ERRORS ARE SUBSEQUENTLY FOUND TO BE IN VIOLATION OF ANY LAW, ORDINANCE, HEALTH, SAFETY, OR OTHER DESIGN ISSUES.
- ALL DRAINAGE PROTECTIVE DEVICES SUCH AS SWALES, INTERCEPTION DITCHES, PIPES PROTECTIVE BERMS, CONCRETE CHANNELS OR OTHER MEASURES DESIGNED TO PROTECT PROPOSED AND EXISTING IMPROVEMENTS FROM RUNOFF OR DAMAGE FROM STORM WATER, MUST BE CONSTRUCTED PRIOR TO THE CONSTRUCTION OF ANY IMPROVEMENTS.

ENGINEERS NOTES

- MARICOPA ASSOCIATION OF GOVERNMENTS (M.A.G.) UNIFORM STANDARD SPECIFICATIONS AND DETAILS FOR PUBLIC WORKS CONSTRUCTION (LATEST EDITION INCLUDING LATEST REVISION AND CURRENT SUPPLEMENTS THEREOF PER THE LOCAL TOWN OR CITY) ARE INCORPORATED INTO THIS PLAN IN THEIR ENTIRETY.
- ALL WORK REQUIRED TO COMPLETE THE CONSTRUCTION COVERED BY THIS PLAN SHALL BE IN ACCORDANCE WITH THE M.A.G. STANDARD SPECIFICATIONS AND DETAILS AND CURRENT SUPPLEMENTS THEREOF PER THE LOCAL CITY OR TOWN UNLESS SPECIFIED OTHERWISE IN THESE PLANS OR ELSEWHERE IN THE CONTRACT DOCUMENTS. CONTRACTORS SHALL FAMILIARIZE THEMSELVES WITH ALL REQUIRED STANDARD SPECIFICATIONS, DETAILS AND SUPPLEMENTS PRIOR TO BIDDING THE WORK FOR THE CONSTRUCTION COVERED BY THIS PLAN.
- GRADING SHALL BE IN CONFORMANCE WITH 2012 I.B.C. SEC. 1803 AND APPENDIX J.
- 5% MINIMUM SLOPE AWAY FROM BUILDING FOR A MINIMUM 10', U.N.O.
- ALL CONSTRUCTION SHALL CONFORM TO THE LATEST MARICOPA ASSOCIATION OF GOVERNMENTS (M.A.G.) SPECIFICATIONS AND STANDARD DETAILS.
- A DUST CONTROL PLAN MEETING THE REQUIREMENTS OF RULE 310 OF THE MARICOPA COUNTY AIR POLLUTION CONTROL REGULATIONS, AS AMENDED, IS REQUIRED.
- A SEPARATE PERMIT IS NECESSARY FOR ANY OFFSITE CONSTRUCTION.
- AN APPROVED GRADING AND DRAINAGE PLAN SHALL BE ON THE JOB SITE AT ALL TIMES. DEVIATIONS FROM THE PLAN MUST BE PRECEDED BY AN APPROVED PLAN REVISION.
- ALL DRAINAGE PROTECTIVE DEVICES SUCH AS SWALES, INTERCEPTOR DITCHES, PIPES, PROTECTIVE BERMS, BARRIER WALLS, CONCRETE CHANNELS OR OTHER MEASURES DESIGNED TO PROTECT ADJACENT BUILDINGS OR PROPERTY FROM STORM RUNOFF MUST BE COMPLETED PRIOR TO BUILDING CONSTRUCTION.
- ALL STRUCTURES AND LANDSCAPING WITHIN THE SIGHT VISIBILITY TRIANGLE SHALL HAVE A 2 FOOT MAXIMUM HEIGHT.
- ALL PATIOS, WALKS, AND DRIVES TO SLOPE AWAY FROM BUILDING AND GARAGES AT A MINIMUM SLOPE OF 1/4" PER FOOT UNLESS SPECIFIED OTHERWISE. ALL LAWN AREAS ADJOINING WALKS OR SLABS WILL BE GRADED TO 2" BELOW THE TOP OF SLAB. TYPICAL FINISHED GRADE AROUND PERIMETER OF BUILDING IS MINUS 6" BELOW FINISHED FLOOR UNLESS SPECIFIED OTHERWISE.
- ALL MATERIAL TO BE UNDER SLABS AND WALKS SHALL BE COMPACTED TO NOT LESS THAN 95% PER ASTM D698.
- THE QUANTITIES AND SITE CONDITIONS DEPICTED IN THESE PLANS ARE FOR INFORMATIONAL PURPOSES ONLY AND ARE SUBJECT TO ERROR AND OMISSION. CONTRACTORS SHALL SATISFY THEMSELVES AS TO ACTUAL QUANTITIES AND SITE CONDITIONS PRIOR TO BIDDING THE WORK FOR THE CONSTRUCTION COVERED BY THIS PLAN.
- THE CONTRACTOR IS RESPONSIBLE FOR OBTAINING AND COMPLYING WITH ALL PERMITS REQUIRED TO COMPLETE ALL WORK COVERED BY THIS PLAN.
- THE CONTRACTOR IS RESPONSIBLE FOR ALL METHODS, SEQUENCING, AND SAFETY CONCERNS ASSOCIATED WITH THIS PROJECT DURING CONSTRUCTION, UNLESS SPECIFICALLY ADDRESSED OTHERWISE IN THIS PLAN OR ELSEWHERE.
- A REASONABLE EFFORT HAS BEEN MADE TO SHOW THE LOCATIONS OF EXISTING UNDERGROUND FACILITIES AND UTILITIES IN THE CONSTRUCTION AREA. THE CONTRACTOR IS RESPONSIBLE FOR ANY DAMAGE TO UTILITIES AND/OR UTILITIES CAUSED DURING THEIR CONSTRUCTION OPERATIONS. THE CONTRACTOR SHALL CALL 48 HOURS IN ADVANCE FOR BLUE STAKE (1-800-STAKE-IT) PRIOR TO ANY EXCAVATION.
- THE CONTRACTOR IS RESPONSIBLE FOR ALL COORDINATION OF CONSTRUCTION AFFECTING UTILITIES AND THE COORDINATION OF ANY NECESSARY UTILITY RELOCATION WORK.
- ALL PAVING, GRADING, EXCAVATION, TRENCHING, PIPE BEDDING, CUT, FILL AND BACKFILL SHALL COMPLY WITH THE RECOMMENDATIONS SET FORTH IN THE SOILS (GEO-TECHNICAL) REPORT FOR THIS PROJECT IN ADDITION TO THE REFERENCED REQUIRED SPECIFICATIONS AND DETAILS.
- THE CONTRACTOR IS TO VERIFY THE LOCATION AND THE ELEVATIONS OF ALL EXISTING UTILITIES AT POINTS OF TIE-IN PRIOR TO COMMENCING ANY NEW CONSTRUCTION. SHOULD ANY LOCATION OR ELEVATION DIFFER FROM THAT SHOWN ON THESE PLANS, THE CONTRACTOR SHALL CONTACT THE OWNER'S AGENT.
- CONTRACTOR TO VERIFY AND COORDINATE ALL DIMENSIONS AND SITE LAYOUT WITH ARCHITECTURE'S FINAL SITE PLAN AND FINAL BUILDING DIMENSIONS BEFORE STARTING WORK. REPORT DISCREPANCIES TO OWNER'S AGENT.
- COORDINATION BETWEEN ALL PARTIES IS ESSENTIAL PART OF CONTRACT.
- CONTRACTOR IS RESPONSIBLE FOR PROJECT AND SITE CONDITIONS, AND TO WORK WITH WEATHER CONDITIONS AS THE PROJECT SITE MAY BE LOCATED IN A FLOOD PRONE AREA AND SUBJECT TO FLOODING AND ITS HAZARDS.
- THE CONTRACTOR IS TO VERIFY THE LOCATION, ELEVATION, CONDITION, AND PAVEMENT CROSS-SLOPE OF ALL EXISTING SURFACES AT POINTS OF TIE-IN AND MATCHING, PRIOR TO COMMENCEMENT OF GRADING, PAVING, CURB AND GUTTER, OR OTHER SURFACE CONSTRUCTION. SHOULD EXISTING LOCATIONS, ELEVATIONS, CONDITION, OR PAVEMENT CROSS-SLOPE DIFFER FROM THAT SHOWN ON THESE PLANS, RESULTING IN THE DESIGN INTENT REFLECTED ON THESE PLANS NOT ABLE TO BE CONSTRUCTED, THE CONTRACTOR SHALL NOTIFY THE OWNER'S AGENT IMMEDIATELY FOR DIRECTION ON HOW TO PROCEED PRIOR TO COMMENCEMENT OF CONSTRUCTION. THE CONTRACTOR ACCEPTS RESPONSIBILITY FOR ALL COSTS ASSOCIATED WITH CORRECTIVE ACTION IF THESE PROCEDURES ARE NOT FOLLOWED.
- CONTRACTOR IS RESPONSIBLE TO COORDINATE UTILITY CROSSINGS AT CULVERT CROSSINGS BEFORE STARTING WORK ON CULVERT. COORDINATE WITH OWNER REPRESENTATIVE. VERIFY UTILITY LINES AND/OR CONDUITS ARE IN PLACE BEFORE STARTING CULVERT WORK.
- ALL ON-SITE UTILITIES PER OTHERS.
- THIS PROJECT REQUIRES A REGULAR ONGOING MAINTENANCE PROGRAM FOR THE DESIGNED DRAINAGE SYSTEM(S) TO PRESERVE THE DESIGN INTEGRITY AND THE ABILITY TO PERFORM ITS OPERATIONAL INTENT. FAILURE TO PROVIDE MAINTENANCE WILL JEOPARDIZE THE DRAINAGE SYSTEM(S) PERFORMANCE AND MAY LEAD TO ITS INABILITY TO PERFORM PROPERLY AND/OR CAUSE DAMAGE ELSEWHERE IN THE PROJECT.
- IF A DISCREPANCY IS FOUND BETWEEN ENGINEER'S PLAN OR SURVEYOR'S STAKING AND THE ARCHITECTURAL PLAN, ENGINEER SHALL BE NOTIFIED IMMEDIATELY. FAILURE TO NOTIFY ENGINEER SHALL NEGATE ENGINEER'S LIABILITY.
- ALL DISTURBED AREAS ARE TO BE ROPED AND ROPING MUST MATCH PLAN.
- VEGETATION OUTSIDE OF CONSTRUCTION AREA TO REMAIN.
- AREAS OUTSIDE THE WALL AND CUT AND FILL SLOPES SHALL BE REVEGETATED WITH SIMILAR PLANT TYPES AND DENSITIES FOUND ON THE SITE. REVEGETATION SHALL BE COMPLETED PRIOR TO OCCUPANCY AND THE ISSUANCE OF A CERTIFICATE OF OCCUPANCY.
- MECHANICAL EQUIPMENT SHALL BE SCREENED TO A MINIMUM OF ONE FOOT ABOVE TOP OF EQUIPMENT.
- ANY FUTURE IMPROVEMENTS SHOWN HEREON SHALL REQUIRE A SEPARATE PERMIT.
- ANY POINTS OF DRAINAGE CONCENTRATION SHOULD BE PROTECTED AGAINST EROSION WITH NATIVE STONE.
- THIS PLAN IS DESIGNED TO SHOW SITE GRADING AND DRAINAGE. CONTRACTOR SHALL USE THE ARCHITECTURAL SITE PLAN TO DETERMINE FINAL HOUSE, WALL, STEP, ETC., LOCATIONS AND ELEVATIONS.
- ALL DRAINAGE FACILITIES TO BE MAINTAINED BY HOMEOWNER.
- SEE ARCHITECTURAL AND STRUCTURAL PLANS FOR SITE AND RETAINING WALLS LAYOUT, DIMENSIONS, AND DETAILS. TOP OF FOOTING ELEVATIONS SHOWN IN PLAN ARE APPROXIMATE ONLY. ACTUAL TOP OF FOOTINGS TO BE DETERMINED AT TIME OF CONSTRUCTION AND TO BE A MINIMUM OF SIX INCHES BELOW EXISTING NATURAL GRADE OR FINISHED GRADE WHICHEVER IS LOWER (TYPICAL).
- REFER TO ARCHITECTURAL DRAWINGS FOR BUILDING LAYOUT, DIMENSIONS AND ELEVATIONS.
- REFER TO STRUCTURAL DRAWINGS, DETAILS AND CALCULATIONS FOR ALL PROPOSED RETAINING WALLS.
- FOR CHANGE IN ELEVATION THAT ARE GREATER THAN 30", PROVIDE 36" HIGH GUARDRAILS FOR TOTAL OF 42" FALL PROTECTION BARRIER U.N.O.
- CONTRACTOR TO PROVIDE POSITIVE DRAINAGE AWAY FROM STRUCTURE - 5% MIN SLOPE FOR FIRST 10 FEET, U.N.O.
- ALL WATER AND SEWER LINES AND CONNECTIONS MUST BE INSTALLED PER IPC 2012, MAG AND TOWN OF PARADISE VALLEY SUPPLEMENT TO MAG.
- WATERPROOF ALL EXTERIOR WALLS 18" ABOVE FINISH GRADE--(BITUTHENE@ 3000 HC MEMBRANE W/ GRAPE PROTECTION 03 OR APPROVED EQUAL).
- ALL PIPES AND FITTINGS SHALL BE INSTALLED PER MANUFACTURE'S SPECIFICATIONS AND DETAILS.
- ABANDONMENT OF EXISTING AND INSTALLATION OF NEW SEPTIC SYSTEMS SHALL BE PERFORMED IN ACCORDANCE WITH THE MARICOPA COUNTY ENVIRONMENTAL SERVICES DEPARTMENT RULES AND STANDARDS, AND WILL REQUIRE SEPARATE PERMIT.
- COORDINATE RIPRAP COLOR WITH LANDSCAPE PLANS AND DETAILS.
- VERIFY AND COORDINATE WITH LANDSCAPE PLANS FINAL LOCATION AND GRATE TYPE OF SPECIFIED AREA DRAINS AND TRENCH DRAINS.
- VERIFY AND COORDINATE WITH ARCHITECTURAL AND LANDSCAPE PLANS LOCATION AND HEIGHT OF ALL SITE WALLS.
- DISTURBED AREA: TOTAL ACRES = 0.5 ACRES < 1 ACRE; NPDES PERMIT IS NOT REQUIRED.
- REFER TO ARCHITECTURAL PLANS AND DETAILS FOR DEMOLITION AND REMOVAL OF ANY EXISTING BUILDING STRUCTURES, SITE WALLS, POOL AND PAVEMENT ETC.
- REFER TO GEOTECHNICAL REPORT FOR SPECIFIC RECOMMENDATIONS AND MAXIMUM ALLOWED FILL AND CUT SLOPES.

LEGEND

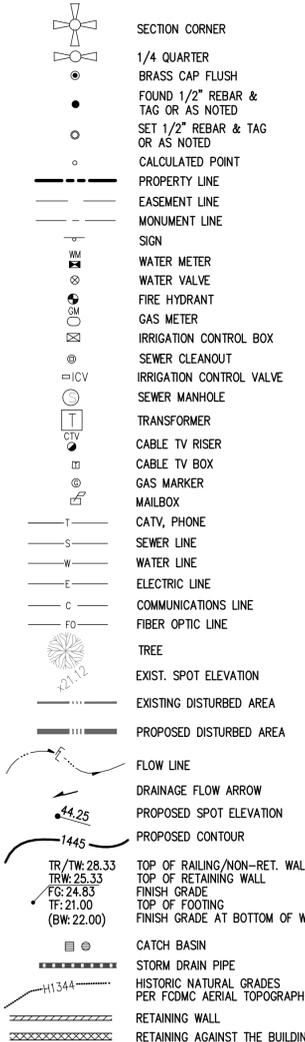

ABBREVIATIONS

- BC BACK OF CURB
- BSL BUILDING SETBACK LINE
- BW BOTTOM OF WALL
- C11 CURVE LABEL
- C CONCRETE, CALCULATED
- & CENTERLINE
- TPV TOWN OF PARADISE VALLEY DRAINAGE EASEMENT
- DE EASEMENT
- EX EXISTING
- EX1 EXIST.
- EG EXISTING GRADE
- FG FINISH GRADE
- FFE FINISH FLOOR ELEVATION
- ℓ FLOW LINE
- FND FOUND
- G GUTTER, GAS
- INV INVERT
- L11 LINE LABEL
- MAG MARICOPA ASSOCIATION OF GOVERNMENTS MEASURED
- MCR MARICOPA COUNTY RECORDER
- P PAVEMENT
- PUE PUBLIC UTILITY EASEMENT
- (R) RECORDED
- R RADIUS
- R/W RIGHT OF WAY
- T TANGENT, TELEPHONE
- W WEST, WATERLINE
- TP TOP OF PARAPET
- TC TOP OF CURB
- TG TOP OF GRADE
- TF TOP OF FOOTING
- TR TOP OF RAILING
- TRW TOP OF RETAINING WALL
- TW TOP OF WALL
- WM WATER METER

DISTURBED AREA CALCULATIONS

AREA OF LOT:	44,542 S.F. (1.0225 AC.)
TOTAL FLOOR AREA:	6,267 S.F.
FLOOR AREA RATIO:	14.07% < 25%
(TOTAL FLOOR AREA/AREA OF LOT)	
BUILDING PAD SLOPE:	12.5%
VERTICAL:	17 FT
HORIZONTAL:	136 FT
ALLOWABLE NET DISTURBED AREA:	20,213 S.F. (45.38%)
EXISTING GROSS DISTURBED AREA:	18,846 S.F.
LESS EXISTING BUILDING FOOTPRINT:	3,668 S.F.
EXISTING NET DISTURBED AREA:	15,178 S.F. (34.1%)

PROPOSED GROSS DISTURBED AREA: 19,381 S.F.
LESS TEMPORARY AREAS OF DISTURBANCE TO BE RESTORED AND REVEGETATED: 0 S.F.

LESS 25% CREDIT FOR NEW PAVERS RESURFACED D/W OVER 6" AND UNDER 18" OF NATURAL GRADE: 3,316 S.F.*0.25=829 S.F.

LESS BUILDING FOOTPRINT AREA: 4,694 S.F.
PROPOSED NET DISTURBED AREA: 13,858 S.F. < 20,213 S.F.

ALLOWED SLOPES STEEPER THAN NATURAL GRADE (5% MAX.): 2,227 S.F. (5%)
PROPOSED SLOPES STEEPER THAN NATURAL GRADE (AREA): 2,092 S.F. (4.7%)

EARTHWORK BASED ON HISTORIC VACANT SITE CONDITION:
VOLUME OF CUT: 3,369 C.Y.
VOLUME OF FILL: 8 C.Y.
TOTAL OUTFALL: 3,377 C.Y.

GRADING PERMIT FEE: \$3,255.15
HILLSIDE ASSURANCE @ 35 TIMES GRADING PERMIT FEE: \$113,930.25

ALL QUANTITIES LISTED ON THESE PLANS ARE ESTIMATES ONLY. THE CONTRACTOR SHALL MAKE THEIR OWN DETERMINATION OF THE QUANTITIES AND BASE THEIR BIDS ON THEIR ESTIMATES.

EARTHWORK QUANTITIES (CURRENT CONDITION)

CUT: 331 C.Y.
FILL: 108 C.Y.
NET CUT: 223 C.Y.

ALL QUANTITIES LISTED ON THESE PLANS ARE ESTIMATES ONLY. NO SHRINK OR SWELL IS ASSUMED. THE CONTRACTOR SHALL MAKE THEIR OWN DETERMINATION OF THE QUANTITIES AND BASE THEIR BIDS ON THEIR ESTIMATES.

UTILITIES NOTES

HORIZONTAL AND VERTICAL LOCATIONS OF ALL EXISTING UTILITIES SHOWN ON THE PLAN ARE APPROXIMATE ONLY AND WILL BE FIELD VERIFIED BY CONTRACTOR PRIOR TO START OF CONSTRUCTION WORK. CALL BLUE STAKE @ (602) 263-1100.

FIRE SPRINKLER SYSTEM

FIRE SPRINKLER SYSTEM TO BE INSTALLED PER THE REQUIREMENTS OF THE TOWN OF PARADISE VALLEY AND IN ACCORDANCE WITH I.B.C. SECT. 904.2.2.2 AMD. AND I.F.C. SECT. 1003.2.1 AMD.

FLOOD INSURANCE RATE MAP (FIRM) DATA

COMMUNITY #	PANEL #	SUFFIX	BASED FLOOD ELEVATION
040049	1765 OF 4425	L	N/A
MAP #	PANEL DATE	ZONE	
04013C	10/16/2013	X*	

*AREAS DETERMINED TO BE OUTSIDE THE 0.2% ANNUAL CHANCE FLOODPLAIN;

ON-SITE RETENTION FOR THE PRE VS. POST DEVELOPMENT RUNOFF FROM 100-YEAR, 2-HOUR STORM EVENT					
V=DxAx(Cpost-Cpre)/12=(0.95-0.80) D=RAINFALL DEPTH=2.82" A=TRIBUTARY AREA, SF Cw=WEIGHTED RUNOFF COEFFICIENT					
DRAINAGE AREA	AREA S.F.	RUNOFF COEFFICIENT Cw	VOLUME REQUIRED C.F.	RETENTION TYPE	VOLUME PROVIDED C.F.
A	5,206 *	0.15	184	28' LONG (36" DIA) UNDERGROUND STORM WATER STORAGE	197
B	3,560 *	0.15	125	18' LONG (36" DIA) UNDERGROUND STORM WATER STORAGE	127
C	3,187 **	0.15	112	(1) - 9' DEEP (48" DIA) DRYWELL	113
TOTAL			421		437

*HARDSCAPE AND ROOF ONLY
**DRIVEWAY ONLY

HISTORIC EARTHWORK QUANTITIES

CUT: 3975 C.Y.
FILL: 9 C.Y.
NET CUT: 3966 C.Y.

ALL QUANTITIES LISTED ON THESE PLANS ARE ESTIMATES ONLY. NO SHRINK OR SWELL IS ASSUMED. THE CONTRACTOR SHALL MAKE THEIR OWN DETERMINATION OF THE QUANTITIES AND BASE THEIR BIDS ON THEIR ESTIMATES.

LEGAL DESCRIPTION

LOT 18 AS SHOWN ON THE PLAT OF STONE CANYON EAST RECORDED IN BOOK 81 OF MAPS, PAGE 34, MARICOPA COUNTY RECORDERS OFFICE.

BENCHMARK

BRASS CAP IN HANDHOLE LOCATED AT THE INTERSECTION OF MCDONALD DRIVE AND N. 56TH STREET SAID POINT ALSO BEING THE N.E. CORNER SECTION 17, T. 2N., R. 4E., G.&S.R.B.&M.;

ELEVATION = 1417.53 TOWN OF PARADISE VALLEY DATUM

T.B.M.: BRASS CAP FLUSH LOCATED AT A POINT OF TANGENCY ALONG E. SOLANO DRIVE CENTERLINE NORTH OF LOT 18 OF STONE CANYON EAST, SHOWN HEREON.

BASIS OF BEARINGS

CENTERLINE OF EAST SOLANO DRIVE WHICH BEARS S58°30'51"E AS SHOWN ON THE PLAT OF STONE CANYON EAST RECORDED IN BOOK 81 OF MAPS, PAGE 34, M.C.R.

DRAINAGE STATEMENT

- ULTIMATE STORM OUTFALL IS LOCATED AT THE NORTHWEST PROPERTY LINE AT ELEVATION OF 1466.70.
- A NEW SINGLE FAMILY RESIDENCE IS PROPOSED FOR THIS SITE.
- PROPOSED DEVELOPMENT DOES NOT IMPACT DRAINAGE CONDITIONS OF ADJOINING LOTS.
- HISTORIC DRAINAGE PATTERNS ARE PRESERVED.
- ONSITE RETENTION IS PROVIDED FOR THE PRE VS. POST RUNOFF.
- THE MINIMUM FINISH FLOOR ELEVATIONS SHOWN ARE SAFE FROM INUNDATION DURING A 100-YEAR PEAK RUN-OFF EVENT IF CONSTRUCTED PER APPROVED PLANS.

GRADING SPECIFICATIONS

- EXCAVATION AND GRADING OF THIS SITE IS CLASSIFIED AS "ENGINEERED GRADING" PER 2015 I.B.C. AND WILL BE PERFORMED ACCORDINGLY.
- THE CONTRACTOR WILL RETAIN A SOILS ENGINEER DURING CONSTRUCTION TO INSPECT PROGRESS OF CONSTRUCTION, INCLUDING PREPARATION OF GRADE TO RECEIVE FILLS, TESTING AND REQUIRED COMPACTION STABILITY OF ALL FINISH SLOPES INCLUDING CUT SLOPES.
- CONTRACTOR SHALL COMPLY WITH M.A.G. SECTION 601 AND PROVISIONS AS SET FORTH IN THE APPROVED GEOTECHNICAL REPORTS.
- CUT AND FILL SLOPES SHALL BE PER THE APPROVED GEOTECHNICAL REPORT.
- ANY RETAINING WALLS ADJACENT TO THE PROPERTY LINES WILL BE UNDER THE SCOPE OF SPECIAL INSPECTION BY THE SOILS ENGINEER. THE DEVELOPER SHALL NOTIFY THE ADJOINING PROPERTY OWNERS IN WRITING, TEN DAYS PRIOR TO START OF CONSTRUCTION ON THESE WALLS PER SECTION 2903-B OF I.B.C. THE DEVELOPER WILL HAVE TO PROVIDE MEANS OF PROTECTION OF ADJACENT PROPERTY WHILE THIS WORK IS UNDER CONSTRUCTION.
- THE USE OF HYDRAULIC RAM HAMMERS AND HEAVY EQUIPMENT SHALL BE LIMITED TO USE BETWEEN THE HOURS OF 7:00AM AND 6:00PM MONDAY THROUGH SATURDAY WITH NO WORK ON SUNDAY.
- GEOTECHNICAL ENGINEER SHALL INSPECT AND ACCEPT THE INTEGRITY OF THE EXISTING ROCK CUTS AND ANCHORS.

OWNER

TONN INVESTMENTS, L.L.C.
4350 E. CAMELBACK RD.
PHOENIX, AZ. 85018
PHONE: 602-684-1000
CONTACT: SCOTT TONN
EMAIL: STONN@TONN.COM

SITE DATA

APN: 172-47-063
ADDRESS: 5429 E SOLANO DRIVE
PARADISE VALLEY, AZ 85253
ZONING: R-43 (HILLSIDE)
LOT AREA: 44,542 S.F. (1.0225 AC.)

ARCHITECT

A-I-R, INC.
7610 E MCDONALD DR., SUITE K,
SCOTTSDALE, AZ 85250
P: 480 329 1888

LAND SURVEYOR

SITE CONSULTANTS, INC.
113 S ROCKFORD DR
TEMPE, AZ 85281
P: 480 894 2820

SHEET INDEX

SHEET C-1 - COVER SHEET
SHEET C-2 - OVERALL SITE TOPOGRAPHY HISTORIC CONTOURS DISTURBANCE CALCULATIONS DETAILS
SHEET C-3 - GRADING & DRAINAGE PLAN

UTILITIES

WATER: EPOR WATER
SANITARY SEWER: SEPTIC
ELECTRIC: ARIZONA PUBLIC SERVICE
TELEPHONE: CENTURY LINK, COX COMMUNICATIONS
NATURAL GAS: SOUTHWEST GAS
CABLE TV: CENTURY LINK, COX COMMUNICATIONS

APPROVAL

TOWN ENGINEER _____ DATE _____
TOWN OF PARADISE VALLEY

TOWN OF PARADISE VALLEY GENERAL HILLSIDE NOTES

- NO CERTIFICATE OF OCCUPANCY SHALL BE ISSUED UNTIL ALL HILLSIDE STIPULATIONS AND ALL TOWN CODE REQUIREMENTS ARE COMPLIED INCLUDING, BUT NOT LIMITED TO LANDSCAPING, GROUND RESTORATION, FIRE FLOW, FIRE SAFETY AND ALL ONSITE AND OFFSITE IMPROVEMENTS.
- ALL OUTDOOR LIGHTING SHALL BE IN CONFORMANCE WITH ARTICLE XXI OF THE TOWN ZONING ORDINANCE.
- ALL EXCESS FILL MATERIAL SHALL BE REMOVED FROM THE SITE WITH NO NEW SPILL SLOPES.
- THE USE OF HYDRAULIC RAM HAMMERS, OR OTHER HEAVY EQUIPMENT USED TO CUT THROUGH ROCK, INCLUDING MACHINERY WITH AUDIBLE BACK UP WARNING DEVICES SHALL BE LIMITED TO USE BETWEEN THE HOURS OF 7:00AM OR SUNRISE, WHICHEVER IS LATER, AND 6:00PM OR SUNSET, WHICHEVER IS EARLIER, MONDAY THROUGH FRIDAY, WITH LIMITED WORK ON SATURDAY AND NO WORK ON SUNDAY OR LEGAL HOLIDAYS. RAM HAMMERS AND OTHER HEAVY EQUIPMENT CANNOT BE USED ON SATURDAYS WITHOUT A WAIVER FROM THE TOWN MANAGER.
- CONSTRUCTION STAKING AND /OR FENCING SHALL BE PLACED AROUND THE CONSTRUCTION SITE SO AS TO PROTECT THE UNDISTURBED NATURAL AREA.
- ALL RETAINING WALLS SHALL NOT EXTEND MORE THAN 6 INCHES ABOVE THE MATERIAL THEY RETAIN (WITH EXCEPTION OF DRIVEWAY RETAINING WALLS IN ACCORDANCE WITH 2207.V.6).

DATE:	11/26/18
DESIGNED BY:	NP
DRAWN BY:	CM
CHECKED BY:	JJ
DATE:	
SCALE:	N.T.S.
REVISIONS:	


PRELIMINARY GRADING & DRAINAGE PLAN COVER SHEET
TONN RESIDENCE 5429 E SOLANO DR., PARADISE VALLEY, AZ 85253

P. 602.889.1984 | F. 602.445.9482
8800 N CENTRAL AVE., SUITE 288
PHOENIX, AZ 85020
phoenix@diging.com

Call 811 or click Arizona811.com

Land DEVELOPMENT GROUP

C-1

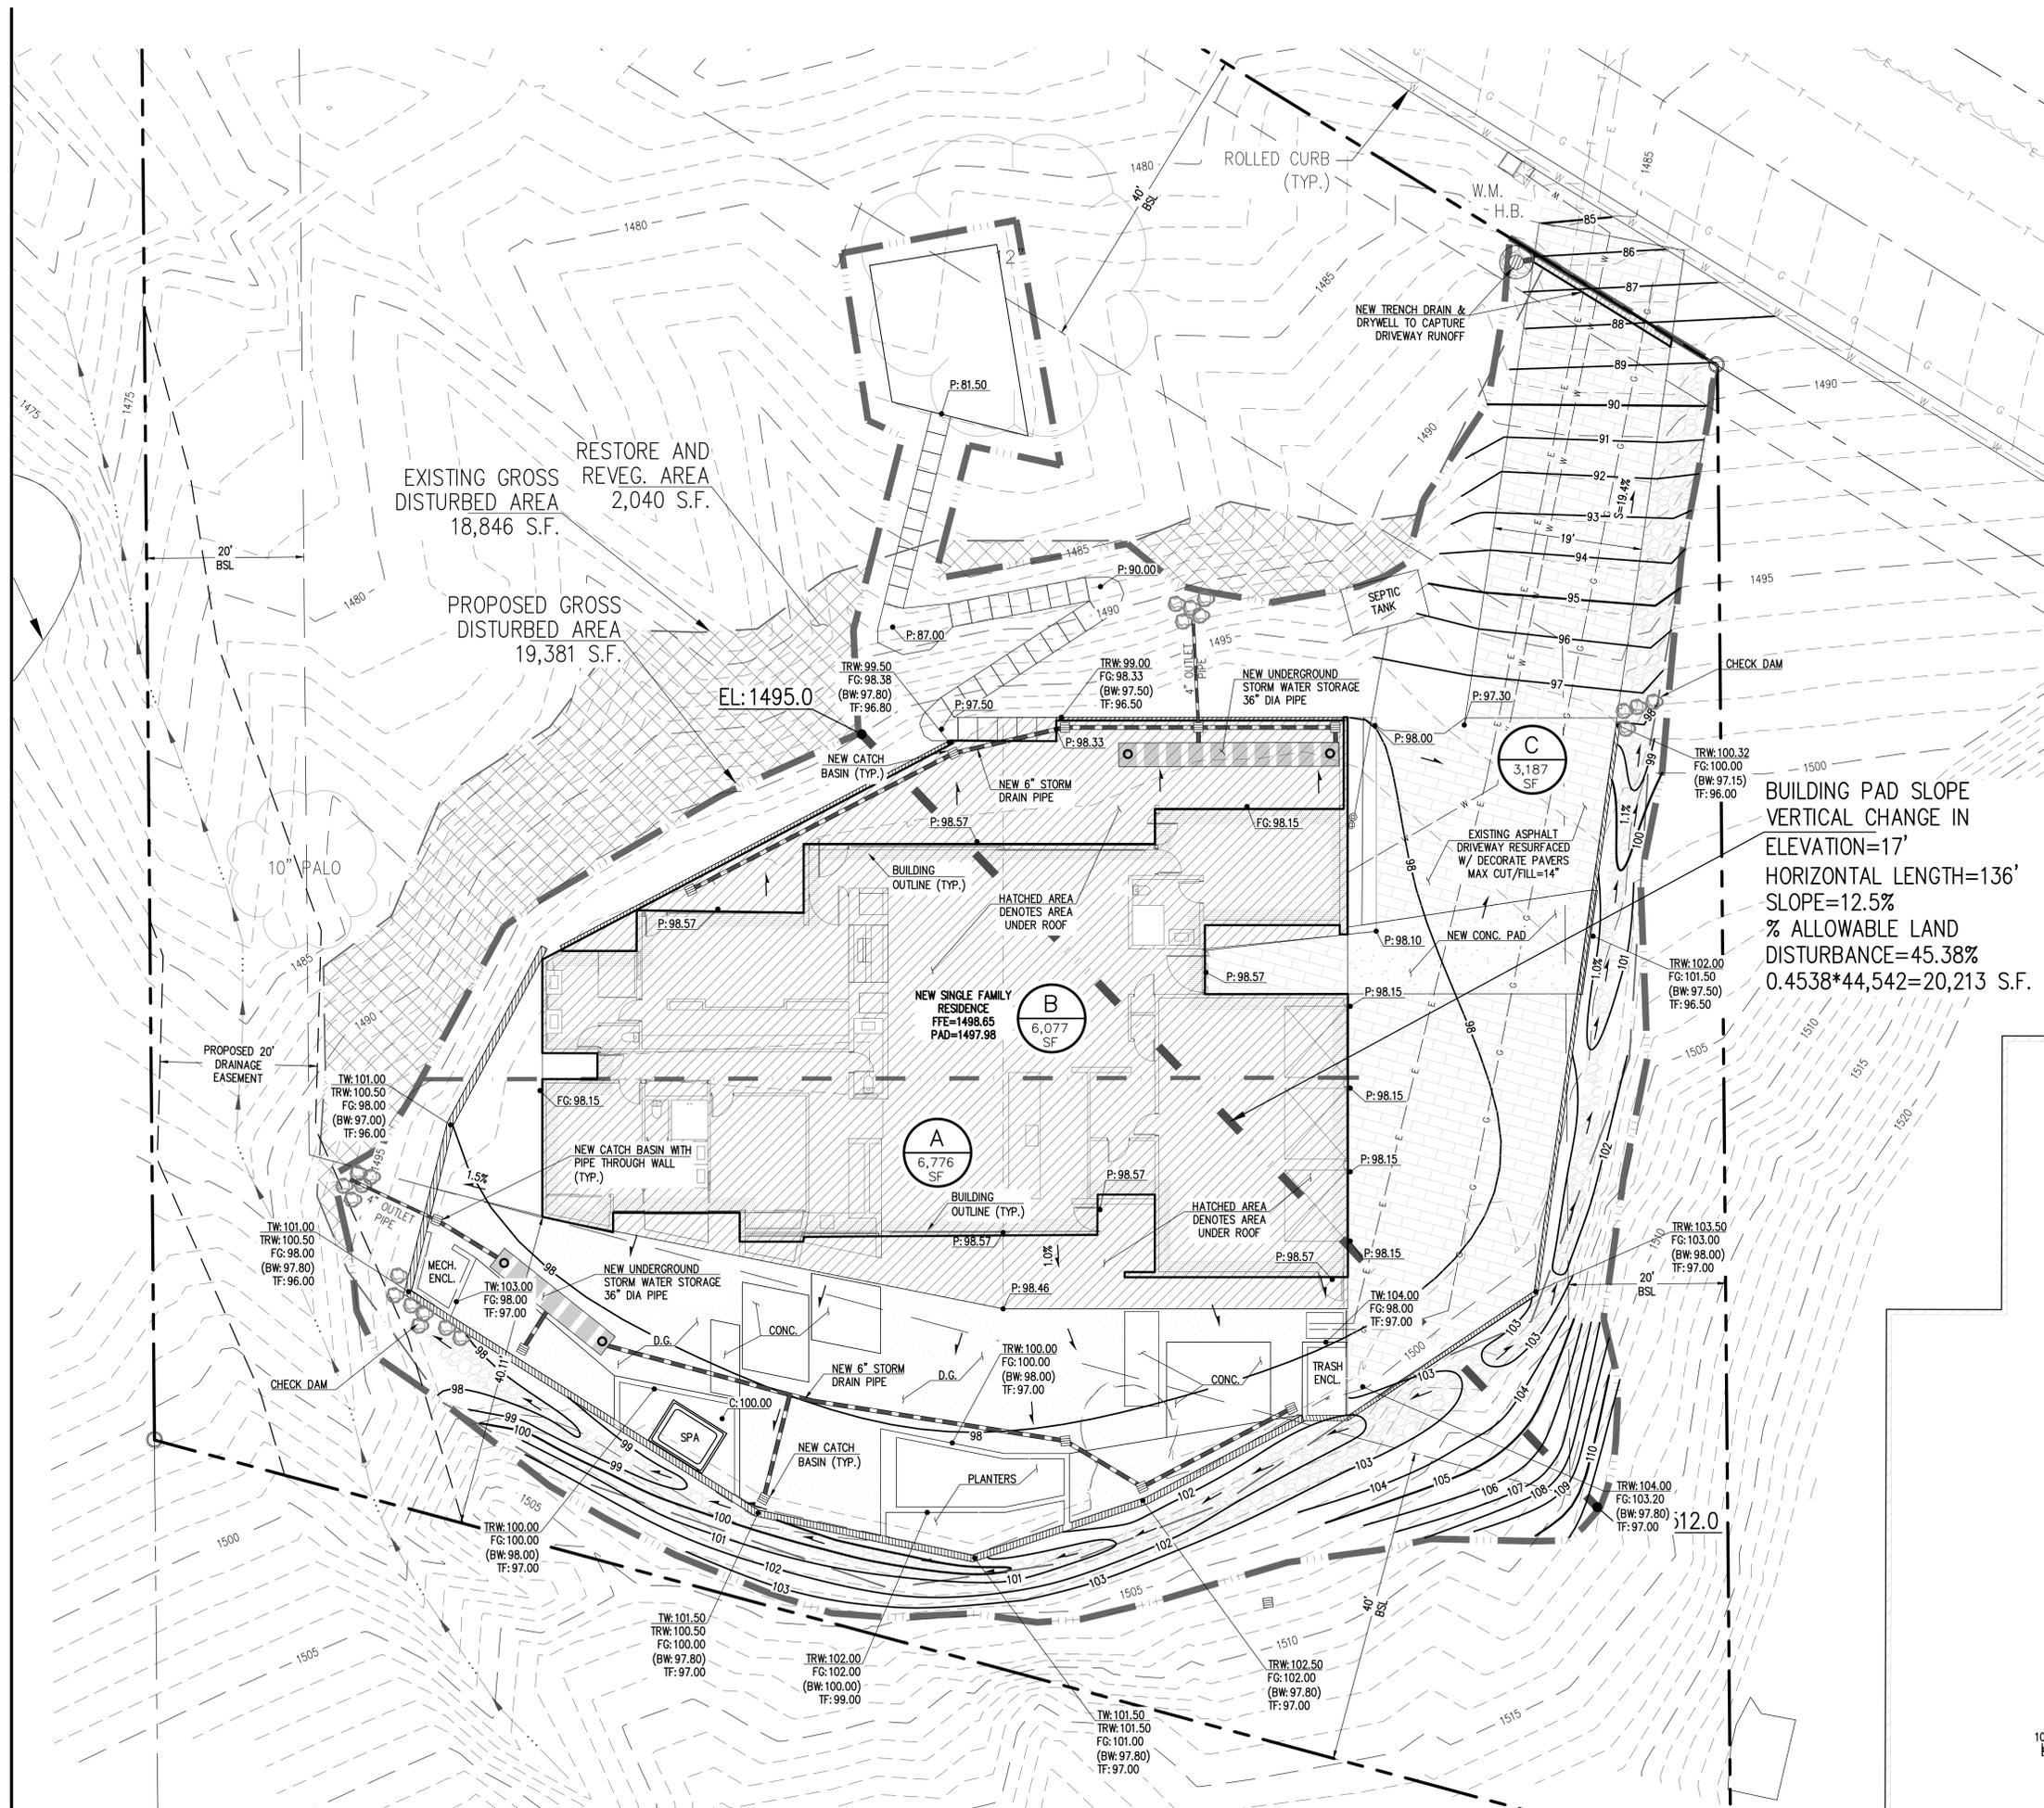

RESTORE AND REVEG. AREA
EXISTING GROSS DISTURBED AREA 18,846 S.F.
2,040 S.F.

PROPOSED GROSS DISTURBED AREA
19,381 S.F.

BUILDING PAD SLOPE
VERTICAL CHANGE IN ELEVATION=17'
HORIZONTAL LENGTH=136'
SLOPE=12.5%
% ALLOWABLE LAND DISTURBANCE=45.38%
 $0.4538 \times 44,542 = 20,213$ S.F.


DISTURBED AREA CALCULATIONS

AREA OF LOT:	44,542 S.F. (1.0225 AC.)
TOTAL FLOOR AREA:	6,267 S.F.
FLOOR AREA RATIO: (TOTAL FLOOR AREA/AREA OF LOT)	14.07% < 25%
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TOTAL CUT&FILL: 3,377 C.Y.
GRADING PERMIT FEE: \$3,255.15
HILLSIDE ASSURANCE @ 35 TIMES GRADING PERMIT FEE: \$113,930.25
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ELEVATION NOTE

ADD 1400' TO ALL PROPOSED GRADING ELEVATIONS TO ACHIEVE FULL TOPO DATUM.



DATE:	11/26/18
JOB:	151217
VERSION:	2.1
PLOT DATE:	11/26/18
SCALE:	1"=10'
DESIGNED BY:	NP
DRAWN BY:	CM
CHECKED BY:	J

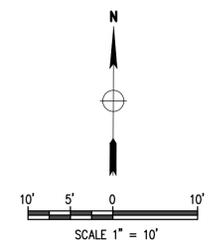PRELIMINARY GRADING & DRAINAGE PLAN IMPROVEMENT PLAN

**TOWN RESIDENCE
5429 E SOLANO DR.,
PARADISE VALLEY, AZ 85253**

P. 602.889.0984 | F. 602.445.9482
8808 N CENTRAL AVE., SUITE 288
PHOENIX, AZ 85020
phoenix@ldg.com

Arizona 811 logo with text: "Call 811 or click Arizona811.com"



GENERAL NOTES

- A ALL EXTERIOR MATERIAL PALETTE SHALL BE IN ACCORDANCE WITH SECTION 2207 II.D.
- B ALL EXTERIOR LIGHTING SHALL COMPLY WITH SECTION 2208.

KEYNOTES

- 01 ROOF - 12" WIDE COPPER FLAT SEAM PANEL
- 02 EXISTING DRIVEWAY - TO BE REPLACED WITH DECORATIVE PAVERS
- 03 EXISTING POOL - TO BE DEMOLISHED
- 04 PROPOSED STAIRS
- 05 NEW HOT TUB
- 06 EXISTING RETAINING WALL - TO REMAIN
- 07 MECHANICAL ENCLOSURE - 4'-0" ABOVE GRADE
- 08 PROPOSED PATIO - HIGHEST POINT = 1'-8" ABOVE GRADE
- 09 PROPOSED MASONRY PLANTER - 2'-0" ABOVE GRADE
- 10 PROPOSED MASONRY PLANTER - SAME HEIGHT AS EXISTING RETAINING WALL (WHICH WILL REMAIN)
- 11 REFUSE ENCLOSURE - 5'-0" ABOVE GRADE
- 12 CONCRETE PAD - EXPOSED AGGREGATE CONCRETE (< 38% LRV), TYP.

SITE DATA

AREA OF LOT	44,542 SF (1.0225 AC)
AREA UNDER ROOF	6,267 SF
LIVABLE SF	3,830 SF
FLOOR AREA RATIO	14.07% < 25%
ALLOWABLE NET DISTURBED AREA	45.38% (20,213 SF)
PROPOSED GROSS DISTURBED AREA	19,381 SF
LESS 25% CREDIT FOR PAVERS	3,316 SF x 0.25 = 829 SF
LESS BUILDING FOOTPRINT AREA	4,694 SF
PROPOSED NET DISTURBED AREA	13,858 SF < 20,213 SF

PROJECT NARRATIVE


NEW CONSTRUCTION OF A 3,830 SF HOUSE WITH A THREE CAR GARAGE. THE EXISTING HOUSE IS TO BE DEMOLISHED, AND THE EXISTING POOL WILL BE DEMOLISHED AND FILLED IN.



ARCHITECTURE - INFRASTRUCTURE - RESEARCH
 airspace@air-irinc.com 480.329.1888

TONN RESIDENCE

5429 E SOLANO DR
 PARADISE VALLEY, AZ 85253

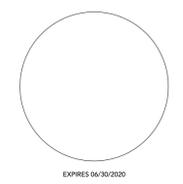

DATE: 11/26/18
 SCALE: AS SHOWN
 DRAWN: DP/JP


SITE PLAN

DRAWING TITLE:
FORMAL REVIEW
 PROJECT PHASE


SITE PLAN
 SCALE: 1/16" = 1'-0"

A-1.3


SHEET NO.

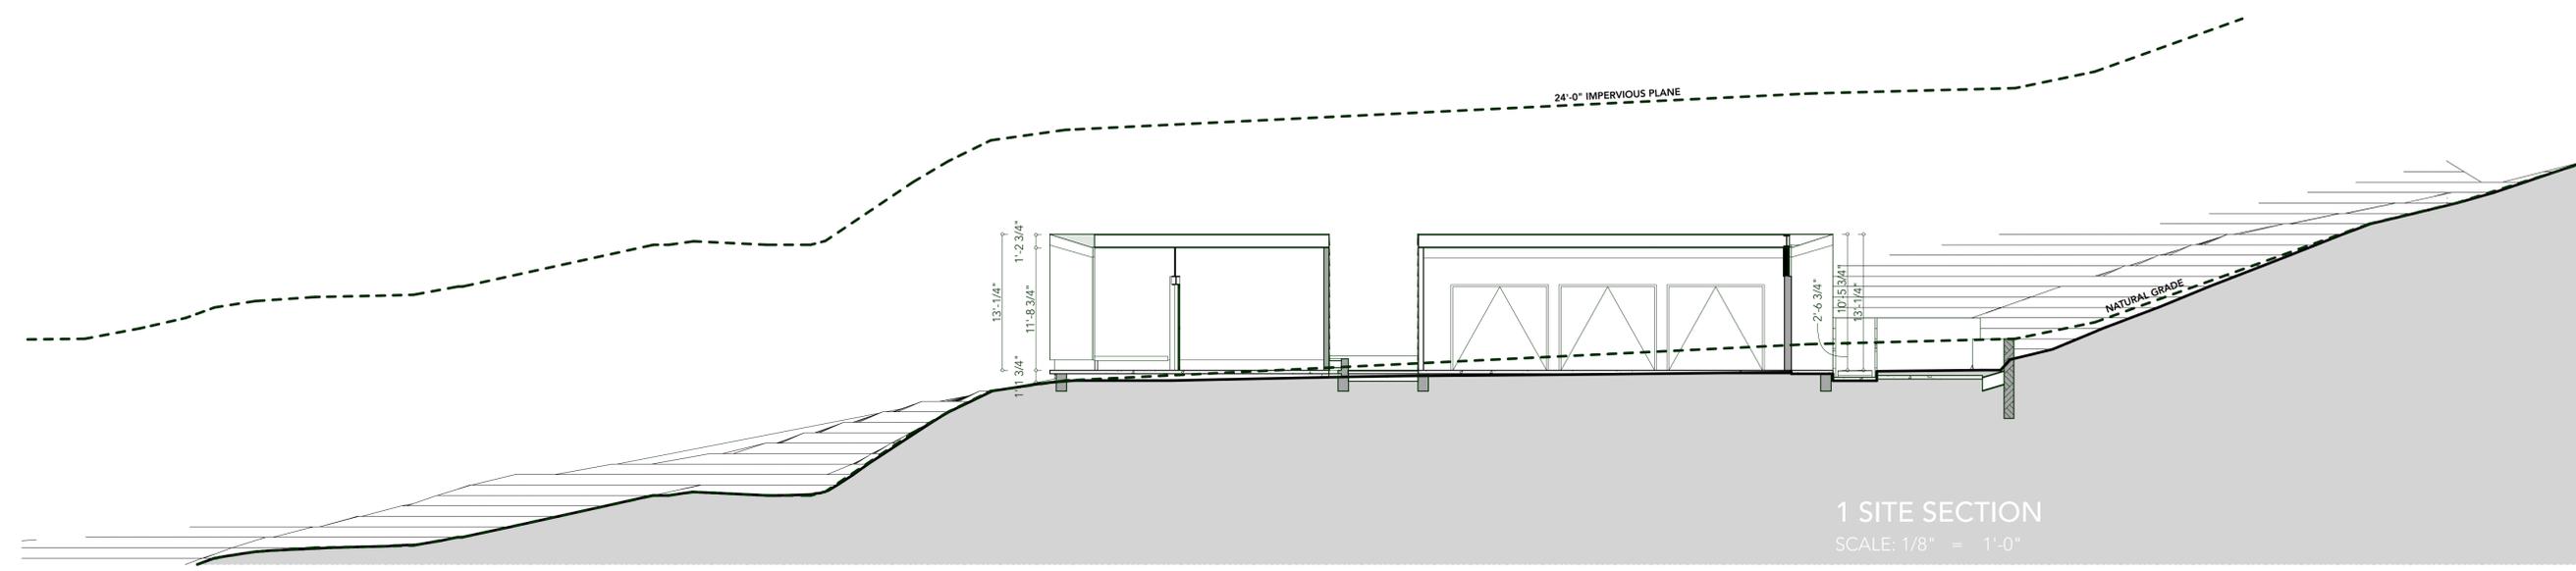


1 SITE SECTION
 SCALE: 1/8" = 1'-0"

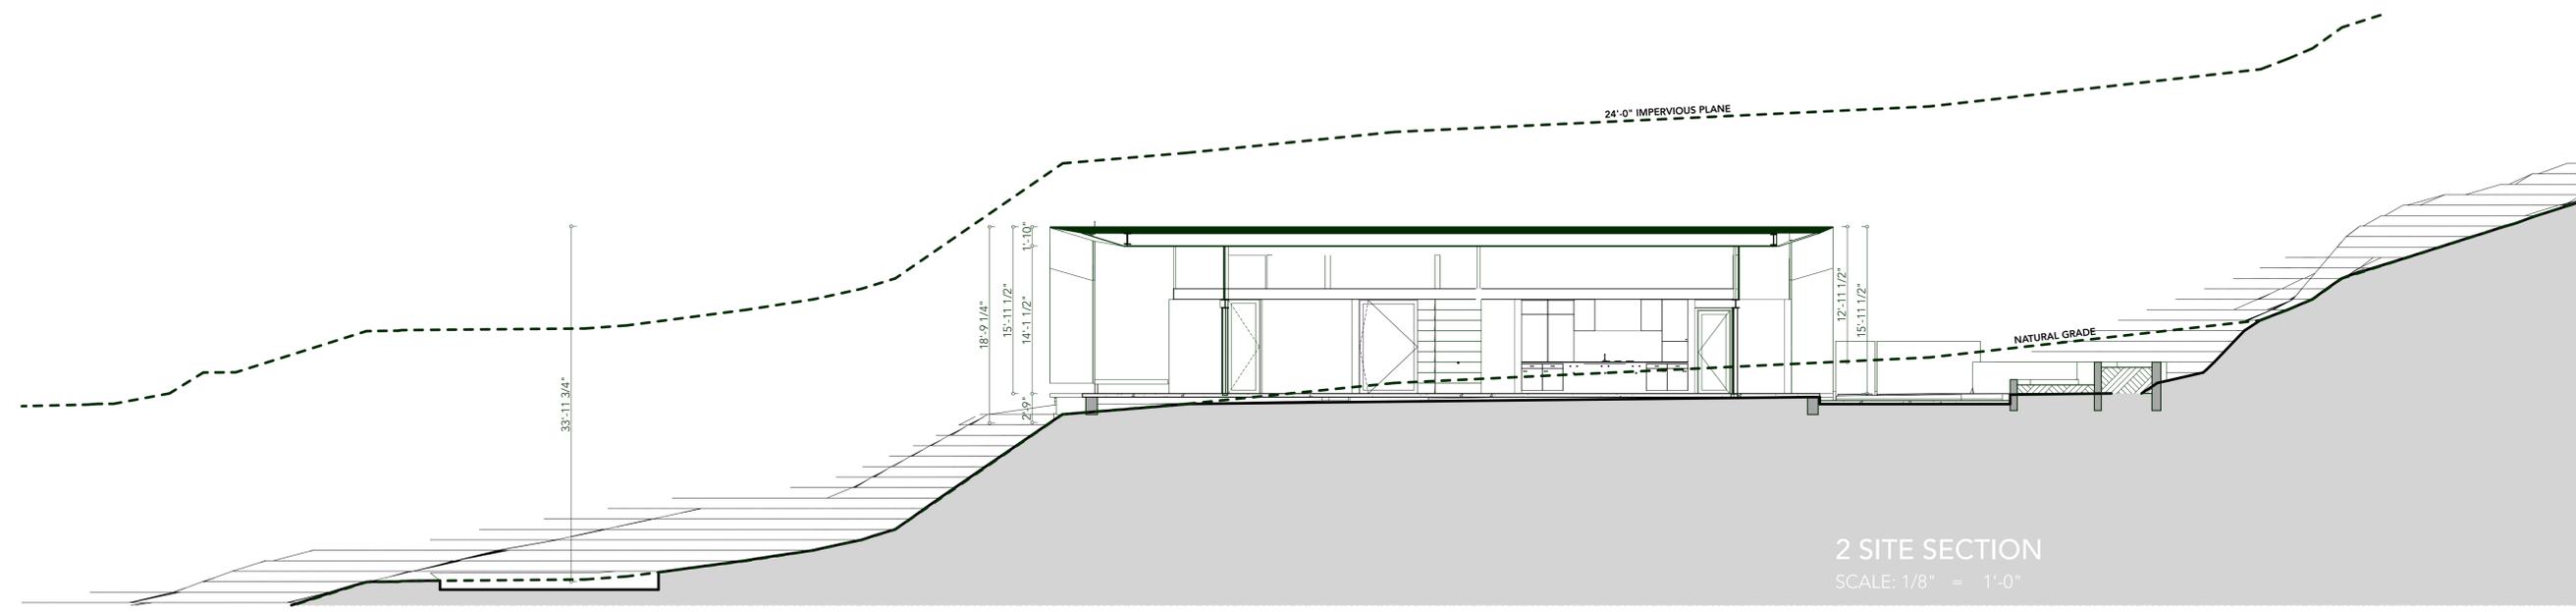

2 SITE SECTION
 SCALE: 1/8" = 1'-0"

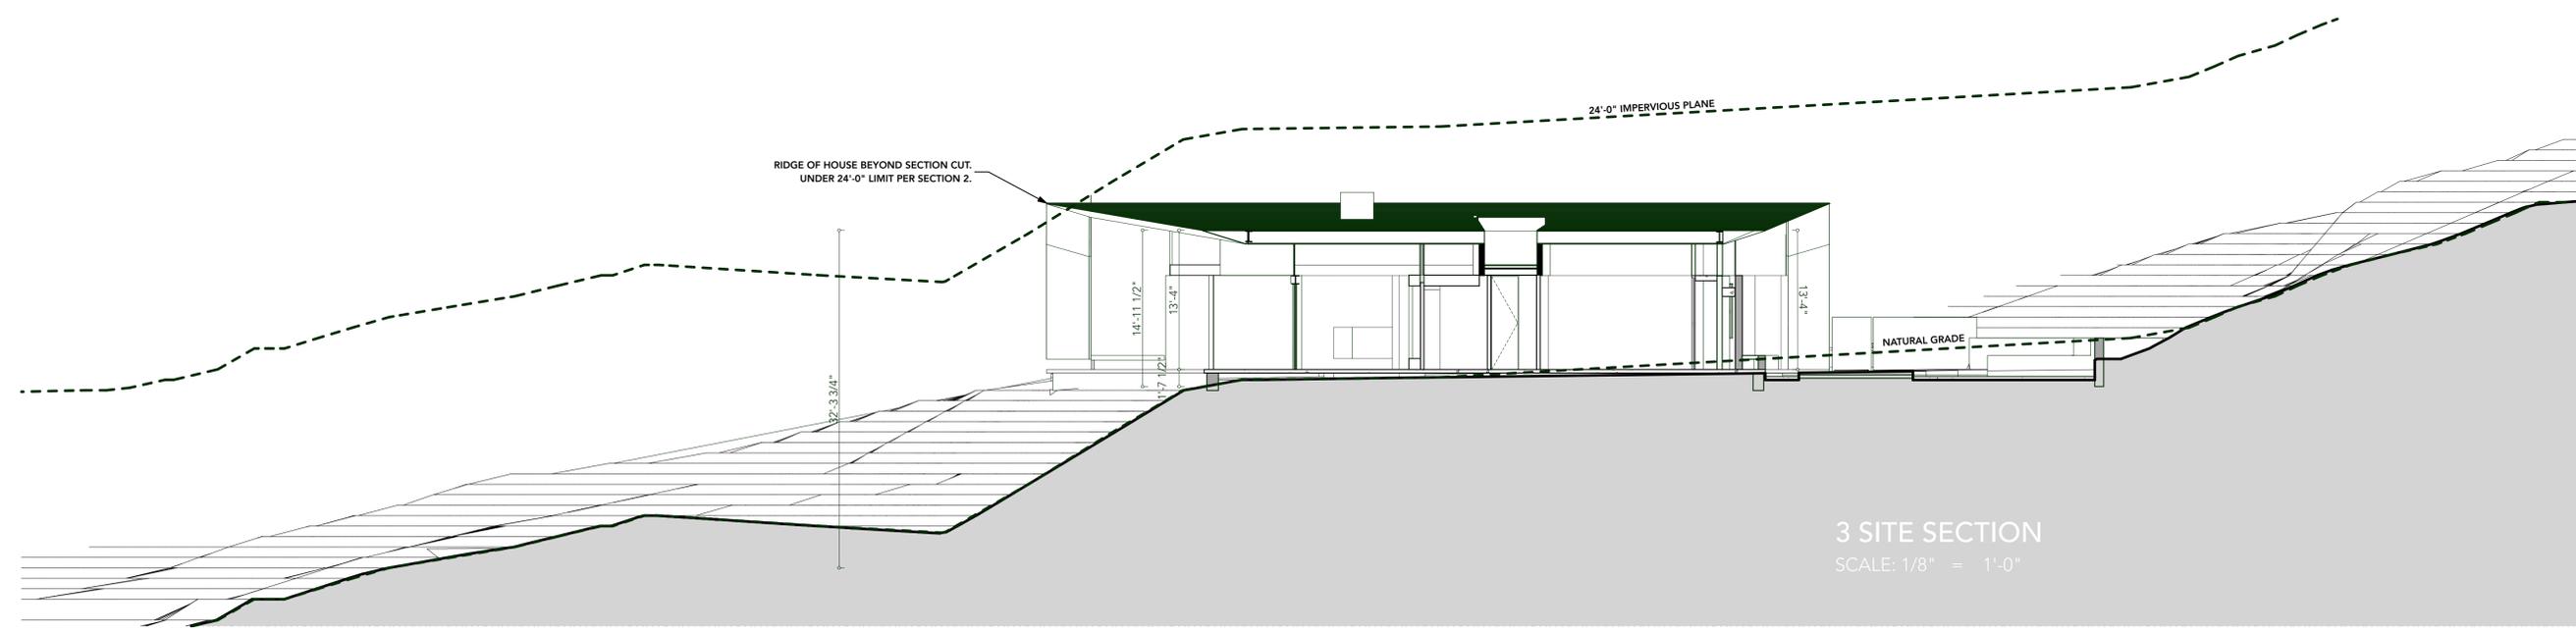


3 SITE SECTION
 SCALE: 1/8" = 1'-0"

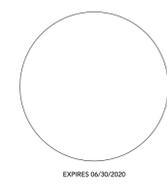


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JOB: SITE SECTIONS


DRAWING TITLE: FORMAL REVIEW
 PROJECT PHASE:

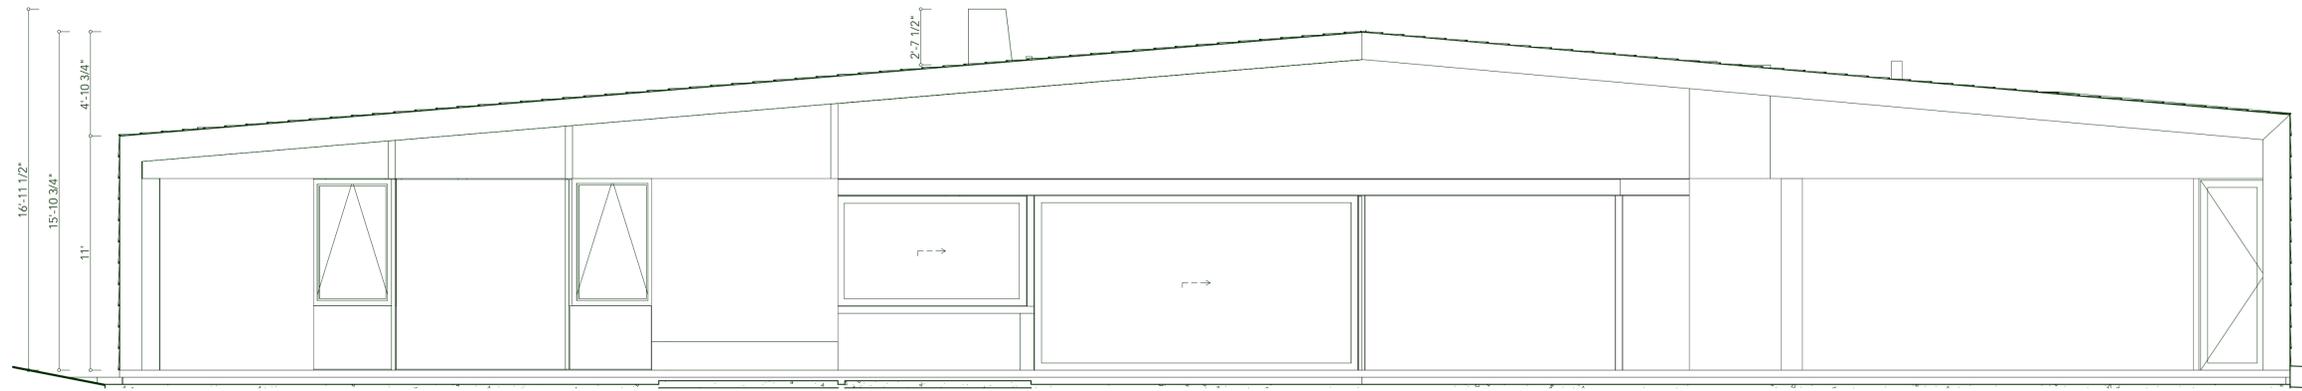


SOUTH ELEVATION
SCALE: 1/4" = 1'-0"

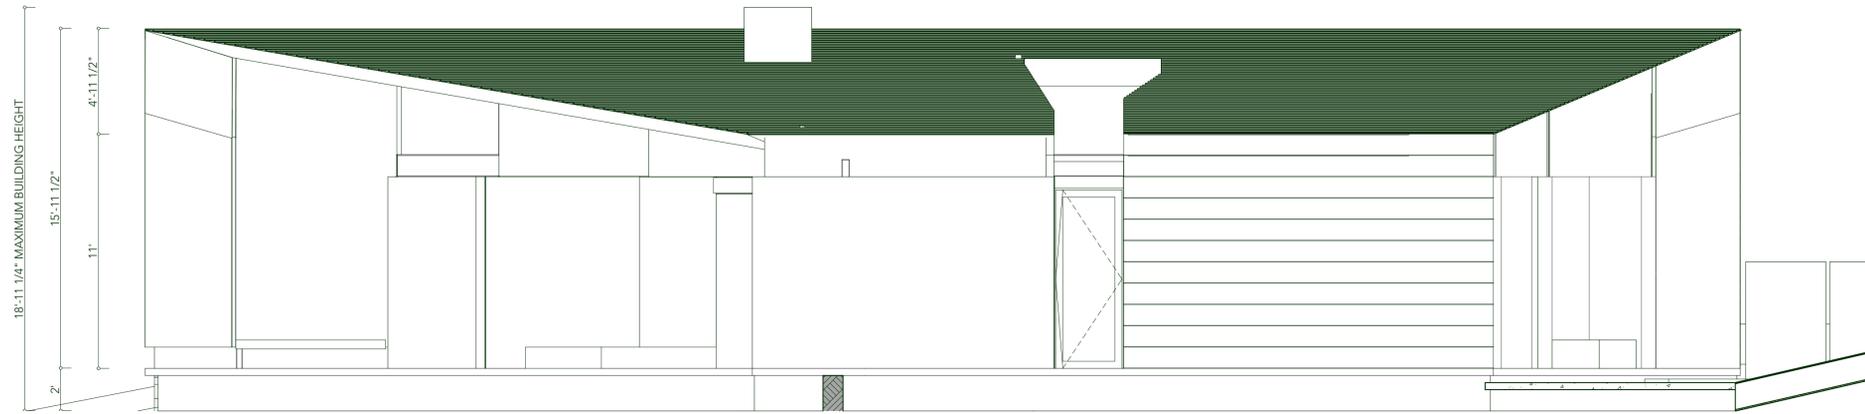


WEST ELEVATION
SCALE: 1/4" = 1'-0"

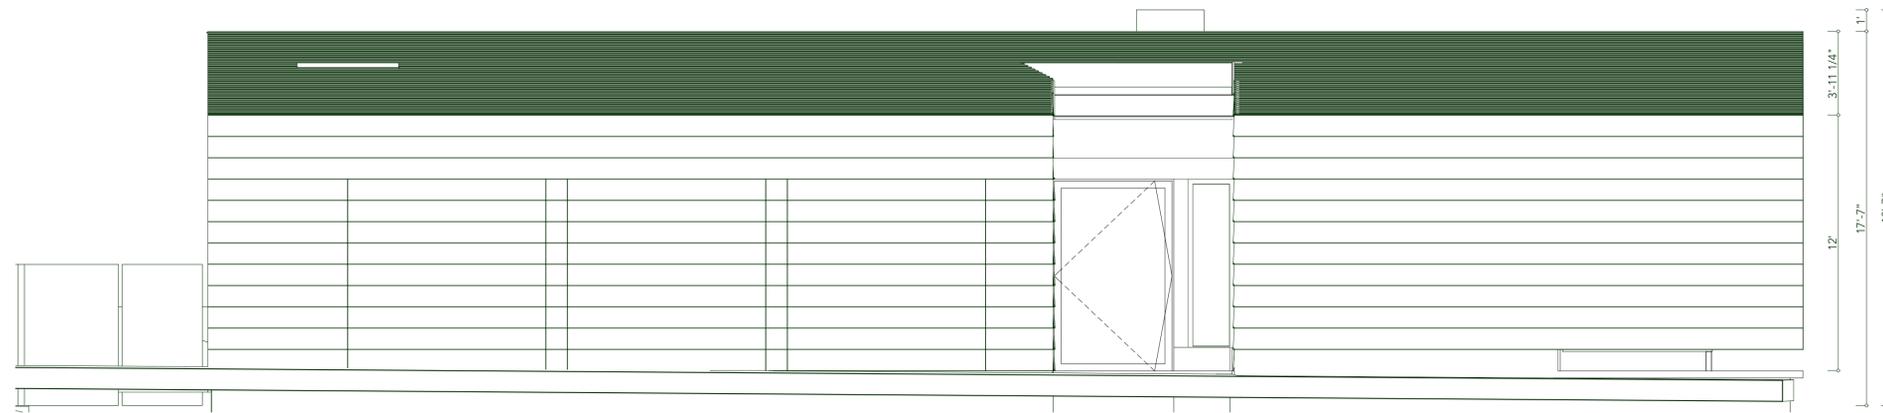

EAST ELEVATION
SCALE: 1/4" = 1'-0"

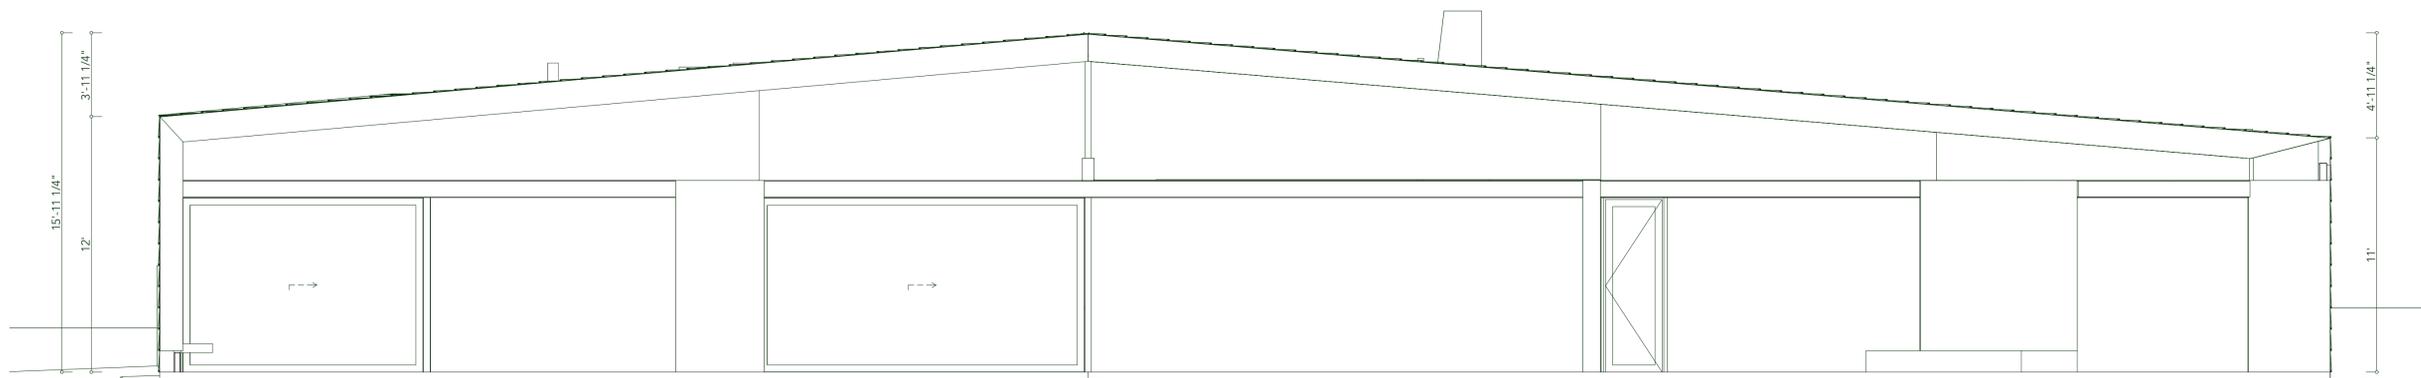

NORTH ELEVATION
SCALE: 1/4" = 1'-0"

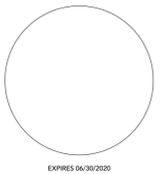

DATE: 11/26/18
SCALE: AS SHOWN
DRAWN: DP/JP

ELEVATIONS

FORMAL REVIEW
PROJECT PHASE

A-1.5

SHEET NO.

PATH LIGHT:

OIWL
SERIES

OIWL-103
IN-GROUND DRIVE-OVER WELL LIGHT




SUGGESTED USE
For areas where smooth and wide light distribution is needed. Ideal for building facades, security, recreation facilities, parking lots, signs, and displays.

CONSTRUCTION
Stainless steel corrosion-proof housing with PVC lens. The one-piece silicone gasket effectively seals against contaminants by seating off the optical chamber.

LENS - Clear, heat- and impact-resistant tempered glass lens.

LAMP/WATTAGE - 60W incandescent or 10W LED.


LISTINGS - ETL/C-ETL for wet locations.

All specifications are subject to change without notice.

Dimensions:



Dimensions:

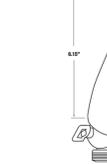

Ordering Guide > Example: OIWL-103-MR16-10W-LED-12-CL

O I W L - 1 0 3	M R 1 6	1 2 V	W B
SERIES OIWL-103 - Clear In-Ground Well Light	LAMP TYPE/WATTAGE MR16 (10W Max/10W) (10W LED)	VOLTAGE 12V	COLOR WB - Stainless Steel


*MUST BE USED WITH REMOTE TRANSFORMER

418 ORACLE > WWW.ORACLELIGHTING.COM > TEL: (323) 888-1973 > FAX: (323) 888-1977

ACCENT LIGHT:

OLD
SERIES

OLD2
BRASS DIRECTIONAL SPOT LIGHT WITH HOOD

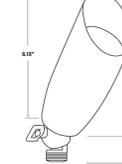SUGGESTED USE
For areas where smooth and wide light distribution is needed. Ideal for building facades, security, recreation facilities, parking lots, signs, and displays.

CONSTRUCTION
Made of brass corrosion-proof housing. The one-piece silicone gasket effectively seals outside contaminants by seating off the optical chamber.

FINISH - Brass corrosion-resistant polyester powder finish is standard.

LENS - Clear convex, heat- and impact-resistant tempered glass lens.


LAMP/WATTAGE - 50W incandescent or 10W LED.

INSTALLATION - Fixtures offer an adjustable knuckle with 1/2" NPT threads for easy mounting to boxes or adapters. Bottom lead wiring.


LISTINGS - ETL/C ETL for wet location.

All specifications are subject to change without notice.

Dimensions:

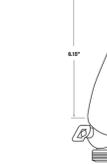

Dimensions:

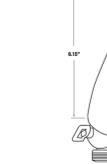

Ordering Guide > Example: Ordering Guide Example: OLD2-MR16-10W-LED-12-BZ

O L D 2	M R 1 6	1 2 V	W B
SERIES OLD2-Directional Spot Light	LAMP TYPE/WATTAGE MR16 (10W Max/10W) (10W LED)	VOLTAGE 12V	COLOR WB - 1/2" Brass WB - Weathered Brass





*MUST BE USED WITH REMOTE TRANSFORMER

412 ORACLE > WWW.ORACLELIGHTING.COM > TEL: (323) 888-1973 > FAX: (323) 888-1977

WALL SCONCE:

DESCRIPTION
Lanterra 9003-W1 (Up or Down) and 9003-W2 (Up or Down) are 3.25" O.D., line voltage cylinder fixtures with dimmable LED. The luminaires comes in various mounting, surface mount with integral driver in the housing, remote driver mount with round and square wall plates and square wall integral driver, all of which can be mounted over standard 4 inch I-box. The luminaires also comes with various beam optics and premium color tuning option. It also comes with various lens, louvers and colors or dichroic filters, which can combine up to two at once to create multiple lighting effects. The fixture may be used indoors or outdoors and carries IP66 rating.

SPECIFICATION FEATURES
Material - Housing, hood and mounting stem are precision-machined from corrosion resistant billet stock 6061-T6 aluminum.
Finish - Fixtures constructed from 6061-T6 aluminum are double protected by an RCHS compliant chemical film, undercoating and polyester powder coat paint finish, surpassing the rigorous demands of the outdoor environment. A variety of standard colors are available.
Hood - Hood is removable and accepts up to two internal accessories at once (lenses, louvers and filters) to achieve multiple lighting effects. Weep holes prevents water and mineral stains from collecting on the lens, even in the straight up position. The flush lens design reduces fixture length, minimizes debris collection and prevents water and mineral stains from collecting on the lens.
DIMENSIONS

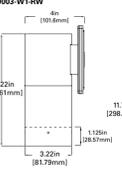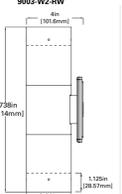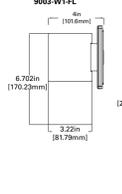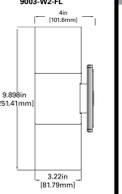9003-W1-RW	9003-W2-RW	9003-W1-FL	9003-W2-FL
			

Lumiere

Catalog #	Type
Project	Date
Comments	
Prepared by	

Lanterra 9003

LED INTERIOR / EXTERIOR CYLINDER FLOOD LIGHT
CERTIFICATION DATA
cULus - 1598
Wet Location Listed - IP66
LM79/LM80 Compliant
ROHS Compliant
10W LED, L70/102,000@25° Celsius
20W LED, L70/102,000@25° Celsius

ORDERING INFORMATION

SERIES	DIRECTION	HOOD	LENS	LED CCT & CR	FIELD REPLICABLE OPTICS	FINISH	LIGHT LEVEL	VOLTAGE	MOUNTING	OPTIONS
9003	W1 (Up or Down)	Standard	Standard CR	2700K, 3000K, 3500K, 4000K, 4500K, 5000K, 5700K, 6500K, 7000K, 7500K, 8000K, 8500K, 9000K, 9500K, 10000K	Field Replicable	Standard	11	120V	Surface Mount - Wall, Ceiling, Ground	Standard
9003	W2 (Up or Down)	Recessed	Standard CR	2700K, 3000K, 3500K, 4000K, 4500K, 5000K, 5700K, 6500K, 7000K, 7500K, 8000K, 8500K, 9000K, 9500K, 10000K	Field Replicable	Standard	11	120V	Recessed	Standard

Notes: 1. 0-10V dimming capability. 2. 0-10V dimming is not available in LED. 3. 0-10V dimming is not available in LED. 4. 0-10V dimming is not available in LED. 5. Only available for Single Head Up or Down (W1) with RSM only. 6. Only available for Single Head Up or Down (W2) with RSM only. 7. Only available for LED. 8. Remote Driver options up to 60'. 9. Available 01-2018. 10. Specifications and dimensions subject to change without notice.

TDS06024EN 4-2018

TAPE LIGHT:

LB200 OUTDOOR SINGLE COLOR SERIES

12V

114

3W

50,000



Voltage Lumens/Ft Watts/Ft Life (hours) Wet Location

Features:
 Available in Warm White 3000K, Cool White 6500K, red, amber, green, and blue.
 Low profile for discreet locations.
 Easy connectors allow for simple plug and play installation.
 UV rays and infrared wavelengths are non-existent.
 Solid in 16' rolls.
 Highly efficient 114 Lumens PERVAT for white LEDs.

Electrical:
 Elite LED tape light is offered with a 30W 12V driver (LB100-DR-12V-30W) that can power one run up to 16' or a 60W 12V driver (LB100-DR-12V-60W) that can power two runs at 16' each run.
 Maximum continuous run of 16'.
 Forward Voltage Drop: 1.92-2.2V


Driver
LB100-DR-12V-30W
LB100-DR-12V-60W

Clamp
LB200-CLAMP

End Cap
LB200-END CAP


Power Cap
LB200-POWER CAP

Dimensions:

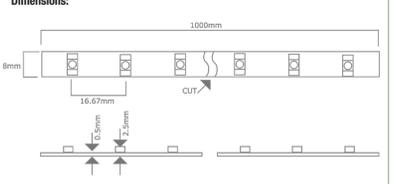

For Hardwired Drivers go to page 434

TYPE	COLOR	VOLTAGE	CURRENT (MA)	POWER (W/FT)	COLOR TEMP.	VIEW ANGLE	LM/FT	# OF DIODES/FT	ACCESSORIES
LB200-15F-65K	COOL WHITE	12V DC	<400	<3	6500K	140°	114	18	LB100-DR-12V-30W 30W Plug-in Driver
LB200-15F-30K	WARM WHITE	12V DC	<400	<3	3000K	140°	98	18	LB100-DR-12V-30W 30W Plug-in Driver
LB200-15F-RED	RED	12V DC	<400	<3		140°	36	18	LB200-CLAMP Holding to the surface
LB200-15F-AMBER	AMBER	12V DC	<400	<3		140°	36	18	LB200-END CAP End Cap
LB200-15F-GREEN	GREEN	12V DC	<400	<3		140°	66	18	LB200-POWER CAP Cap used for power feed
LB200-15F-BLUE	BLUE	12V DC	<400	<3		140°	19	18	LB200-SILONE Silicone Gels

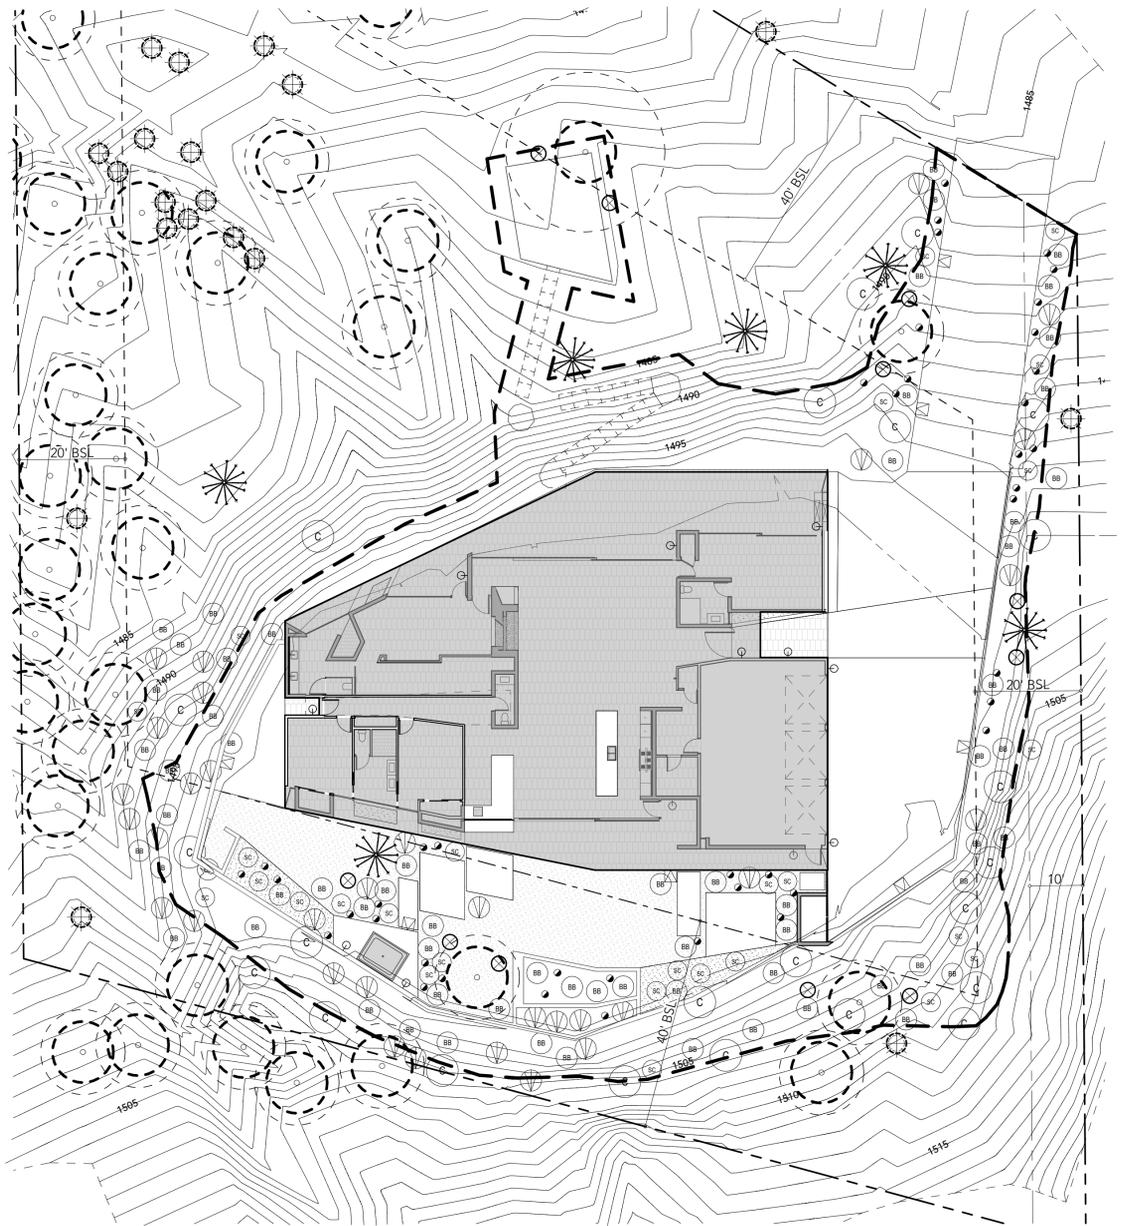

LANDSCAPE & BUILDING LIGHTING PLAN
SCALE: 1/16" = 1'-0"

----- DISTURBED AREA




TONN RESIDENCE

5429 E SOLANO DR
PARADISE VALLEY, AZ 85253

DATE: 11/26/18
SCALE: AS SHOWN
DRAWN: DP/JP
JOB: LANDSCAPE & BUILDING LIGHTING PLAN
DRAWING TITLE: FORMAL REVIEW
PROJECT NAME:

A-1.6

SHEET NO.

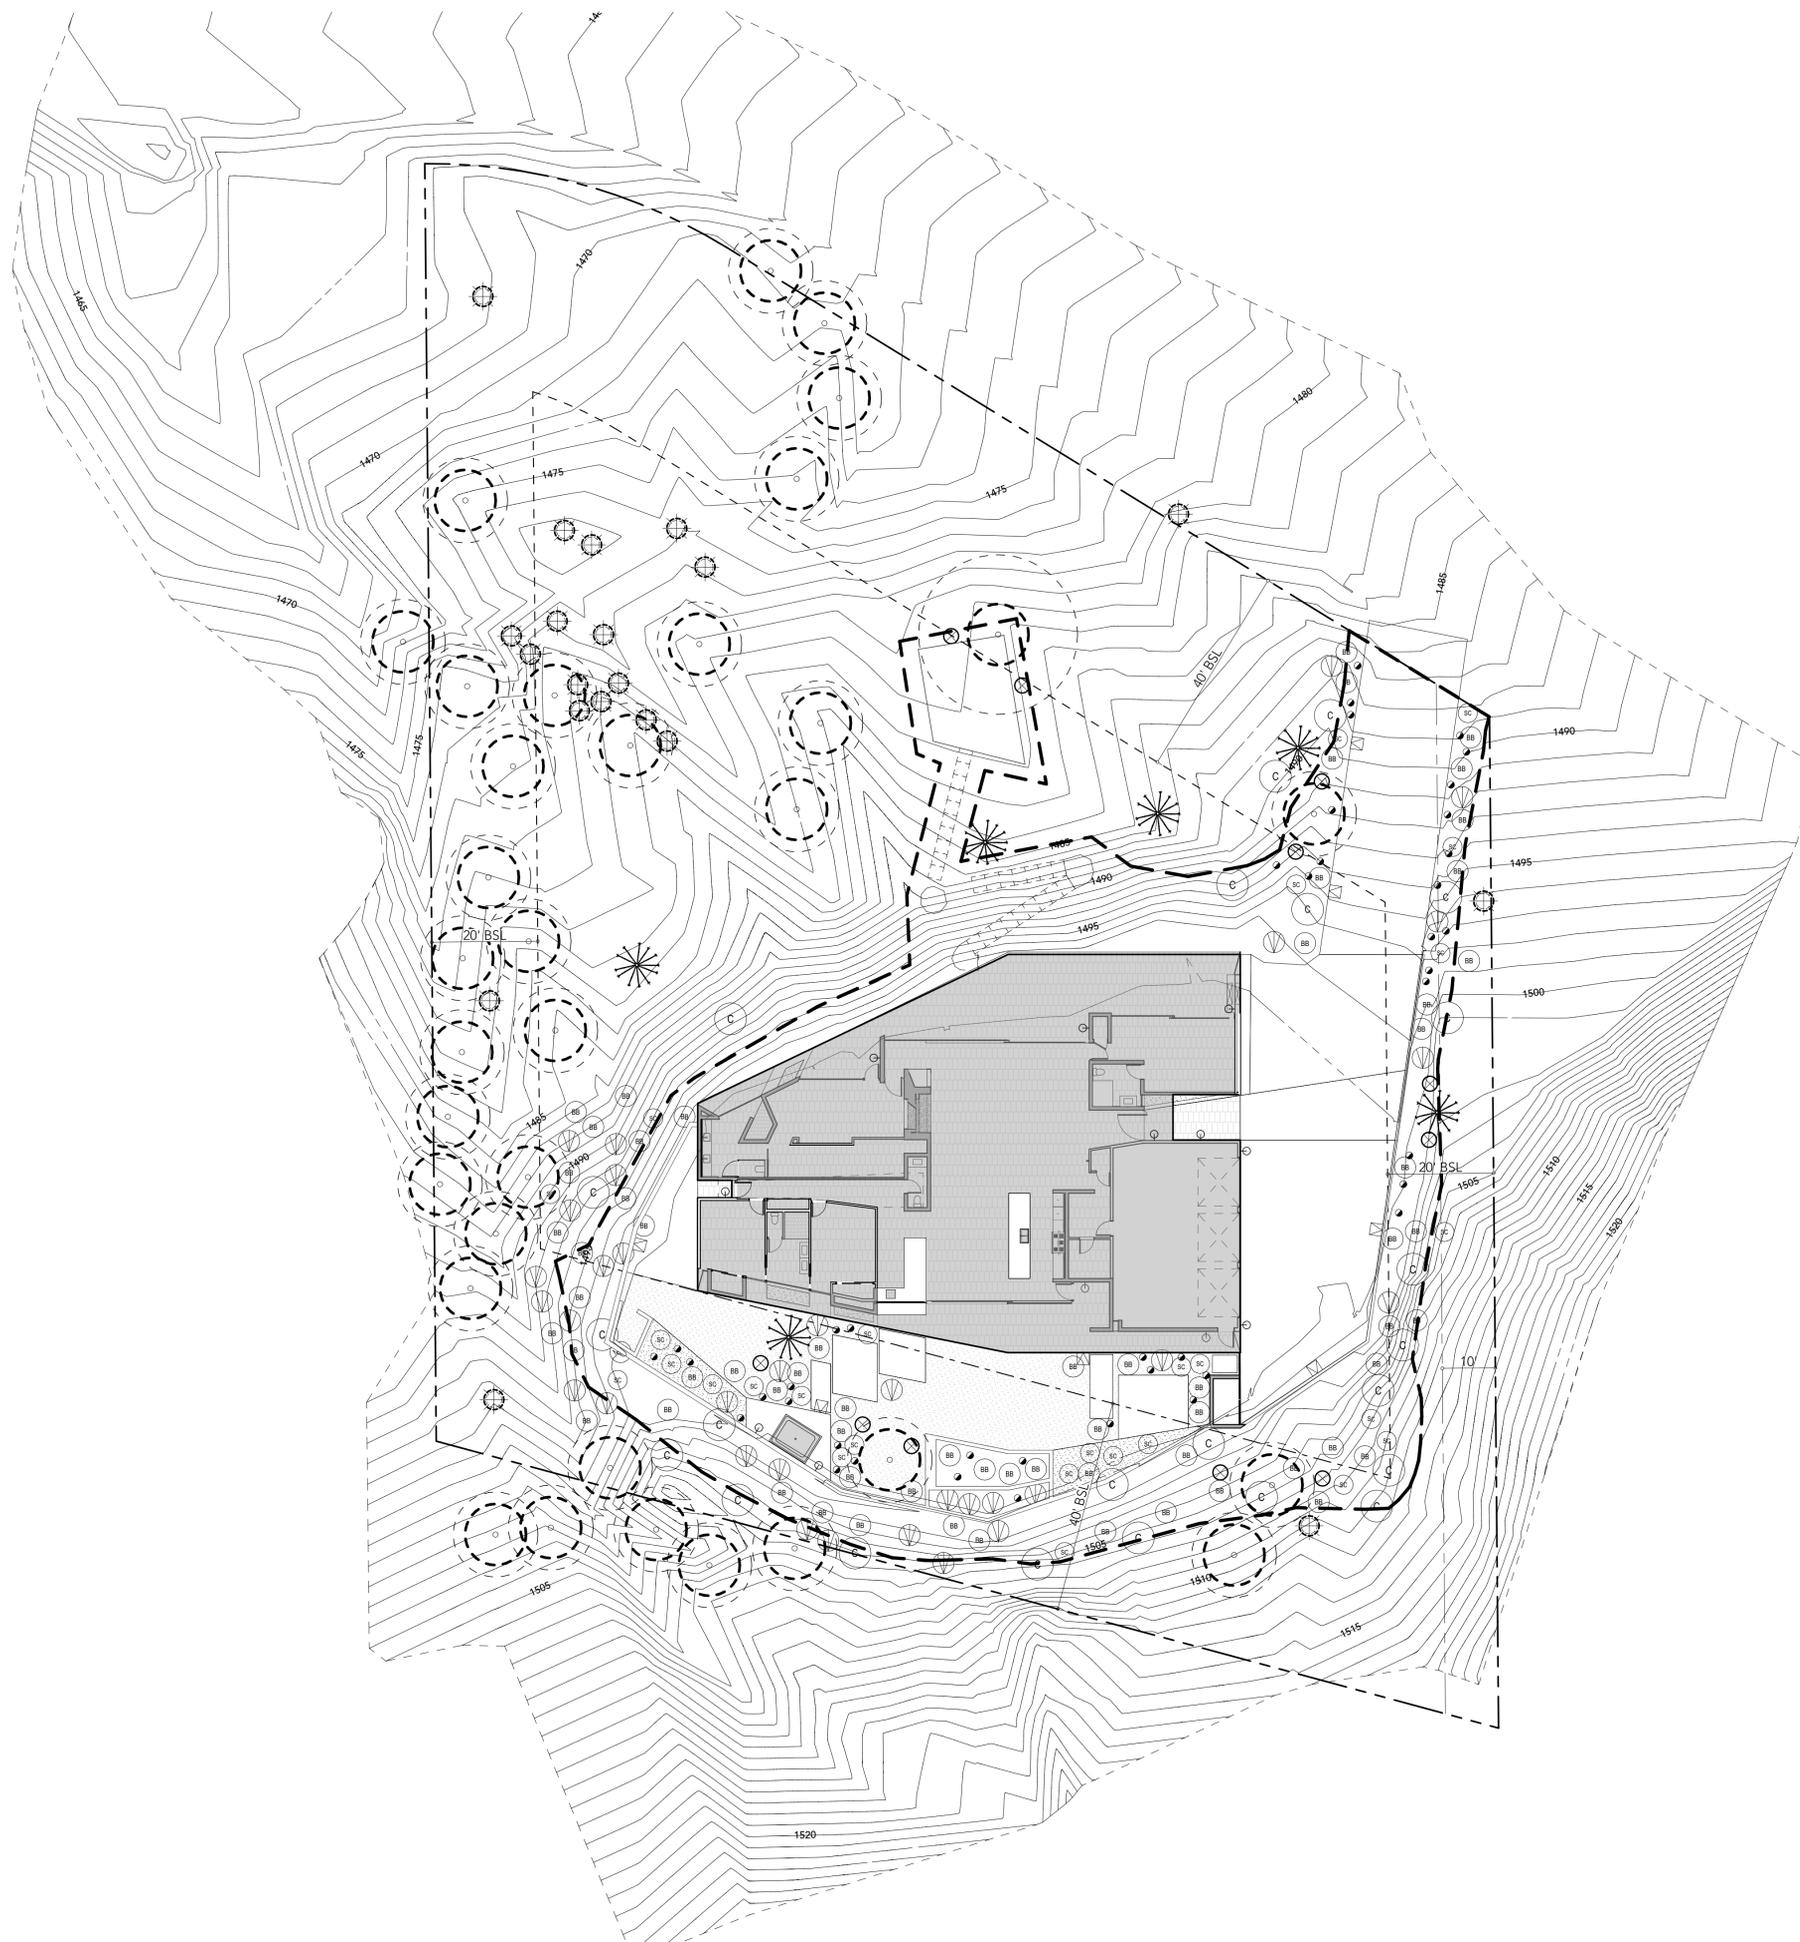

PLANT LEGEND



EXISTING TREE TO REMAIN



EXISTING CACTUS TO REMAIN

SHRUBS



BOTANICAL NAME LARREA TRIDENTATA **COMMON NAME** CREOSOTE **SIZE** 15 GAL **QUANTITY** 23



BOTANICAL NAME ENCELIA FARINOSA **COMMON NAME** BRITTLEBUSH **SIZE** 5 GAL **QUANTITY** 66



BOTANICAL NAME SALVIA CLEVELANDII **COMMON NAME** CHAPARRAL SAGE **SIZE** 5 GAL **QUANTITY** 27



BOTANICAL NAME JUSTICIA CALIFORNICA **COMMON NAME** CHUPAROSA **SIZE** 5 GAL **QUANTITY** 24



BOTANICAL NAME FOUQUIERIA SPLENDENS **COMMON NAME** OCOTILLO **SIZE** 8 CANE MIN. **QUANTITY** 6

GROUNDCOVER



BOTANICAL NAME BAILEYA MULTIRADIATA **COMMON NAME** DESERT MARIGOLD **SIZE** 1 GAL **QUANTITY** 40




ARCHITECTURE - INFRASTRUCTURE - RESEARCH
airspace@a-irinc.com 480.329.1888

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TONN RESIDENCE

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PARADISE VALLEY, AZ 85253

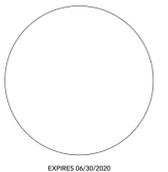

DATE: 11/26/18
SCALE: AS SHOWN
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LANDSCAPE PLAN

FORMAL REVIEW

LANDSCAPE PLAN
SCALE: 1/16" = 1'-0"

A-1.7

SHEET NO.