

The Scherr Residence

5416 E. Desert Jewel Drive, Paradise Valley, Arizona

A-0	COVER SHEET	S-1	BOUNDARY & TOPOGRAPHIC SURVEY	A-2.0	RENDERING & SITE PHOTOS	A-4.0	EXTERIOR ELEVATIONS	A-5.0	BUILDING SECTIONS	A-6.0	MASSING MODEL
C-1	COVER SHEET - GRADING & DRAINAGE PLAN	A-1.0	SITE PLAN	A-3.0	EXTERIOR BUILDING LIGHTING PLAN	A-4.1	EXTERIOR ELEVATIONS	A-5.1	BUILDING SECTIONS	A-7.0	EXTERIOR MATERIALS
C-2	GRADING & DRAINAGE IMPROVEMENT PLAN										



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MARK	DATE	DESCRIPTION

ISSUE: 9/19/17 - CONCEPT REVIEW

PROJECT NO:

CAD DWG FILE:

DRAWN BY: CK

CHECKED BY: BK

SHEET TITLE:

COVER

A-0



TOWN OF PARADISE VALLEY NOTES

- GRADING SHALL BE IN CONFORMANCE WITH 2015 IBC.
- PRIOR TO FIRST FOOTING INSPECTION OF ANY TYPE, ALL PROPERTY PINS SHALL BE PLACED BY A REGISTERED LAND SURVEYOR OF THE STATE OF ARIZONA, AND PROPERTY LINES MUST BE PHYSICALLY IDENTIFIED PRIOR TO INSPECTION.
- WHERE EXCAVATION IS TO OCCUR THE TOP 4" OF EXCAVATED NATIVE SOIL SHALL REMAIN ON THE SITE AND SHALL BE REUSED IN A MANNER THAT TAKES ADVANTAGE OF THE NATURAL SOIL SEED BANK IT CONTAINS.
- ALL CONSTRUCTION SHALL CONFORM TO THE LATEST MARICOPA ASSOCIATION OF GOVERNMENTS (M.A.G.) SPECIFICATIONS AND STANDARD DETAILS.
- ALL EXTERIOR SITE LIGHTING SHALL COMPLY WITH REQUIREMENTS OF SECTION 2208 OF THE TOWN OF PARADISE VALLEY ZONING ORDINANCES FOR FUTURE TYPE, LOCATION, HEIGHT, WATTAGE BASED UPON FIXTURES INSTALLED.
- A DUST CONTROL PLAN MEETING THE REQUIREMENTS OF RULE 310 OF THE MARICOPA COUNTY AIR POLLUTION CONTROL REGULATIONS, AS AMENDED, IS REQUIRED.
- A SEPARATE PERMIT IS NECESSARY FOR ANY OFFSITE CONSTRUCTION.
- AN APPROVED GRADING AND DRAINAGE PLAN SHALL BE ON THE JOB SITE AT ALL TIMES. DEVIATIONS FROM THE PLAN MUST BE PRECEDED BY AN APPROVED PLAN REVISION.
- EAVE PROJECTIONS INTO REQUIRED SETBACKS ARE LIMITED TO A MAXIMUM OF 24" PURSUANT TO SECTION 1008 OF THE TOWN OF PARADISE VALLEY ZONING ORDINANCES.
- ALL STRUCTURES AND LANDSCAPING WITHIN THE SIGHT VISIBILITY TRIANGLE SHALL HAVE A 2 FOOT MAXIMUM HEIGHT.
- ALL NEW AND EXISTING ELECTRICAL SERVICE TO BE BURIED UNDERGROUND PER THE TOWN OF PARADISE VALLEY STANDARDS.
- POOL, SPA, BARBECUE AND ANY PROPOSED STRUCTURES OVER 8 INCHES ABOVE GRADE REQUIRE SEPARATE PERMIT APPLICATIONS.
- POOLS SHALL BE CONSTRUCTED BY SEPARATE PERMIT AND SECURED FROM UNWANTED ACCESS PER SECTION 5-2-2 OF THE TOWN OF PARADISE VALLEY ORDINANCES.
- A SETBACK CERTIFICATION IS REQUIRED AND MUST BE GIVEN TO TOWN INSPECTOR AT STEM WALL INSPECTION.
- MAIL BOX TO COMPLY WITH THE TOWN OF PARADISE VALLEY STANDARDS FOR MAIL BOXES IN THE R.O.W. FOR HEIGHT, WIDTH AND BREAK AWAY FEATURES.
- ALL PATIOS, WALKS, AND DRIVES TO SLOPE AWAY FROM BUILDING AND GARAGES AT A MINIMUM SLOPE OF 1/4" PER FOOT UNLESS SPECIFIED OTHERWISE. ALL LAWN AREAS ADJOINING WALKS OR SLABS WILL BE GRADED TO 2" BELOW THE TOP OF SLAB. TYPICAL FINISHED GRADE AROUND PERIMETER OF BUILDING IS MINUS 6" BELOW FINISHED FLOOR UNLESS SPECIFIED OTHERWISE.
- ALL MATERIAL TO BE UNDER SLABS AND WALKS SHALL BE COMPACTED TO NOT LESS THAN 95% PER ASTM D698.
- SOILS COMPACTION TEST RESULTS MUST BE SUBMITTED TO THE TOWN ENGINEER'S OFFICE FOR BUILDING PADS THAT HAVE ONE (1) FOOT OR MORE OF FILL MATERIAL INDICATED. THIS INFORMATION MUST BE SUPPLIED PRIOR TO REQUEST FOR FINAL INSPECTION.
- TRENCH BED SHALL BE FREE OF ROCKS AND DEBRIS.
- REGULATION II RULE 20-3 OF THE MARICOPA COUNTY HEALTH DEPARTMENT, BUREAU OF AIR POLLUTION CONTROL SHALL BE OBSERVED AND ENFORCED.
- ALL WORK REQUIRED TO COMPLETE THE CONSTRUCTION COVERED BY THIS PLAN SHALL BE IN ACCORDANCE WITH THE M.A.G. STANDARD SPECIFICATIONS AND DETAILS AND CURRENT SUPPLEMENTS THEREOF FOR THE LOCAL CITY OR TOWN UNLESS SPECIFIED OTHERWISE IN THESE PLANS OR ELSEWHERE IN THE CONTRACT DOCUMENTS. CONTRACTORS SHALL FAMILIARIZE THEMSELVES WITH ALL REQUIRED STANDARD SPECIFICATIONS, DETAILS AND SUPPLEMENTS PRIOR TO BIDDING THE WORK FOR THE CONSTRUCTION COVERED BY THIS PLAN.
- THE CONTRACTOR IS TO COMPLY WITH ALL LOCAL STATE, AND FEDERAL LAWS AND REGULATIONS APPLICABLE TO THE CONSTRUCTION COVERED BY THIS PLAN.
- THE CONTRACTOR IS RESPONSIBLE FOR OBTAINING AND COMPLYING WITH ALL PERMITS REQUIRED TO COMPLETE ALL WORK COVERED BY THIS PLAN.
- ALL CONSTRUCTION IN THE PUBLIC RIGHTS-OF-WAY OR IN EASEMENTS GRANTED FOR PUBLIC USE MUST CONFORM TO THE LATEST MARICOPA ASSOCIATION OF GOVERNMENTS (MAG) UNIFORM STANDARD SPECIFICATIONS AND UNIFORM STANDARD DETAILS FOR PUBLIC WORKS CONSTRUCTION.
- THE TOWN ONLY APPROVES THE SCOPE, NOT THE DETAIL, OF ENGINEERING DESIGNS; THEREFORE, IF CONSTRUCTION QUANTITIES ARE SHOWN ON THESE PLANS, THEY ARE NOT VERIFIED BY THE TOWN.
- THE APPROVAL OF PLANS IS VALID FOR SIX (6) MONTHS, IF AN ENCROACHMENT PERMIT FOR THE CONSTRUCTION HAS NOT BEEN ISSUED WITHIN SIX MONTHS, THE PLANS MUST BE RESUBMITTED TO THE TOWN FOR RE-APPROVAL.
- A PUBLIC WORKS INSPECTOR WILL INSPECT ALL WORKS WITHIN THE TOWN OF PARADISE VALLEY RIGHTS-OF-WAY AND IN EASEMENTS. NOTICE INSPECTION SERVICES 24 HOURS PRIOR TO BEGINNING CONSTRUCTION BY CALLING 480-312-5750.
- WHENEVER EXCAVATION IS NECESSARY, CALL THE BLUE STAKE CENTER, 602-263-1100, TWO WORKING DAYS BEFORE EXCAVATION BEGINS. THE CENTER WILL SEE THAT THE LOCATION OF THE UNDERGROUND UTILITY LINES IS IDENTIFIED ON THE PROJECT CALL "CONTACT" IF NECESSARY.
- ENCROACHMENT PERMITS ARE REQUIRED FOR ALL WORK IN PUBLIC RIGHTS-OF-WAY AND EASEMENTS GRANTED FOR PUBLIC PURPOSES. AN ENCROACHMENT PERMIT WILL BE ISSUED BY THE TOWN ONLY AFTER THE REGISTRANT HAS PAID A BASE FEE PLUS A FEE FOR INSPECTION SERVICES. COPIES OF ALL PERMITS MUST BE RETAINED ON-SITE AND BE AVAILABLE FOR INSPECTION AT ALL TIMES. FAILURE TO PRODUCE THE REQUIRED PERMITS WILL RESULT IN IMMEDIATE SUSPENSION OF ALL WORK UNTIL THE PROPER PERMIT DOCUMENTATION IS OBTAINED.
- ALL EXCAVATION AND GRADING THAT IS NOT IN THE PUBLIC RIGHTS-OF-WAY OR NOT IN EASEMENTS GRANTED FOR PUBLIC USE MUST CONFORM TO CHAPTER 70, EXCAVATION AND GRADING, OF THE LATEST EDITION OF THE IBC BY THE ICC. A PERMIT FOR THIS GRADING MUST BE SECURED FROM THE TOWN FOR A FEE ESTABLISHED BY THE UNIFORM BUILDING CODE.
- EXCAVATIONS SHALL COMPLY WITH REQUIREMENTS OF OSHA EXCAVATION STANDARDS (29 CFR, PART 1926, SUBPART P), UNDER NO CIRCUMSTANCES WILL THE CONTRACTORS BE ALLOWED TO WORK IN A TRENCH LOCATED WITHIN THE TOWN'S RIGHT-OF-WAY WITHOUT PROPER SHORING OR EXCAVATION METHODS.
- ON DEMOLITION, GRADING, REMODELING AND NEW CONSTRUCTION PROJECTS, PERMITEE MUST NOTIFY ADJACENT PROPERTY OWNERS REGARDING THE NATURE OF THE PROJECT, THE TIME PERIOD FOR CONSTRUCTION, AND ANY UNUSUAL ACTIVITIES THAT MAY CAUSE DISRUPTION OF THE NORMAL COURSE OF TRAFFIC DURING CONSTRUCTION.
- ALL PERMITEES MUST POST A 6 SQUARE FOOT (2'x3') IDENTIFICATION SIGN, MADE OF DURABLE MATERIAL, IN THE FRONT YARD OF SUBJECT PROPERTY AND NOT IN THE TOWN RIGHT-OF-WAY. THE SIGN MAY NOT EXCEED A MAXIMUM OF 6 FEET IN HEIGHT FROM GRADE TO TOP OF THE SIGN. THE SIGN MUST INCLUDE THE PERMITEE OR COMPANY NAME, PHONE NUMBER, TYPE OF WORK, AND ADDRESS OF PROJECT.
- WHEN DEEMED NECESSARY, A 6-FOOT HIGH CHAIN LINK FENCE MUST BE INSTALLED AROUND THE CONSTRUCTION AREA TO PREVENT ANY POTENTIAL SAFETY HAZARD FOR THE PUBLIC. THE FENCE SHALL BE SETBACK AT LEAST FEET FROM ALL RIGHTS-OF-WAY AND HAVE A 50-FOOT STREET CORNER SITE TRIANGLE WHERE APPLICABLE.
- CLEAR ACCESS FOR NEIGHBORING PROPERTIES AND EMERGENCY VEHICLES MUST BE MAINTAINED AT ALL TIMES. CONSTRUCTION RELATED VEHICLES MUST BE LEGALLY PARKED ONLY ON ONE SIDE OF THE STREET OR JOB SITE PROPERTY. IF A STAGING AREA IS NEEDED ON A PROPERTY OTHER THAN THE CONSTRUCTION SITE FOR CONSTRUCTION SUPPLIES AND EQUIPMENT, THE PERMITEE MUST OBTAIN PROPERTY OWNER AND TOWN APPROVAL FIRST AND MUST INFORM THE ADJACENT PROPERTY OWNERS OF THE LOCATION OF STAGING AREA, AND TIME AND HOURS DURING THE DAY THE AREA WILL BE USED.
- EXCEPT AS OUTLINED IN ITEM 4, ALL CONSTRUCTION DEBRIS AND EQUIPMENT MUST BE CONTAINED ON SITE AT ALL TIMES. CONTRACTOR AND PROPERTY OWNER MUST MAINTAIN THE JOB SITE FREE OF LITTER AND UNSIGHTLY MATERIALS AT ALL TIMES. CONSTRUCTION MATERIALS ARE PROHIBITED IN THE TOWN RIGHT-OF-WAY OR NEAR ADJACENT PROPERTIES.
- BUILDING CONSTRUCTION MUST NOT START SOONER THAN SUNRISE AND MUST STOP NO LATER THAN SUNSET. ALSO, ORDINANCE #561 IMPOSES RESTRICTIONS ON CONSTRUCTION WORK ON SATURDAYS, SUNDAYS AND MAJOR BUSINESS HOLIDAYS. HILLSIDE PROJECTS MAY HAVE ADDITIONAL RESTRICTIONS. EQUIPMENT WITH AUDIBLE REVERSE DIRECTION WARNINGS MUST NOT BE OPERATED PRIOR TO 7:00 A.M.
- THE USE AND OPERATION OF FUEL-FIRED GENERATORS ON ANY CONSTRUCTION SITE, NEW, EXISTING OR REMODELING, IS PROHIBITED UNLESS DUE TO A HARSH/TOWN APPROVAL IS OBTAINED.
- THE CONTRACTOR AND PROPERTY OWNER WILL BE LIABLE FOR ANY DAMAGE DONE TO ANY PUBLIC PROPERTY AS A RESULT OF ANY CONSTRUCTION OR CONSTRUCTION RELATED ACTIVITIES. NO CERTIFICATE OF OCCUPANCY WILL BE ISSUED UNTIL ALL AFFECTED RIGHTS-OF-WAY ARE CLEANED AND/OR REPAIRED TO THEIR ORIGINAL CONDITION AND UNTIL ANY AND ALL DAMAGES TO AFFECTED PROPERTIES ARE RESTORED TO ORIGINAL CONDITION, OR UNTIL SUCH TIME THAT A WRITTEN, SIGNED AND LEGALLY BINDING AGREEMENT HAS BEEN REACHED BY THE PARTIES INVOLVED TO REMEDY ANY VIOLATION WITHIN A REASONABLE TIME PERIOD, AND UNTIL ALL REQUIRED FEES ARE PAID IN FULL.
- THE NATURAL FLOW OF RAINWATER AND OTHER SURFACE DRAINAGE FROM THE PROPERTY MAY NOT BE ALTERED IN ANY WAY.
- A KEY SWITCH SHALL BE REQUIRED ON ALL NEW AND EXISTING ELECTRIC ENTRY CONTROL GATES. THE KEY SWITCH SHALL BE INSTALLED IN A LOCATION ON THE GATE CONTROL PANEL THAT IS READILY VISIBLE AND ACCESSIBLE. KNOX BOX ORDER FORMS ARE AVAILABLE AT THE PARADISE VALLEY BUILDING DEPARTMENT.
- ALL EQUIPMENT OF ALL TRADES ON OR AFFECTING THE JOB MUST BE CLEANED ONLY IN A PRE-DETERMINED AND DESIGNATED AREA. DEBRIS AND RUNOFF FROM SAID AREA MAY NOT EXTEND BEYOND THE BUILDING AREA.
- PROPERTY OWNER, BUILDER, OR GENERAL CONTRACTOR WILL BE RESPONSIBLE FOR CONTROLLING DUST FROM THE SITE AT ALL TIMES. ALL MEANS NECESSARY SHALL BE USED BY THE BUILDER OR GENERAL CONTRACTOR TO CONTROL THE EXISTENCE OF DUST CAUSING ACTIVITIES, SUCH AS APPLICATION OF MATERIALS, OR OTHER DUST-CAUSING PRACTICES REQUIRED BY THE CONSTRUCTION PROCESS.
- AN INSPECTION FEE WILL BE CHARGED IF THE INSPECTION IS REQUIRED AS A RESULT OF A CODE VIOLATION.
- FOR DEMOLITION INSPECTION OWNER OR PERMITEE SHALL NOTIFY OSHA FOR ASBESTOS INSPECTION. ALL DEMOLITIONS AND ALL RENOVATION ACTIVITIES THAT WILL DISTURB FRIABLE ASBESTOS CONTAINING MATERIALS MUST BE REPORTED TO THE MARICOPA COUNTY ENVIRONMENTAL SERVICES DEPARTMENT.

PRELIMINARY GRADING & DRAINAGE PLAN

SCHERR RESIDENCE

5416 E DESERT JEWEL DR., PARADISE VALLEY, AZ 85253

LOT 27 - VISTA RICA, A SUBDIVISION PLAT RECORDED IN BOOK 171 OF MAPS, PAGE 28, MCR., LOCATED IN A PORTION OF THE SE 1/4 OF THE SW 1/4 OF THE SE 1/4 OF SECTION 32, T.3N, R.4E OF THE GILA & SALT RIVER BASE AND MERIDIAN, MARICOPA COUNTY, ARIZONA

ENGINEERS NOTES

- MARICOPA ASSOCIATION OF GOVERNMENTS (M.A.G.) UNIFORM STANDARD SPECIFICATIONS AND DETAILS FOR PUBLIC WORKS CONSTRUCTION (LATEST EDITION INCLUDING LATEST REVISION AND CURRENT SUPPLEMENTS THEREOF PER THE LOCAL TOWN OR CITY) ARE INCORPORATED INTO THIS PLAN IN THEIR ENTIRETY.
- ALL WORK REQUIRED TO COMPLETE THE CONSTRUCTION COVERED BY THIS PLAN SHALL BE IN ACCORDANCE WITH THE M.A.G. STANDARD SPECIFICATIONS AND DETAILS AND CURRENT SUPPLEMENTS THEREOF PER THE LOCAL CITY OR TOWN UNLESS SPECIFIED OTHERWISE IN THESE PLANS OR ELSEWHERE IN THE CONTRACT DOCUMENTS. CONTRACTORS SHALL FAMILIARIZE THEMSELVES WITH ALL REQUIRED STANDARD SPECIFICATIONS, DETAILS AND SUPPLEMENTS PRIOR TO BIDDING THE WORK FOR THE CONSTRUCTION COVERED BY THIS PLAN.
- GRADING SHALL BE IN CONFORMANCE WITH 2012 IBC SEC. 1803 AND APPENDIX J.
- 5% MINIMUM SLOPE AWAY FROM BUILDING FOR A MINIMUM 10', U.N.O.
- ALL CONSTRUCTION SHALL CONFORM TO THE LATEST MARICOPA ASSOCIATION OF GOVERNMENTS (M.A.G.) SPECIFICATIONS AND STANDARD DETAILS.
- A DUST CONTROL PLAN MEETING THE REQUIREMENTS OF RULE 310 OF THE MARICOPA COUNTY AIR POLLUTION CONTROL REGULATIONS, AS AMENDED, IS REQUIRED.
- A SEPARATE PERMIT IS NECESSARY FOR ANY OFFSITE CONSTRUCTION.
- AN APPROVED GRADING AND DRAINAGE PLAN SHALL BE ON THE JOB SITE AT ALL TIMES. DEVIATIONS FROM THE PLAN MUST BE PRECEDED BY AN APPROVED PLAN REVISION.
- ALL DRAINAGE PROTECTIVE DEVICES SUCH AS SWALES, INTERCEPTOR DITCHES, PIPES, PROTECTIVE BERMS, BARRIER WALLS, CONCRETE CHANNELS OR OTHER MEASURES DESIGNED TO PROTECT ADJACENT BUILDINGS OR PROPERTY FROM STORM RUNOFF MUST BE COMPLETED PRIOR TO BUILDING CONSTRUCTION.
- ALL STRUCTURES AND LANDSCAPING WITHIN THE SIGHT VISIBILITY TRIANGLE SHALL HAVE A 2 FOOT MAXIMUM HEIGHT.
- ALL PATIOS, WALKS, AND DRIVES TO SLOPE AWAY FROM BUILDING AND GARAGES AT A MINIMUM SLOPE OF 1/4" PER FOOT UNLESS SPECIFIED OTHERWISE. ALL LAWN AREAS ADJOINING WALKS OR SLABS WILL BE GRADED TO 2" BELOW THE TOP OF SLAB. TYPICAL FINISHED GRADE AROUND PERIMETER OF BUILDING IS MINUS 6" BELOW FINISHED FLOOR UNLESS SPECIFIED OTHERWISE.
- ALL MATERIAL TO BE UNDER SLABS AND WALKS SHALL BE COMPACTED TO NOT LESS THAN 95% PER ASTM D698.
- THE QUANTITIES AND SITE CONDITIONS DEPICTED IN THESE PLANS ARE FOR INFORMATIONAL PURPOSES ONLY AND ARE SUBJECT TO ERROR AND OMISSION. CONTRACTORS SHALL SATISFY THEMSELVES AS TO ACTUAL QUANTITIES AND SITE CONDITIONS PRIOR TO BIDDING THE WORK FOR THE CONSTRUCTION COVERED BY THIS PLAN.
- THE CONTRACTOR IS RESPONSIBLE FOR OBTAINING AND COMPLYING WITH ALL PERMITS REQUIRED TO COMPLETE ALL WORK COVERED BY THIS PLAN.
- THE CONTRACTOR IS RESPONSIBLE FOR ALL METHODS, SEQUENCING, AND SAFETY CONCERNS ASSOCIATED WITH THIS PROJECT DURING CONSTRUCTION, UNLESS SPECIFICALLY ADDRESSED OTHERWISE IN THIS PLAN OR ELSEWHERE.
- A REASONABLE EFFORT HAS BEEN MADE TO SHOW THE LOCATIONS OF EXISTING UNDERGROUND FACILITIES AND UTILITIES IN THE CONSTRUCTION AREA. THE CONTRACTOR IS RESPONSIBLE FOR ANY DAMAGE TO UTILITIES AND/OR FACILITIES CAUSED DURING THEIR CONSTRUCTION OPERATIONS. THE CONTRACTOR SHALL CALL 48 HOURS IN ADVANCE FOR BLUE STAKE (1-800-STAKE-IT) PRIOR TO ANY EXCAVATION.
- THE CONTRACTOR IS RESPONSIBLE FOR ALL COORDINATION OF CONSTRUCTION AFFECTING UTILITIES AND THE COORDINATION OF ANY NECESSARY UTILITY RELOCATION WORK.
- ALL PAVING, GRADING, EXCAVATION, TRENCHING, PIPE BEDDING, CUT, FILL AND BACKFILL SHALL COMPLY WITH THE RECOMMENDATIONS SET FORTH IN THE SOILS (GEOTECHNICAL) REPORT FOR THIS PROJECT IN ADDITION TO THE REFERENCED REQUIRED SPECIFICATIONS AND DETAILS.
- THE CONTRACTOR IS TO VERIFY THE LOCATION AND THE ELEVATIONS OF ALL EXISTING UTILITIES AT POINTS OF TIE-IN PRIOR TO COMMENCING ANY NEW CONSTRUCTION. SHOULD ANY LOCATION OR ELEVATION DIFFER FROM THAT SHOWN ON THESE PLANS, THE CONTRACTOR SHALL CONTACT THE OWNER'S AGENT.
- CONTRACTOR TO VERIFY AND COORDINATE ALL DIMENSIONS AND SITE LAYOUT WITH ARCHITECTURE'S FINAL SITE PLAN AND FINAL BUILDING DIMENSIONS BEFORE STARTING WORK. REPORT DISCREPANCIES TO OWNER'S AGENT.
- COORDINATION BETWEEN ALL PARTIES IS ESSENTIAL PART OF CONTRACT.
- CONTRACTOR IS RESPONSIBLE FOR PROJECT AND SITE CONDITIONS, AND TO WORK WITH WEATHER CONDITIONS AS THE PROJECT SITE MAY BE LOCATED IN A FLOOD PRONE AREA AND SUBJECT TO FLOODING AND ITS HAZARDS.
- THE CONTRACTOR IS TO VERIFY THE LOCATION, ELEVATION, CONDITION, AND PAVEMENT CROSS-SLOPE OF ALL EXISTING SURFACES AT POINTS OF TIE-IN AND MATCHING, PRIOR TO COMMENCEMENT OF GRADING, PAVING, CURB AND GUTTER, OR OTHER SURFACE CONSTRUCTION. SHOULD EXISTING LOCATIONS, ELEVATIONS, CONDITION, OR PAVEMENT CROSS-SLOPE DIFFER FROM THAT SHOWN ON THESE PLANS, RESULTING IN THE DESIGN INTENT REFLECTED ON THESE PLANS NOT ABLE TO BE CONSTRUCTED, THE CONTRACTOR SHALL NOTIFY THE OWNER'S AGENT IMMEDIATELY FOR DIRECTION ON HOW TO PROCEED PRIOR TO COMMENCEMENT OF CONSTRUCTION. THE CONTRACTOR ACCEPTS RESPONSIBILITY FOR ALL COSTS ASSOCIATED WITH CORRECTIVE ACTION IF THESE PROCEDURES ARE NOT FOLLOWED.
- CONTRACTOR IS RESPONSIBLE TO COORDINATE UTILITY CROSSINGS AT CULVERT CROSSINGS BEFORE STARTING WORK ON CULVERT. COORDINATE WITH OWNER REPRESENTATIVE. VERIFY UTILITY LINES AND/OR CONDUITS ARE IN PLACE BEFORE STARTING CULVERT WORK.
- ALL ON-SITE UTILITIES PER OTHERS.
- THIS PROJECT REQUIRES A REGULAR ONGOING MAINTENANCE PROGRAM FOR THE DESIGNED DRAINAGE SYSTEM(S) TO PRESERVE THE DESIGN INTEGRITY AND THE ABILITY TO PERFORM ITS OPERATIONAL INTENT. FAILURE TO PROVIDE MAINTENANCE WILL JEOPARDIZE THE DRAINAGE SYSTEM(S) PERFORMANCE AND MAY LEAD TO IT'S INABILITY TO PERFORM PROPERLY AND/OR CAUSE DAMAGE ELSEWHERE IN THE PROJECT.
- IF A DISCREPANCY IS FOUND BETWEEN ENGINEER'S PLAN OR SURVEYOR'S STAKING AND THE ARCHITECTURAL PLAN, ENGINEER SHALL BE NOTIFIED IMMEDIATELY. FAILURE TO NOTIFY ENGINEER SHALL NEGATE ENGINEER'S LIABILITY.
- ALL DISTURBED AREAS ARE TO BE ROPED AND ROPING MUST MATCH PLAN.
- VEGETATION OUTSIDE OF CONSTRUCTION AREA TO REMAIN.
- AREAS OUTSIDE THE WALL AND CUT AND FILL SLOPES SHALL BE REVEGETATED WITH SIMILAR PLANT TYPES AND DENSITIES FOUND ON THE SITE. VEGETATION SHALL BE COMPLETED PRIOR TO OCCUPANCY AND THE ISSUANCE OF A CERTIFICATE OF OCCUPANCY.
- MECHANICAL EQUIPMENT SHALL BE SCREENED TO A MINIMUM OF ONE FOOT ABOVE TOP OF EQUIPMENT.
- ANY FUTURE IMPROVEMENTS SHOWN HEREON SHALL REQUIRE A SEPARATE PERMIT.
- ANY POINTS OF DRAINAGE CONCENTRATION SHOULD BE PROTECTED AGAINST EROSION WITH NATIVE STONE.
- THIS PLAN IS DESIGNED TO SHOW SITE GRADING AND DRAINAGE CONTRACTOR SHALL USE THE ARCHITECTURAL SITE PLAN TO DETERMINE FINAL HOUSE, WALL, STEP, ETC., LOCATIONS AND ELEVATIONS.
- SEE ARCHITECTURAL AND STRUCTURAL PLANS FOR SITE AND RETAINING WALLS LAYOUT, DIMENSIONS, AND DETAILS. TOP OF FOOTING ELEVATIONS SHOWN IN PLAN ARE APPROXIMATE ONLY. ACTUAL TOP OF FOOTINGS TO BE DETERMINED AT TIME OF CONSTRUCTION AND TO BE A MINIMUM OF SIX INCHES BELOW EXISTING NATURAL GRADE OR FINISHED GRADE WHICHEVER IS LOWER (TYPICAL).
- REFER TO ARCHITECTURAL DRAWINGS FOR BUILDING LAYOUT, DIMENSIONS AND ELEVATIONS.
- FOR CHANGE IN ELEVATION THAT ARE GREATER THAN 30", PROVIDE 36" HIGH GUARDRAILS FOR TOTAL OF 42" FALL PROTECTION BARRIER U.N.O.
- CONTRACTOR TO PROVIDE POSITIVE DRAINAGE AWAY FROM STRUCTURE - 5% MIN SLOPE FOR FIRST 10 FEET, U.N.O.
- ALL WATER AND SEWER LINES AND CONNECTIONS MUST BE INSTALLED PER IPC 2012, MAG AND TOWN OF PARADISE VALLEY SUPPLEMENT TO MAG.
- WATERPROOF ALL EXTERIOR WALLS 18" ABOVE FINISH GRADE-(BITUTHENE® 3000 HC MEMBRANE W/ GRACE PROTECTION 03 OR APPROVED EQUAL).
- ALL PIPES AND FITTINGS SHALL BE INSTALLED PER MANUFACTURER'S SPECIFICATIONS AND DETAILS.
- ABANDONMENT OF EXISTING AND INSTALLATION OF NEW SEPTIC SYSTEMS SHALL BE PERFORMED IN ACCORDANCE WITH THE MARICOPA COUNTY ENVIRONMENTAL SERVICES DEPARTMENT RULES AND STANDARDS, AND WILL REQUIRE SEPARATE PERMIT.
- COORDINATE RIPRAP COLOR WITH LANDSCAPE PLANS AND DETAILS.
- VERIFY AND COORDINATE WITH LANDSCAPE PLANS FINAL LOCATION AND GRATE TYPE OF SPECIFIED AREA DRAINS AND TRENCH DRAINS.
- VERIFY AND COORDINATE WITH ARCHITECTURAL AND LANDSCAPE PLANS LOCATION AND HEIGHT OF ALL SITE WALLS.
- DISTURBED AREA: TOTAL ACRES = 1.65 ACRES < 1 ACRE; NPDES PERMIT IS NOT REQUIRED.
- REFER TO ARCHITECTURAL PLANS AND DETAILS FOR DEMOLITION AND REMOVAL OF ANY EXISTING BUILDING STRUCTURES, SITE WALLS, POOL AND PAVEMENT ETC.
- REFER TO GEOTECHNICAL REPORT FOR SPECIFIC RECOMMENDATIONS AND MAXIMUM ALLOWED FILL AND CUT SLOPES.

LEGEND

- FOUND REBAR OR AS NOTED
- SET 1/2" REBAR & TAG OR AS NOTED
- CALCULATED POINT
- PROPERTY LINE
- EASEMENT LINE
- MONUMENT LINE
- W SOWER MANHOLE
- ⊗ WATER METER
- ⊗ WATER VALVE
- ⊕ FIRE HYDRANT
- ↓ SIGN
- TELEPHONE PEDESTAL
- CABLE TV RISER
- CATV, PHONE
- SEWER LINE
- WATER LINE
- ELECTRIC LINE
- COMMUNICATIONS LINE
- GAS LINE
- EXISTING CONTOUR
- EXIST. DRAINAGE FLOW
- EXIST. SPOT ELEVATION
- ☀ CACTUS
- ☀ PALO VERDE TREE
- ROCK OUTCROPPING
- EXISTING DISTURBED AREA
- PROPOSED DISTURBED AREA
- FLOW LINE
- DRAINAGE FLOW ARROW
- PROPOSED SPOT ELEVATION
- PROPOSED CONTOUR
- TOP OF RAILING/NON-RET. WALL
- TOP OF RETAINING WALL
- FINISH GRADE
- TOP OF FOOTING
- FINISH GRADE AT BOTTOM OF WALL
- STORM DRAIN PIPE
- RETAINING WALL/AGAINST BUILDING
- EXTENDED BUILDING STEM WALL
- REVEGETATED AREA

ABBREVIATIONS

- BC BACK OF CURB
- BSL BUILDING SETBACK LINE
- BW BOTTOM OF WALL
- C CONCRETE, CALCULATED
- TPV TOWN OF PARADISE VALLEY
- DE DRAINAGE EASEMENT
- ESMT EASEMENT
- EXIST. EXISTING
- EG EXISTING GRADE
- FG FINISH GRADE
- FFE FINISH FLOOR ELEVATION
- ℓ FLOW LINE
- FND FOUND
- INV INVERT
- MAG MARICOPA ASSOCIATION OF GOVERNMENTS
- M MEASURED
- MCR MARICOPA COUNTY RECORDER
- P PAVEMENT
- PUE PUBLIC UTILITY EASEMENT
- (R) RECORDED
- R RADIUS
- R/W RIGHT OF WAY
- T TANGENT, TELEPHONE
- W WEST, WATERLINE
- TP TOP OF PARAPET
- TC TOP OF CURB
- TG TOP OF GRADE
- TF TOP OF FOOTING
- TR TOP OF RAILING
- TRW TOP OF RETAINING WALL
- TW TOP OF WALL
- WM WATER METER

DISTURBED AREA CALCULATIONS

AREA OF LOT: 43,655 S.F. (1,002 AC.)
 TOTAL FLOOR AREA: 6,409 S.F.
 FLOOR AREA RATIO: 14.68% < 25%
 (TOTAL FLOOR AREA/AREA OF LOT)
 BUILDING PAD SLOPE: 20.7%
 VERTICAL: 31.3'
 HORIZONTAL: 151'
 ALLOWABLE NET DISTURBED AREA: 8,116 S.F. (18.59%)
 GROSS EXISTING DISTURBED AREA: 0 S.F.
 GROSS PROPOSED DISTURBED AREA: 17,594 S.F.
 LESS TEMPORARY AREAS OF DISTURBANCE TO BE RESTORED AND REVEGETATED: 2,372 S.F.
 LESS 25% OF PROP. PAVERS D/W: (4,233 S.F.) 1,058 S.F.
 LESS BUILDING FOOTPRINT AREA: 6,075 S.F.
 PROPOSED NET DISTURBED AREA: 8,089 S.F. < 8,116 S.F.

ALLOWED SLOPES STEEPER THAN NATURAL GRADE (5% MAX.): 2,183 S.F. (5%)
 PROPOSED SLOPES STEEPER THAN NATURAL GRADE (AREA): 2,183 S.F. (5%)
 VOLUME OF CUT: 2,960 C.Y.
 VOLUME OF FILL: 3,359 C.Y.
 TOTAL CUT/FILL: 3,359 C.Y.
 HILLSIDE ASSURANCE @ \$25/CUBIC
 YARD OF CUT/FILL: \$83,975
 ALL QUANTITIES LISTED ON THESE PLANS ARE ESTIMATES ONLY. THE CONTRACTOR SHALL MAKE THEIR OWN DETERMINATION OF THE QUANTITIES AND BASE THEIR BIDS ON THEIR ESTIMATES.

GRADING SPECIFICATIONS

- EXCAVATION AND GRADING OF THIS SITE IS CLASSIFIED AS "ENGINEERED GRADING" PER 2015 I.B.C. AND WILL BE PERFORMED ACCORDINGLY.
- THE CONTRACTOR WILL RETAIN A SOILS ENGINEER DURING CONSTRUCTION TO INSPECT PROGRESS OF CONSTRUCTION, CONCERNING PREPARATION OF GROUND TO RECEIVE FILLS, TESTING AND REQUIRED COMPACTION STABILITY OF ALL FINISH SLOPES INCLUDING CUT SLOPES.
- COMPACTION SHALL COMPLY WITH M.A.G. SECTION 601 AND PROVISIONS AS SET FORTH IN THE SOILS REPORT.
- BEARING MATERIALS FOR FILL UNDER RESIDENCE PAD IF NATIVE MATERIAL IS USED, LARGE ROCK FRAGMENT MUST BE REMOVED THAT ARE IN EXCESS OF SIX INCHES. REMAINING MATERIAL MUST BE SMALLER PARTICLES OF SAND AND ROCK THAT CAN BE COMPACTED INTO A DENSE CONDITION.
 MAXIMUM PARTICLE SIZE: 6 INCHES
 PERCENT PASSING NO. 4 SIEVE: 35% TO 70%
 PERCENT PASSING NO. 200 SIEVE: 25% MAX.
 PLASTICITY INDEX: 10% MAX.
- CUT-SLOPES: MAXIMUM ROCK CUT SLOPE TO BE 1.0 FEET HORIZONTAL TO 3.0 FEET VERTICAL PER GEOTECHNICAL STUDY.
- FILL SLOPES: MAXIMUM FILL SLOPE TO BE 2.0 FEET HORIZONTAL TO 1.0 FEET VERTICAL.
- COMPACTION FILL MATERIAL MUST BE PLACED ON LEVELED BENCHES CUT INTO UNDISTURBED EXISTING HILLSIDE. PLACE FILL IN HORIZONTAL LIFTS OF THICKNESS COMPATIBLE WITH THE COMPACTION EQUIPMENT USED. COMPACT TO A MINIMUM OF 95 PERCENT OF THE MAXIMUM A.S.T.M. DENSITY AT THE OPTIMUM MOISTURE CONTENT OF ± TWO PERCENT. THIS PERTAINS TO ALL ENGINEERED STRUCTURAL FILL SUPPORTING STRUCTURES AND INCLUDING FILL UNDER ANY OF THE RETAINING WALLS. COMPACTION TEST RESULTS SHALL BE SUBMITTED TO THE SOILS ENGINEER AND TOWN OF PARADISE VALLEY BUILDING AND SAFETY DEPARTMENT.
- ANY RETAINING WALLS ADJACENT TO THE PROPERTY LINES WILL BE UNDER THE SCOPE OF SPECIAL INSPECTION BY THE SOILS ENGINEER. THE DEVELOPER SHALL NOTIFY THE ADJOINING PROPERTY OWNERS IN WRITING, TEN DAYS PRIOR TO START OF CONSTRUCTION ON THESE WALLS PER SECTION 2903-B OF IBC. THE DEVELOPER WILL HAVE TO PROVIDE MEANS OF PROTECTION OF ADJACENT PROPERTY WHILE THIS WORK IS UNDER CONSTRUCTION.
- ALL EXPOSED CUT AND FILL SHALL BE TREATED WITH AN APPROVED AGING AGENT TO MINIMIZE TO VISUAL CONTINUITY.
- NO CERTIFICATE OF OCCUPANCY SHALL BE ISSUED UNTIL ALL HILLSIDE STIPULATIONS AND ALL TOWN CODE REQUIREMENTS ARE COMPLIED INCLUDING, BUT NOT LIMITED TO LANDSCAPING, GROUND RESTORATION, FIRE FLOW, FIRE SAFETY AND ALL ONSITE AND OFFSITE IMPROVEMENTS.
- ALL OUTDOOR LIGHTING SHALL BE IN CONFORMANCE WITH ARTICLE XXII OF THE TOWN ZONING ORDINANCE.
- ALL EXCESS FILL MATERIAL SHALL BE REMOVED FROM THE SITE WITH NO NEW SPILL SLOPES.
- THE USE OF HYDRAULIC RAM HAMMERS, OR OTHER HEAVY EQUIPMENT USED TO CUT THROUGH ROCK, INCLUDING MACHINERY WITH AUDIBLE BACK UP WARNING DEVICES SHALL BE LIMITED TO USE BETWEEN THE HOURS OF 7:00AM OR SUNRISE, WHICHEVER IS LATER, AND 6:00PM OR SUNSET, WHICHEVER IS EARLIER, MONDAY THROUGH FRIDAY, WITH LIMITED WORK ON SATURDAY AND NO WORK ON SUNDAY OR LEGAL HOLIDAYS.
- CONSTRUCTION STAKING AND/OR FENCING SHALL BE PLACED AROUND THE CONSTRUCTION SITE SO AS TO PROTECT THE UNDISTURBED NATURAL AREAS.

ON-SITE RETENTION FOR THE PRE VS. POST DEVELOPMENT RUNOFF FROM 100-YEAR, 2-HOUR STORM EVENT

$V = D \times A \times (C_w - 0.75) / 12$

D = RAINFALL DEPTH=2.82" | A = TRIBUTARY AREA, SF | C_w = WEIGHTED RUNOFF COEFFICIENT

DRAINAGE AREA	AREA S.F.	RUNOFF COEFFICIENT C	VOLUME REQUIRED C.F.	RETENTION TYPE	VOLUME PROVIDED C.F.
A	43,655	0.79	410	(2) - 20' DEEP (48" DIA) DRYWELLS	502
TOTAL			410		502

WEIGHTED RUNOFF COEFFICIENT, C_w AREA A

SURFACE TYPE	RUNOFF COEFFICIENT C	AREA SF	C*AREA
ROOF	0.95	6,665	6,332
PAVEMENT	0.95	1,464	1,391
PERMEABLE PAVEMENT	0.75	3,588	2,691
LANDSCAPE	0.75	31,938	23,954
TOTAL		43,655	34,367
$C_w = C * AREA / TOTAL AREA$			0.79

EARTHWORK QUANT.


CUT: 2,360 C.Y.
 FILL: 999 C.Y.
 NET CUT: 1,360 C.Y.

ALL QUANTITIES LISTED ON THESE PLANS ARE ESTIMATES ONLY. NO SHRINK OR SWELL IS ASSUMED. THE CONTRACTOR SHALL MAKE THEIR OWN DETERMINATION OF THE QUANTITIES AND BASE THEIR BIDS ON THEIR ESTIMATES.

RETAINING WALL UNITS

ID NUMBER	MAX. HEIGHT		LENGTH
	FT	FT	
1	4.5	93.00	
2	8.0	77.00	
3	8.0	28.00	
4	8.0	59.00	
5	8.0	59.00	
6	4.0	34.00	
7	8.0	65.00	
TOTAL		415.00	

FOR LOCATIONS IDENTIFIED WITH KEYNOTE
 MAXIMUM LENGTH OF RETAINING WALLS VISIBLE FROM ANY POINT ON THE PROPERTY LINE = 258' < 300'.
 ALL WALL LENGTHS LISTED ABOVE ARE FOR PERMITTING PURPOSES ONLY. CONTRACTOR IS RESPONSIBLE FOR VERIFYING ACCURACY OF WALL QUANTITIES AS SHOWN. REFER TO ARCHITECTURAL AND STRUCTURAL PLANS AND DETAILS FOR WALL CONSTRUCTION, HEIGHT AND FINISH.

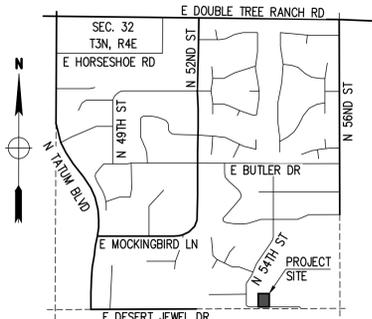

VICINITY MAP
NTS

OWNER

JASON SCHERR
 6843 LOST GARDEN TER
 PARKLAND, FL 33076

ARCHITECT

KENDLE DESIGN COLLABORATIVE
 6115 N CATTLETRACK ROAD
 SCOTTSDALE, AZ 85250
 P: 480 951 8558

SITE DATA

APN: 168-75-029
 ADDRESS: 5416 E DESERT JEWEL DR
 PARADISE VALLEY, AZ 85253
 ZONING: R-43
 LOT AREA: 43,655 S.F. (1,002 AC.)

LEGAL DESCRIPTION

LOT 27, OF VISTA RICA, ACCORDING TO THE PLAT OF RECORD IN THE OFFICE OF THE COUNTY RECORDER OF MARICOPA COUNTY, ARIZONA, RECORDED IN BOOK 171 OF MAPS, PAGE 28.

CONTAINING 43,655 S.F. (1,002 AC.); MORE OR LESS.

BASIS OF BEARINGS

THE SOUTH LINE OF LOTS 26,27 AND 28 BASED ON THE FOUND MONUMENTATION SHOWN ON THE SURVEY , THE BEARING OF WHICH IS N89°49'14"E, PER PLAT OF VISTA RICA, BOOK 171, PAGE 28, MCR.

BENCHMARK

BRASS CAP FLUSH AT THE INTERSECTION OF MOCKINGBIRD LANE AND 56TH STREET HAVING AN ELEVATION OF 1349.97 TOWN OF PARADISE VALLEY (NAVD 88) DATUM, GDACS# 26101-1

UTILITIES

WATER: CITY OF PHOENIX
 SANITARY SEWER: TOWN OF PARADISE VALLEY
 ELECTRIC: ARIZONA PUBLIC SERVICE
 TELEPHONE: CENTURY LINK, COX COMMUNICATIONS
 NATURAL GAS: SOUTHWEST GAS
 CABLE TV: CENTURY LINK, COX COMMUNICATIONS

SHEET INDEX

SHEET C-1 - COVER SHEET
 SHEET C-2 - GRADING & DRAINAGE PLAN

FLOOD INSURANCE RATE MAP (FIRM) DATA

COMMUNITY #	PANEL #	SUFFIX	BASED FLOOD ELEVATION
040049	1765 OF 4425	L	N/A
MAP #	PANEL DATE	ZONE	N/A
04013C	10/16/2013	X*	

*AREAS DETERMINED TO BE OUTSIDE THE 0.2% ANNUAL CHANCE FLOODPLAIN


DRAINAGE STATEMENT

- ULTIMATE STORM OUTFALL IS LOCATED AT THE NORTHWEST PROPERTY CORNER AT ELEVATION OF 1413.70.
- A NEW SINGLE FAMILY RESIDENCE AND POOL IS PROPOSED FOR THIS SITE.
- PROPOSED DEVELOPMENT DOES NOT IMPACT DRAINAGE CONDITIONS OF ADJOINING LOTS.
- HISTORIC DRAINAGE PATTERNS ARE PRESERVED.
- PERMEABLE PAVERS ARE PROVIDED FOR THE PROPOSED DRIVEWAY TO REDUCE THE STORMWATER FLOW TO PRE-DEVELOPMENT CONDITIONS.
- THE MINIMUM FINISH FLOOR ELEVATIONS SHOWN ARE SAFE FROM INUNDATION DURING A 100-YEAR PEAK RUN-OFF EVENT IF CONSTRUCTED PER APPROVED PLANS.

UTILITIES NOTES

HORIZONTAL AND VERTICAL LOCATIONS OF ALL EXISTING UTILITIES SHOWN ON THE PLAN ARE APPROXIMATE ONLY AND WILL BE FIELD VERIFIED BY CONTRACTOR PRIOR TO START OF CONSTRUCTION WORK. CALL BLUE STAKE @ (602) 263-1100.

FIRE SPRINKLER SYSTEM

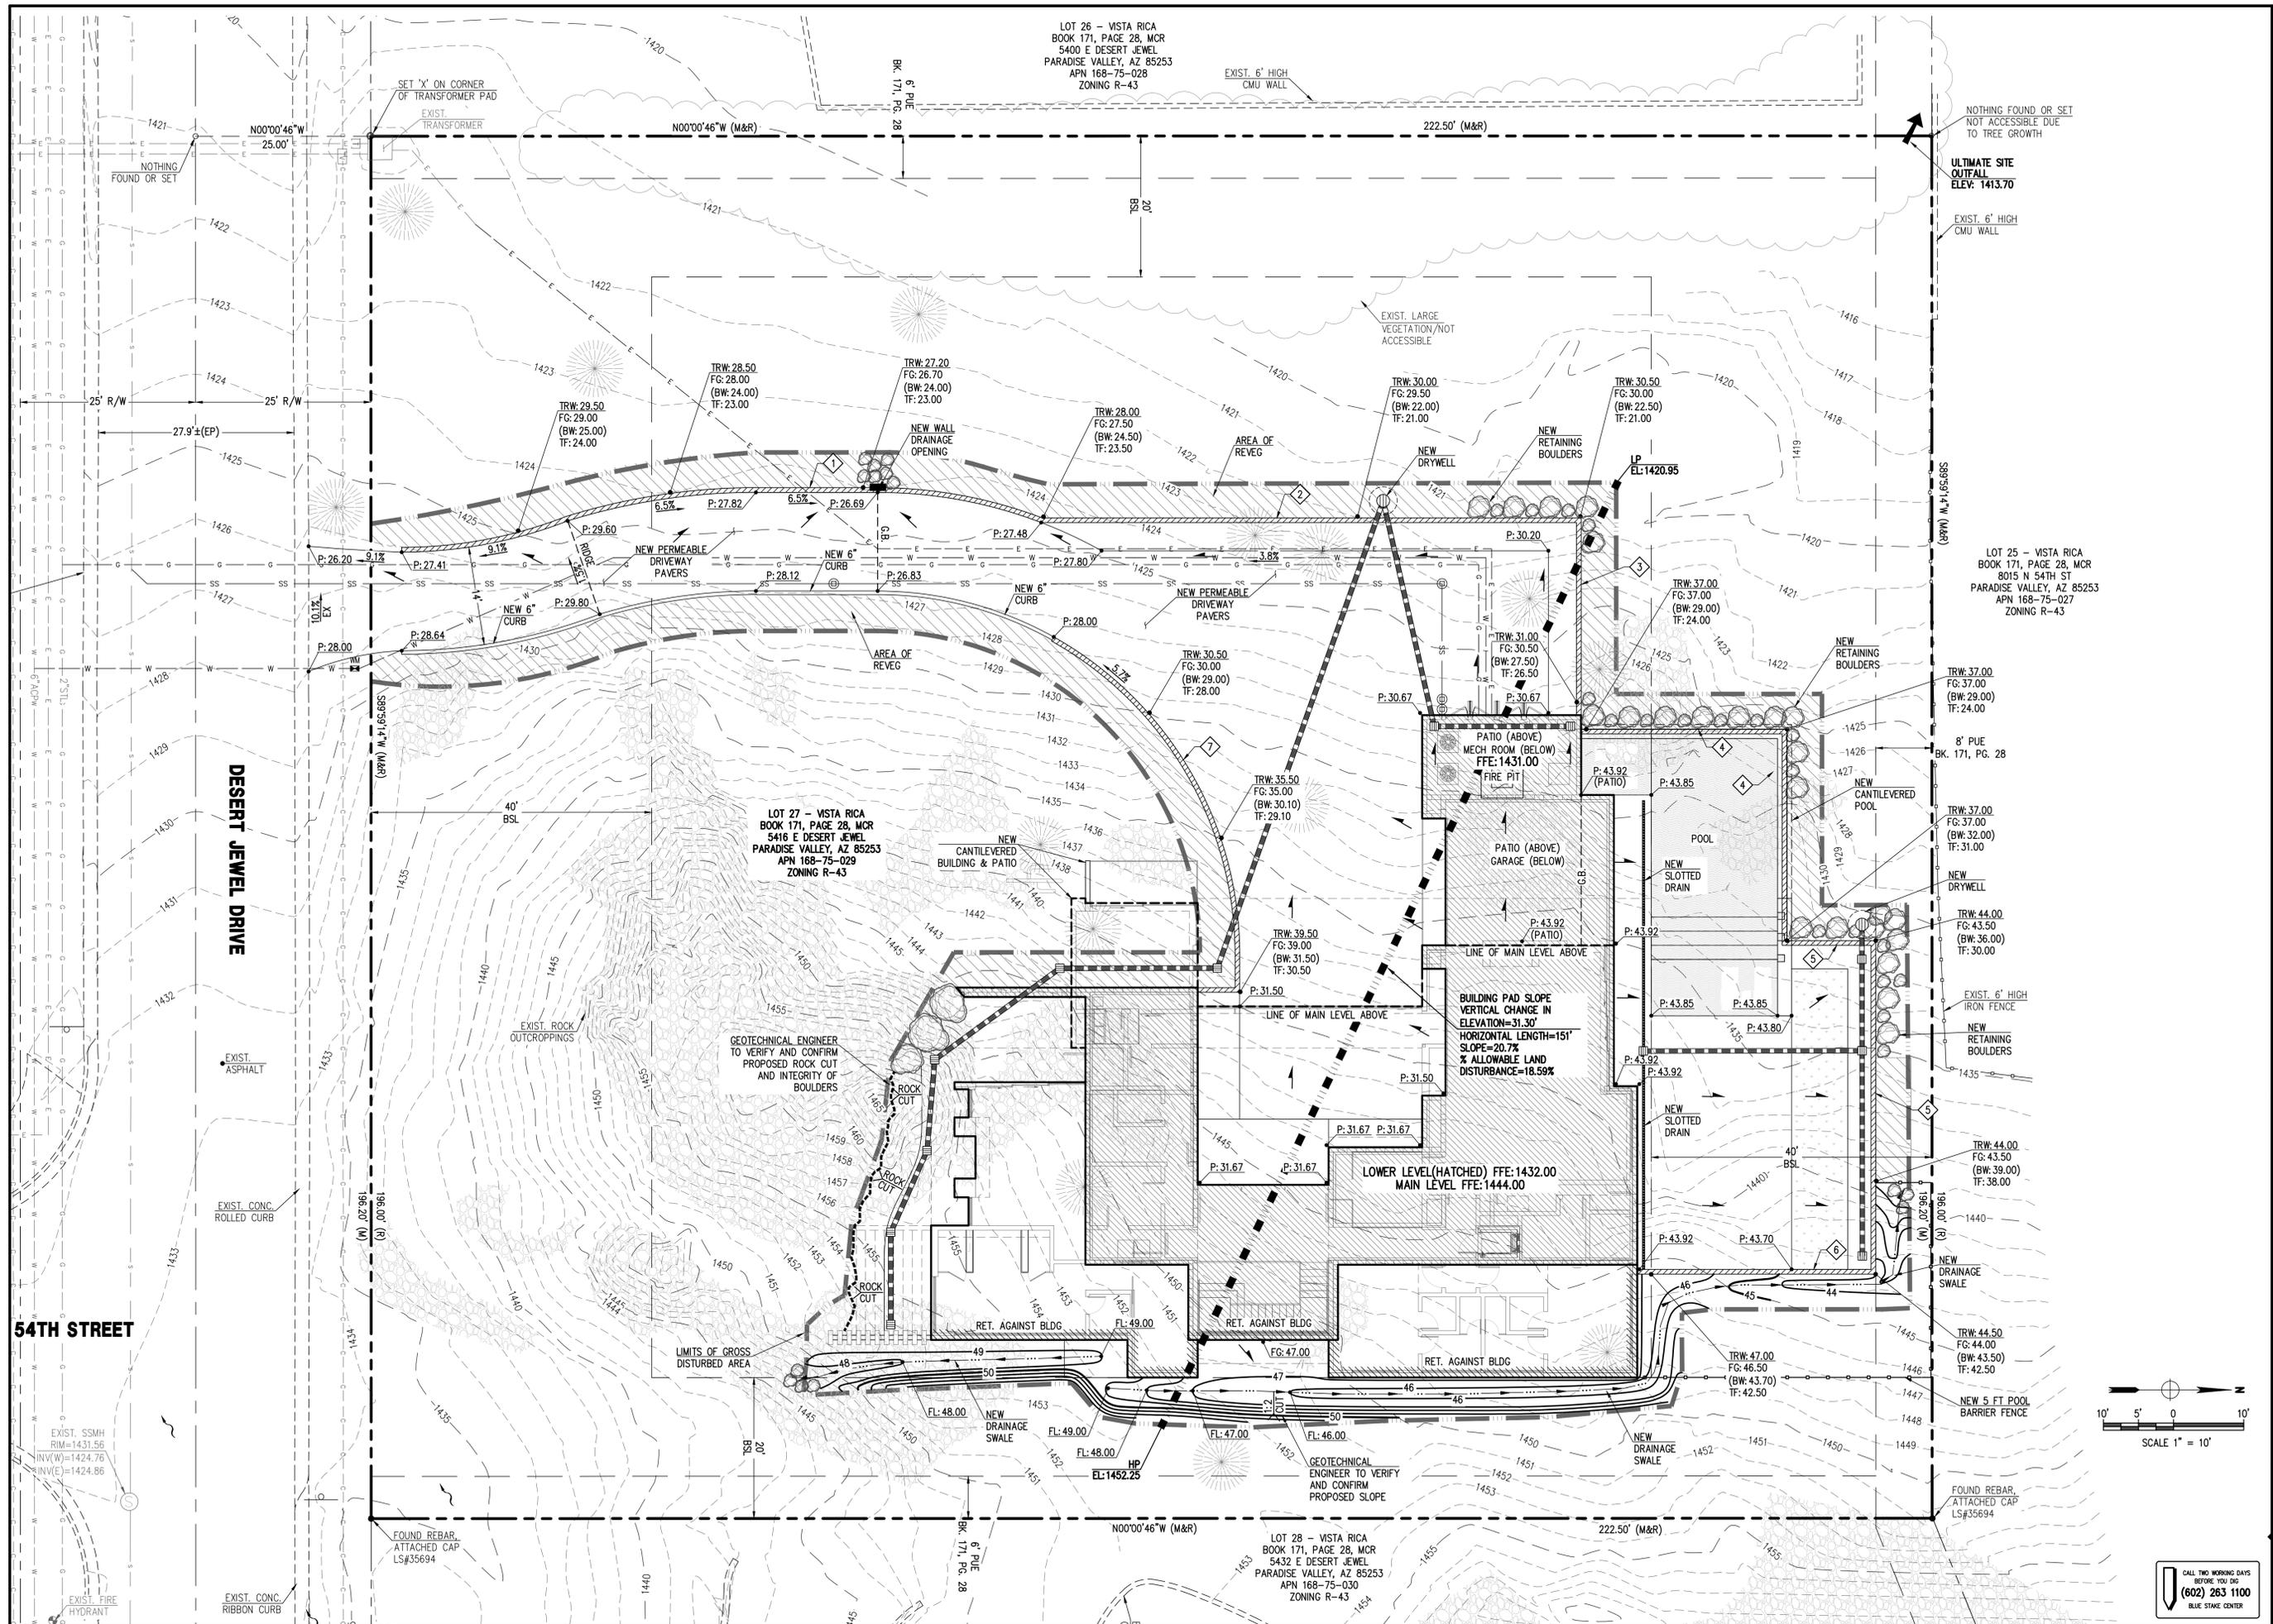

DATE:	09/18/17
DESIGNED BY:	NP
DRAWN BY:	DW
CHECKED BY:	JJ
DATE:	09/18/17

REVISIONS:

SCALE: 1"=10'

DATE: 09/18/17

DESIGNED BY: NP

DRAWN BY: DW

CHECKED BY: JJ

DATE: 09/18/17

PRELIMINARY GRADING & DRAINAGE PLAN

SCHERR RESIDENCE
5416 E DESERT JEWEL DR
PARADISE VALLEY, AZ 85253

P 602 889 1984 | F 602 445 9482
 8808 N CENTRAL AVE., SUITE 288
 PHOENIX, AZ 85020
 PHOENIX @ LDENCO.COM



land DEVELOPMENT GROUP

PRELIMINARY CONSTRUCTION

CALL TWO WORKING DAYS BEFORE YOU DIG
 (602) 263 1100
 BLUE STAKE CENTER

C-2

2 OF 2

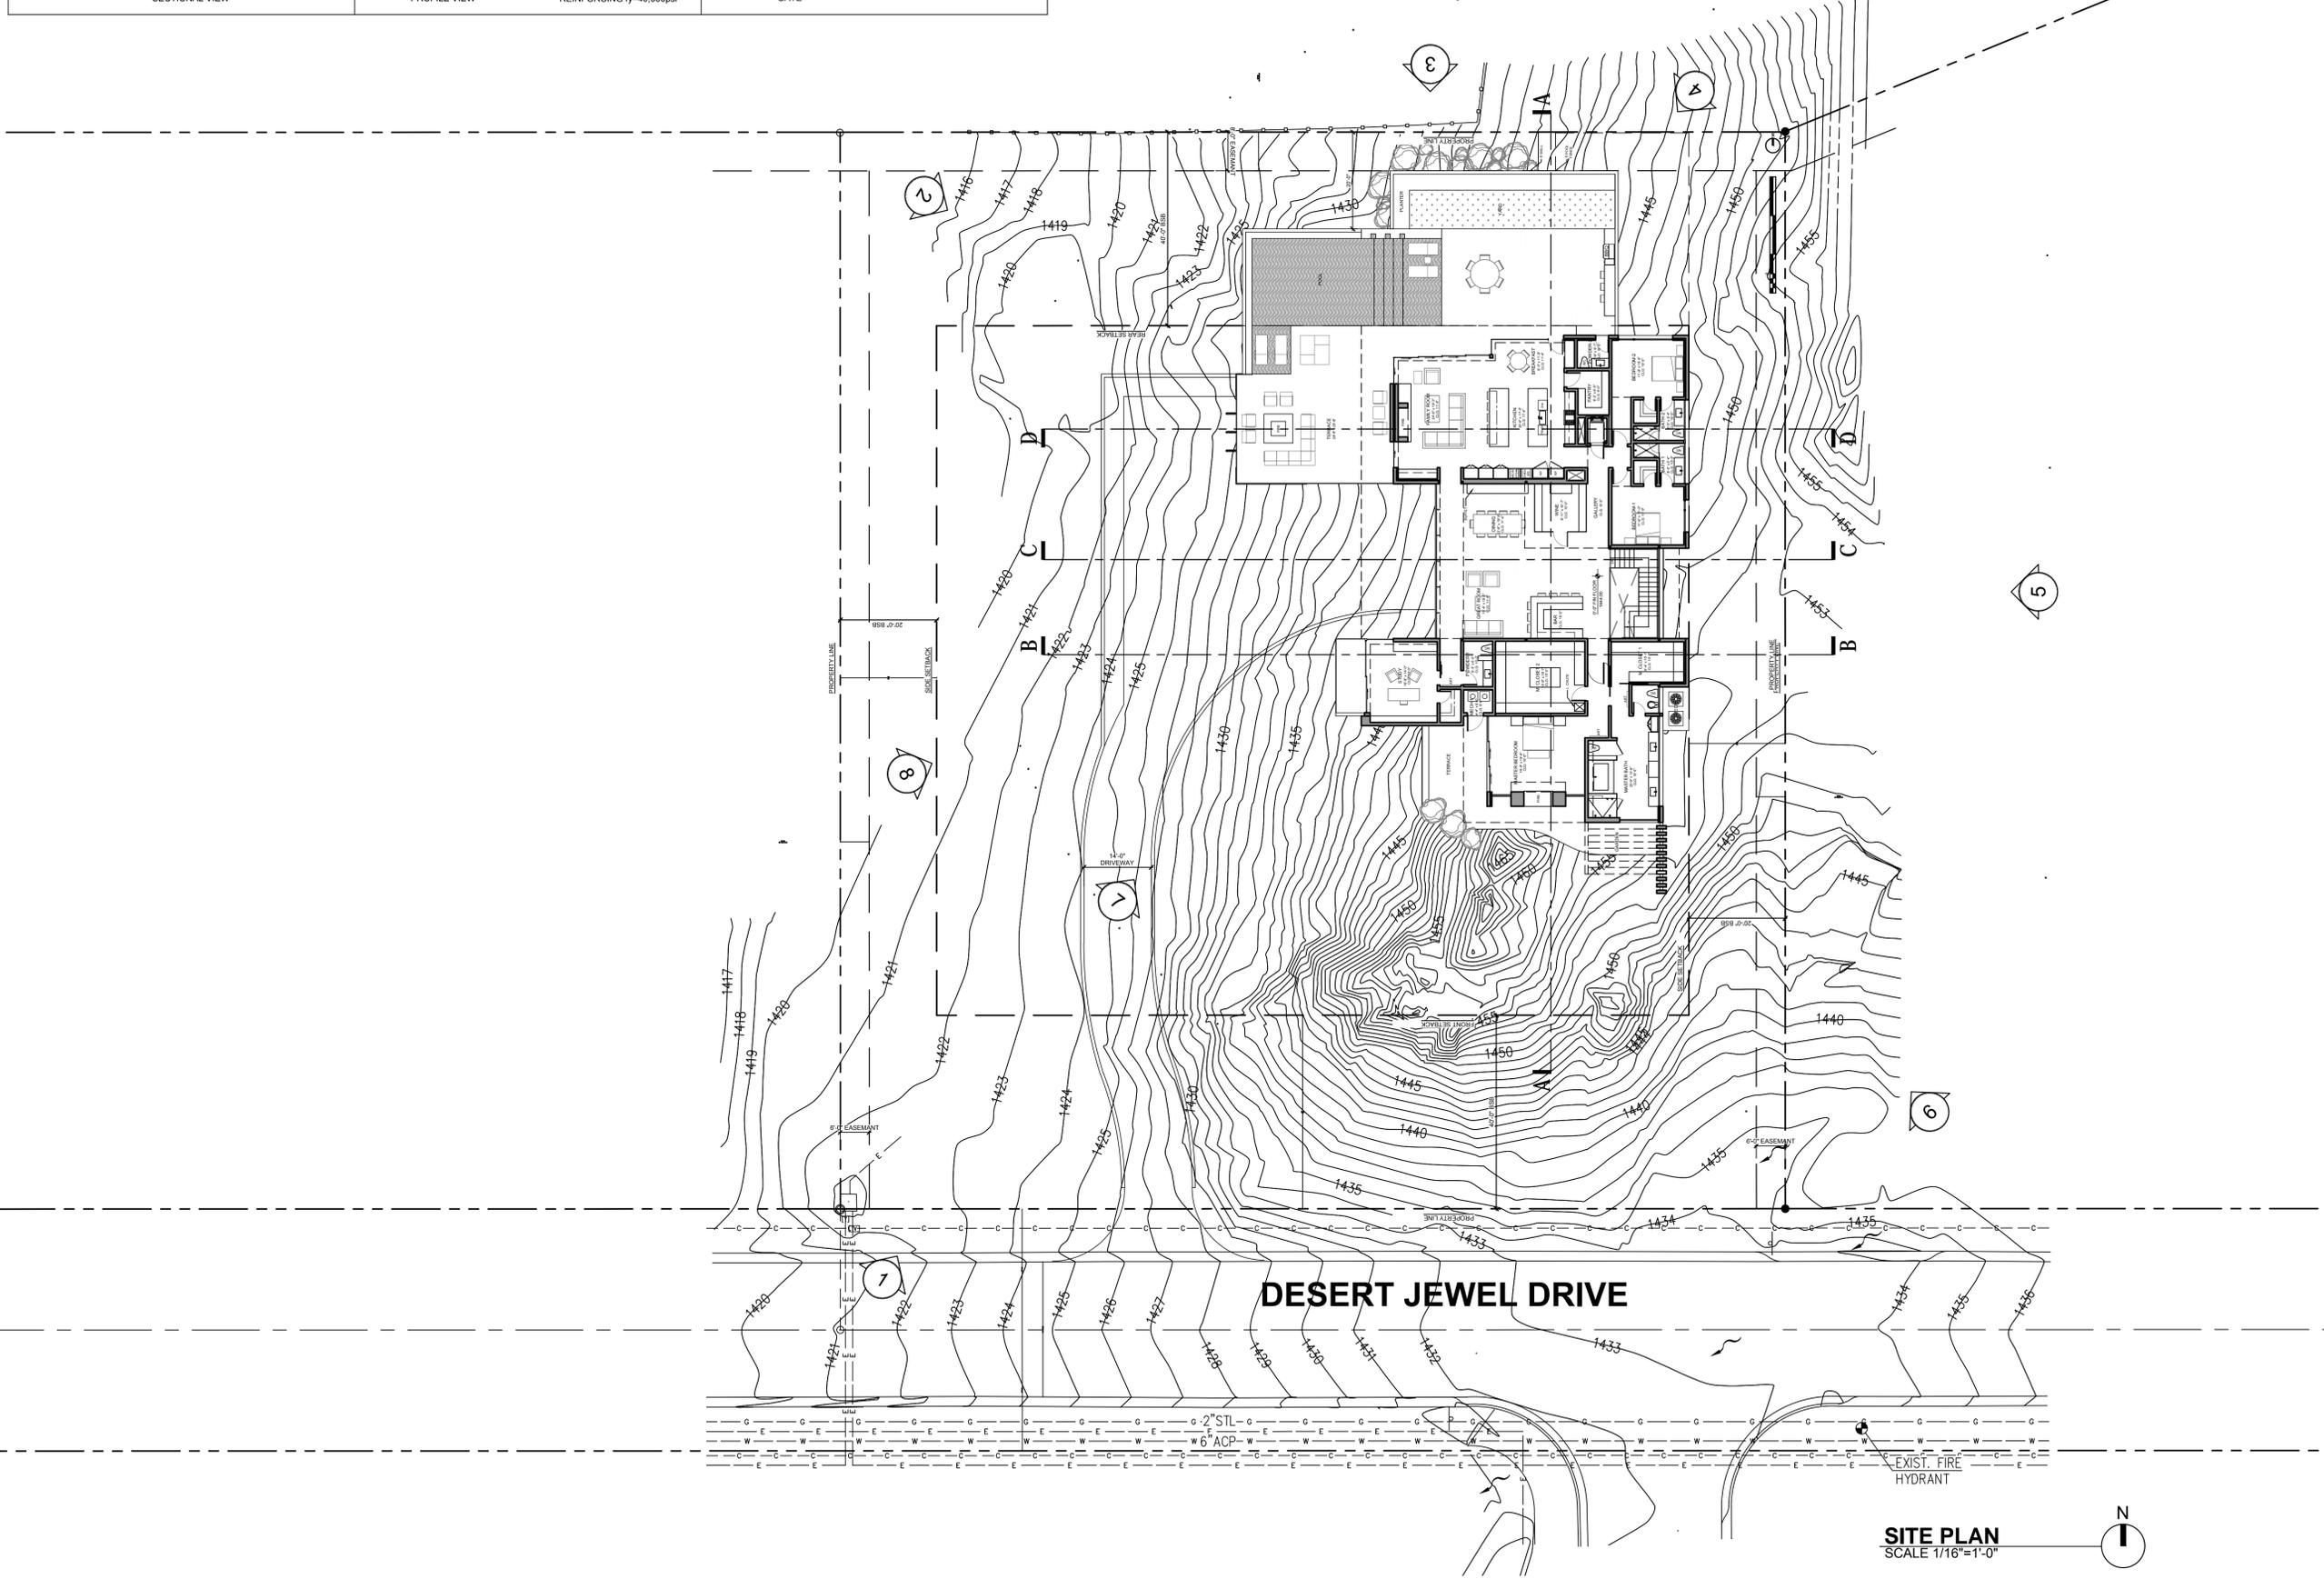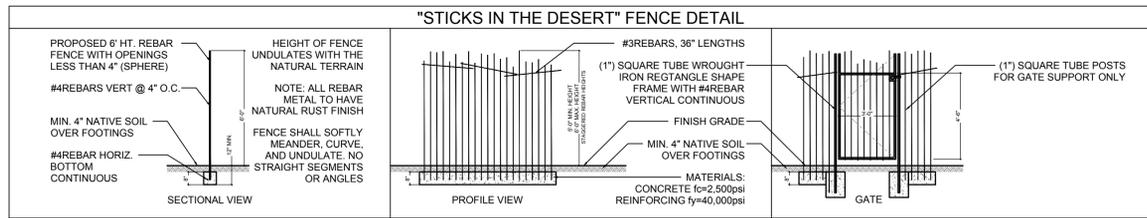

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Scherr Residence

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85253

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SHEET TITLE:

SITE PLAN

A-1.0



IMAGE 1



IMAGE 2



IMAGE 3



IMAGE 4



IMAGE 5



IMAGE 6



IMAGE 7



IMAGE 8



IMAGE 9



IMAGE 10



IMAGE 11



IMAGE 12




IMAGE 13



IMAGE 14



IMAGE 15

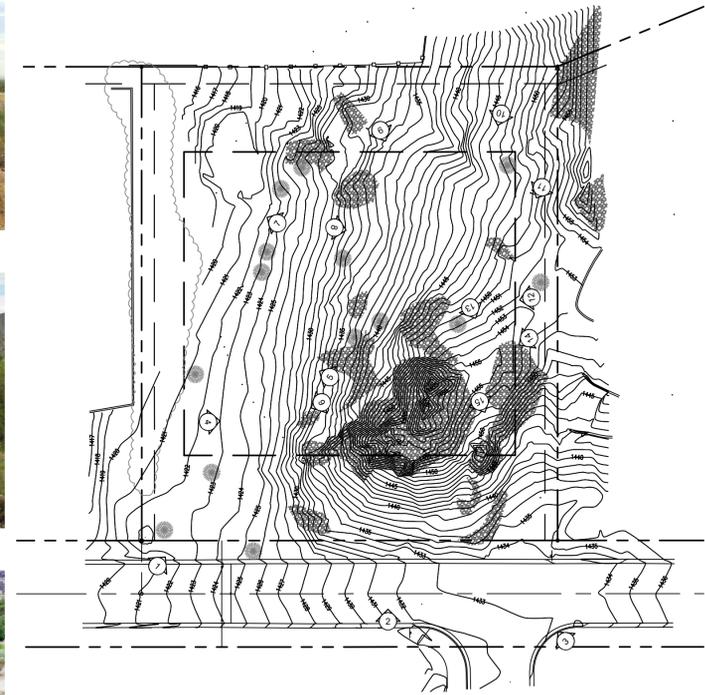

KEY PLAN

1/40 40 80 160 240



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RENDERING & SITE PHOTOS

A-2.0




RENDERING

NTS


BUILDING LIGHTING FIXTURE SCHEDULE

TYPE	QTY	MFR	DESCRIPTION	LUMENS	WATTAGE
1	4	BEGA	BEGA K35 - 3500K COLOR TEMPERATURE	146 LM	2.3 W
2	2	CSL	LED STEPLIGHT, BRONZE SERIES SS3008-BZ	120 LM	3 W
3	26	JUNO	4" IC 700 LUMEN INTERNALLY ADJUSTABLE LED DOWN LIGHT	700LM	11.5 W
4	3	SORAA	SORAA MR16 9W - 2700K COLOR TEMPERATURE	590 LM	9W

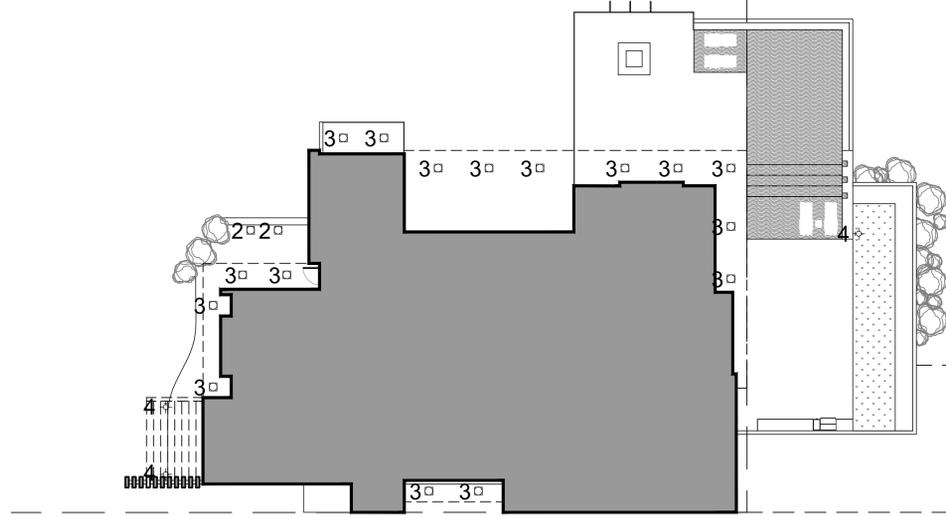

EXTERIOR LIGHTING - MAIN LEVEL PLAN

1/16 16 32 64 128

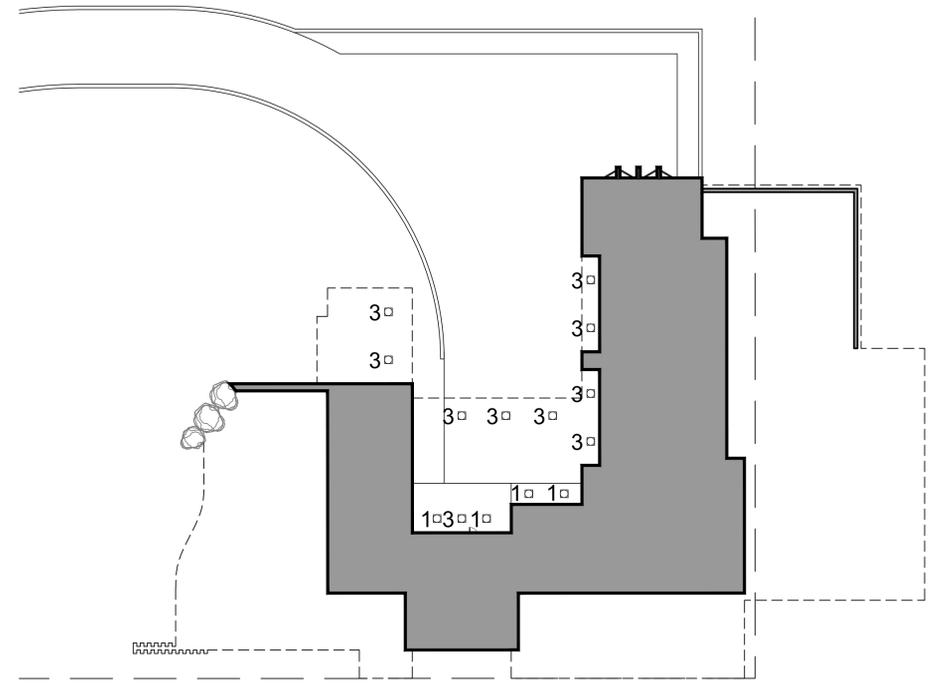

EXTERIOR LIGHTING - LOWER LEVEL PLAN

1/16 16 32 64 128



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85253

Small scale in-grade luminaires
STAINLESS STEEL for LEDs

Housing: Constructed of one-piece cast stainless steel.
Enclosure: Tempered clear safety glass, machined to fit flush with the stainless steel faceplate. Faceplate is secured by four (4) captive flat head stainless steel screws and is machined to fit flush to mounting surface. Pure anodized aluminum reflector. One-piece molded U-channel, high temperature silicone rubber gasket for weather tight operation.
Electrical: 2.5W LED luminaire on a 24V DC circuit, 3.2 total system watts. Remote 24V DC driver required. Standard LED color temperature is 4000K with an 85 CRI. Available in 3000K (80 CRI); add suffix K3 to order. Pre-wired with ten (10) feet of 12 AWG wire and waterproof cable gland entry into housing.
Note: LEDs supplied with luminaires. Due to the dynamic nature of LED technology, LED luminaire data on this sheet is subject to change at the discretion of BEGA-US. For the most current technical data, please refer to www.bega-us.com.
Finish: Machined #4 brushed stainless steel. Custom colors are not available.

Type: BEGA Product: Project: Voltage: Color: Options: Modified:

Luminaire Lumens: 146
Tested in accordance with LM-79-08



Symmetrical floodlight - clear safety glass

model	beam	h	A	B	C
7701P*	2.5W LED	20"	0	1 1/2"	2 1/2"

h = beam angle * Remote driver required

BEGA-US 1000 BEGA Way, Carpinteria, CA 93013 (805) 684-0533 FAX (805) 566-9474 www.bega-us.com
Copyright BEGA-US 2016 Updated 02/16

LED Steplight
2.5" Width
Integral 120V Driver

Fixture

- Cree XP-E LEDs
- 2850°K ±100°K, 80 CRI, 120 lm
- Integral 120V input driver
- Diecast aluminum
- UL/UL Listed for wet location


Finishes

- BZ: Bronze
- SM: Silver Metallic
- WT: White

Mounting

- Fits in standard single-switch box; also available in a 2" x 3" handy box configuration
- Step- and wall-mount applications

SS3008 Series
3W 120lm

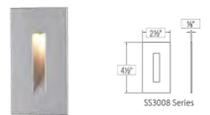

2.5" Width

- 1 - 2.5W Cree XP-E LEDs
- 700mA, 2850°K ±100°K, 80 CRI, 120 lm
- Integral 120V input driver

- SS3008-BZ Bronze 2 1/2" w x 4 1/2" h x 1 1/2" d
- SS3008-SM Silver Metallic 2 1/2" w x 4 1/2" h x 1 1/2" d
- SS3008-WT White 2 1/2" w x 4 1/2" h x 1 1/2" d

2" x 3" Handy Box Option

Fixtures may be ordered to fit the handy box - add "2x3" to the end of the part number.

- SS3008-SM-2x3 Sample part number

Project _____
Fixture Type _____
Location _____
Contact _____
Phone _____



A Division of Troy-CSL Lighting, Inc. 14508 Nelson Avenue · City of Industry CA 91744 Tel: 626.336.4511 Fax: 626.330.4266 www.cslighting.com
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Juno

Project: _____
Fixture Type: _____
Location: _____
Contact/Phone: _____

PRODUCT DESCRIPTION

Patent pending dedicated LED, Air-Loc® sealed new construction housing with integral internally adjustable light engine • Double wall, shallow housing construction • Can be completely covered with insulation and installed in 2" x 2" construction • Fully sealed housing stops infiltration and exfiltration of air, reducing heating and cooling costs without the use of additional glass or LED's sealed housing to provide 50,000 hours of life • 5 year limited warranty on LED components

ENVIRONMENTALLY FRIENDLY, ENERGY EFFICIENT

- No harmful ultraviolet or infrared wavelengths
- No lead or mercury, RoHS compliant
- Compatible light output to 40W incandescent

PRODUCT SPECIFICATIONS

LED Light Engine LED array attached to cast aluminum sliding heat sink integrated directly with housing provides superior heat transfer to ensure long life of the LED • Replaceable light engine mounts directly to inner housing assembly and incorporates the latest generation, high lumen output LED array • LEDs are binned within a 3 step MacAdam Ellipse exceeding ENERGY STAR requirements for superior fixture to fixture color uniformity • 2700K, 3000K, 3500K, or 4000K color temperatures available • 90 CRI minimum

Optics Three field interchangeable, TR optics available in 18°, 30° and 45° beam angles • Module can accommodate one 2-inch diameter beam control lens or filter • Adjustable light engine module provides up to 35° vertical adjustment and 360° rotation

Aesthetic Trim Selections Exclusive trim design to cover slope ranges from 9/24 (40%) and 20/35 (48%) • Aluminum angled reflector in clear, black, granite, white, haze and wheel house • Shadow free, knife edge design blends seamlessly into ceiling

LED Driver Choice of dedicated 120 volt (120V) driver or universal voltage (UVOLT) driver that accommodates input voltages from 120V/277 volt AC 50/60Hz • Power factor > 0.9 @ 120V input • 120 volt only driver is dimmable with the use of most incandescent, magnetic low voltage and electronic low voltage wall box dimmers • Universal voltage driver is dimmable with the use of most 0-10V wall box dimmers • For a list of compatible dimmers, see www.cslighting.com

Life Rated for 50,000 hours at 70% lumen maintenance

Labels ENERGY STAR® Certified • Certified to the high efficacy requirements of California TSS 48020 for UL listed U.S. and Canada for through-branch wiring, damp locations • Union made • UL and cUL

Testing All reports are based on published industry procedures; field performance may differ from laboratory performance. Specifications subject to change without notice.

HOUSING FEATURES
Housing Designed for use in IC (insulated ceiling) or non-IC construction • Aluminum housing sealed for Air-Loc® compliance • Housing is vertically adjustable to accommodate up to a 1 1/2" ceiling thickness


Junction Box Pre-wired junction box provided with (6) 1/4" and (1) 1/2" knockouts (4) knockouts for 12" or 14" 2" cable and ground wire • UL listed and cUL listed for through-branch wiring, maximum # 12 branch circuit conductors • Junction box provided with removable access plates • Knockouts equipped with pryout slots • Quick connect electrical connectors supplied as standard for fast, secure installation

Mounting Frame 22-gauge die-formed galvanized steel mounting frame • Toughen section (junction box, mounting frame, housing and bar hangers) fully assembled for ease of installation

Real Nail 3 Bar Hangers Patented US Patent 6,853,249
Real Nail 3 Bar Hangers - Mounting system permits quick placement of housing anywhere within 24" O.C. (joist or suspended ceiling) • Includes removable nail for repositioning of fixture in wood joist construction • Integral 1/4" bar notch and clip for suspended ceilings

Acuity Brands 1300 S. Wall Road • Des Plaines, IL 60018 • Phone (847) 827-0980 • Fax (847) 827-2025 • Visit us at www.acuitybrands.com/unintended
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4" IC 700 LUMEN INTERNALLY ADJUSTABLE LED DOWNLIGHT NEW CONSTRUCTION IC4AI (07LM) RECESSED HOUSING SLOPE CEILING TRIMS

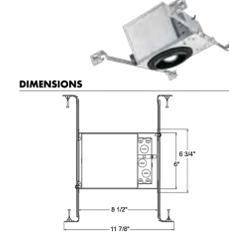

ELECTRICAL DATA

Dedicated 120V Only Driver Option (120)		120V	
Input Power	16.5W (12.5%)		
Input Current	0.10A		
Frequency	50/60Hz		
EMF/RFI	ICC Title 41 CFR, Part 15, Class B (Residential)		
Minimum Starting Temp 25°C (77°F)			
Universal Voltage Driver (UVOLT 27)		277V	
Input Power	16.0W (12.5%)	16.0W (12.5%)	
Input Current	0.09A	0.09A	
Frequency	50/60Hz	50/60Hz	
EMF/RFI	ICC Title 41 CFR, Part 15, Class A (Commercial)	ICC Title 41 CFR, Part 15, Class A (Commercial)	
Minimum Starting Temp 25°C (77°F)			
Lumen H/Lume- LED Driver (MVOLT ECOS3)		277V	
Input Power	11.0W (12.5%)	11.0W (12.5%)	
Input Current	0.10A	0.09A	
Frequency	50/60Hz	50/60Hz	
EMF/RFI	ICC Title 41 CFR, Part 15, Class A (Commercial)	ICC Title 41 CFR, Part 15, Class A (Commercial)	
Minimum Starting Temp 25°C (77°F)			

ZX16-SQ

Area Accent • ZX16 Series



Characteristics

- Used
- Standard
- Wet/Dry location rated • Swivel Stem 1 facilitates 335° deg. rotation for aiming precision on any installation plane.

Technical Data

Material Housing/Cap/Strm - Machined silicone magnesium aluminum alloy (6061-T6) resistant to corrosion
Socket Stainless steel (SS304) hardware

Lamp Halogen MR16



Dimmability MLV, ELV

Socket BI-pin, G4

Voltage 12V

Wattage 50W

Power Supply Requires remote step down transformer

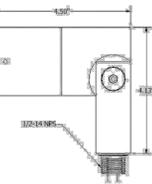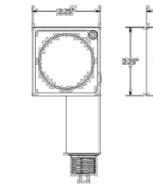

HK USA Lighting Group 3529 Old Conejo Road #118 Newbury Park CA 91320 TEL 805 480 4881 FAX 805 480 4811 sales@hklightinggroup.com

HK USA Lighting Group

PROJECT _____

FIXTURE TYPE _____

Ordering Guide

Series	ZX16-SQ
Glare Shields (optional)	GSA (Inq)
Barndoors	BD
Voltage	12V
Wattage	50W
Lamp	Halogen MR16
Socket	BI-pin G4
Stem (optional)	FSS
Finish	BR (Black) BZ (Bronze) WT (White) ABK (Anodized black) AC (Anodized clear) CC (Custom)

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EXTERIOR BUILDING LIGHTING PLAN


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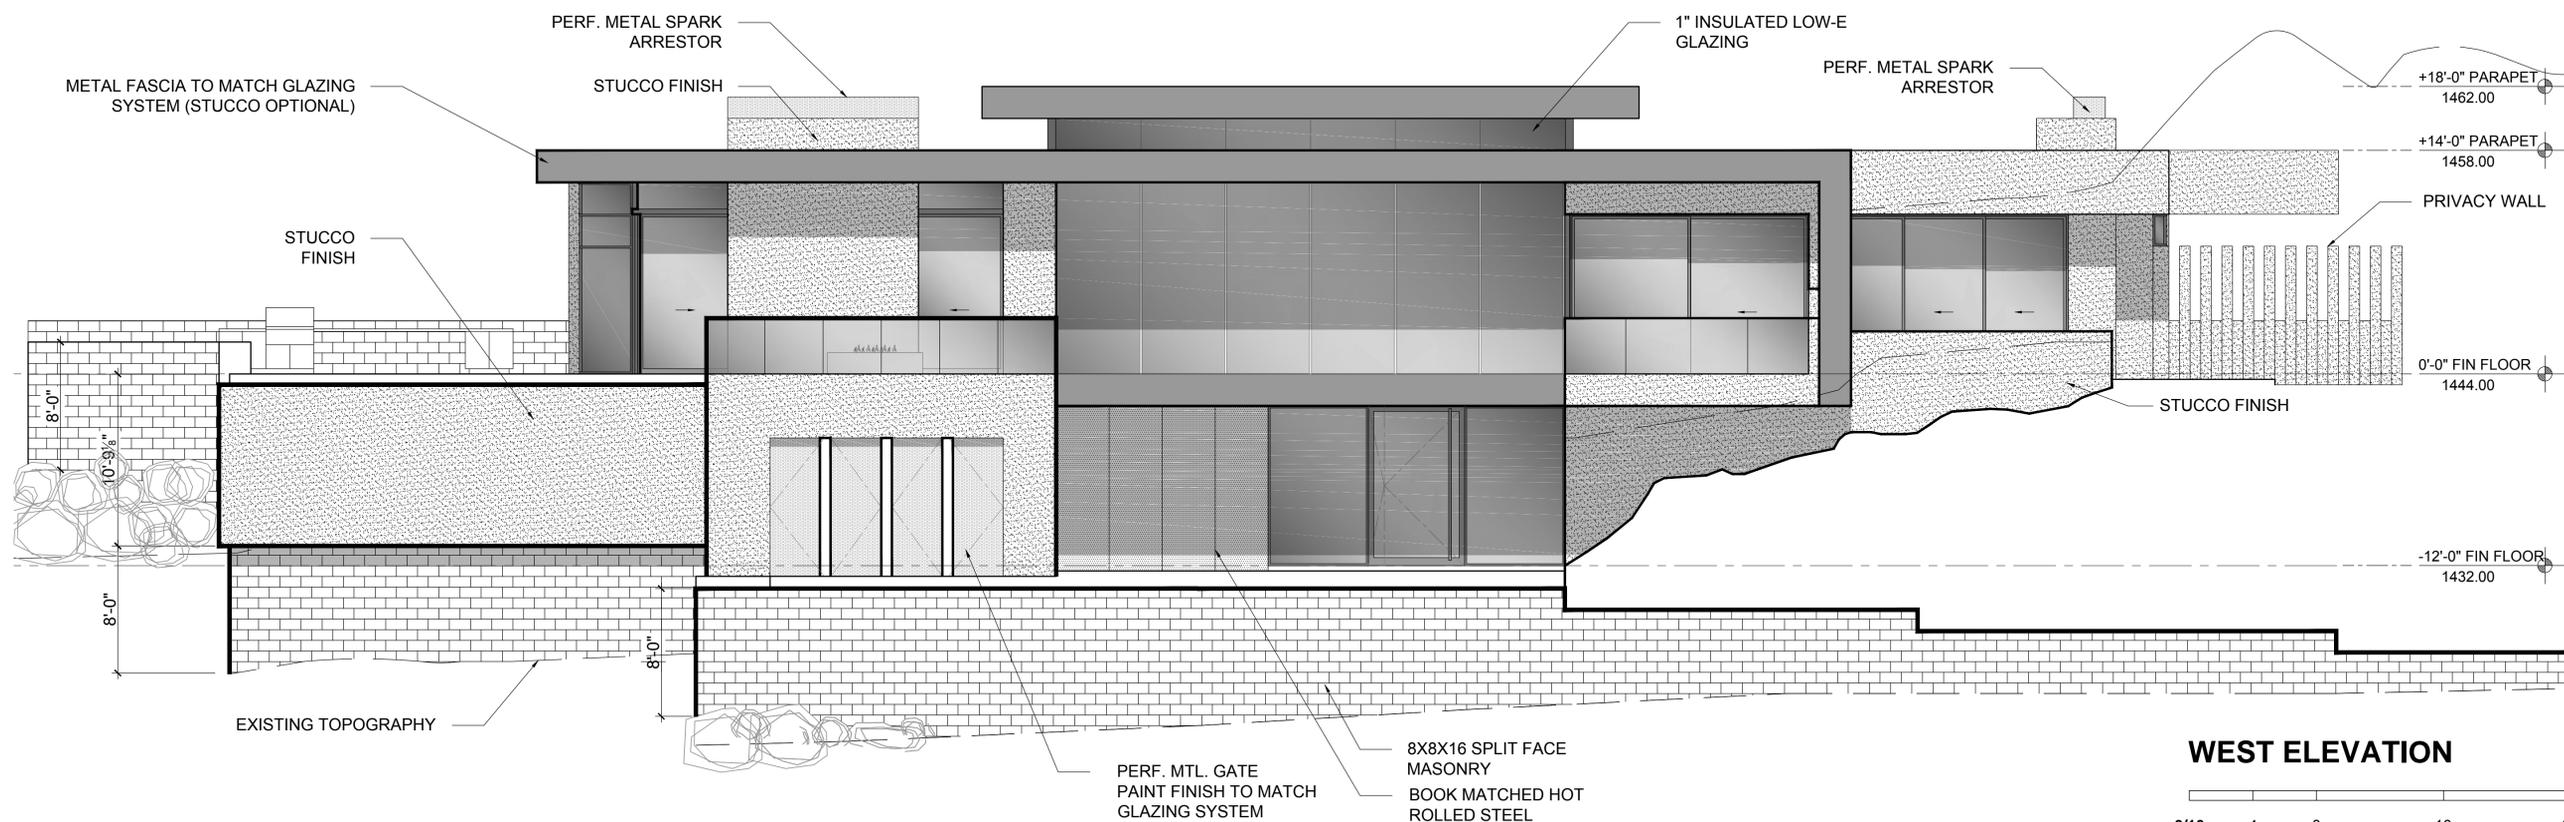
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Residence

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SOUTH ELEVATION



WEST ELEVATION

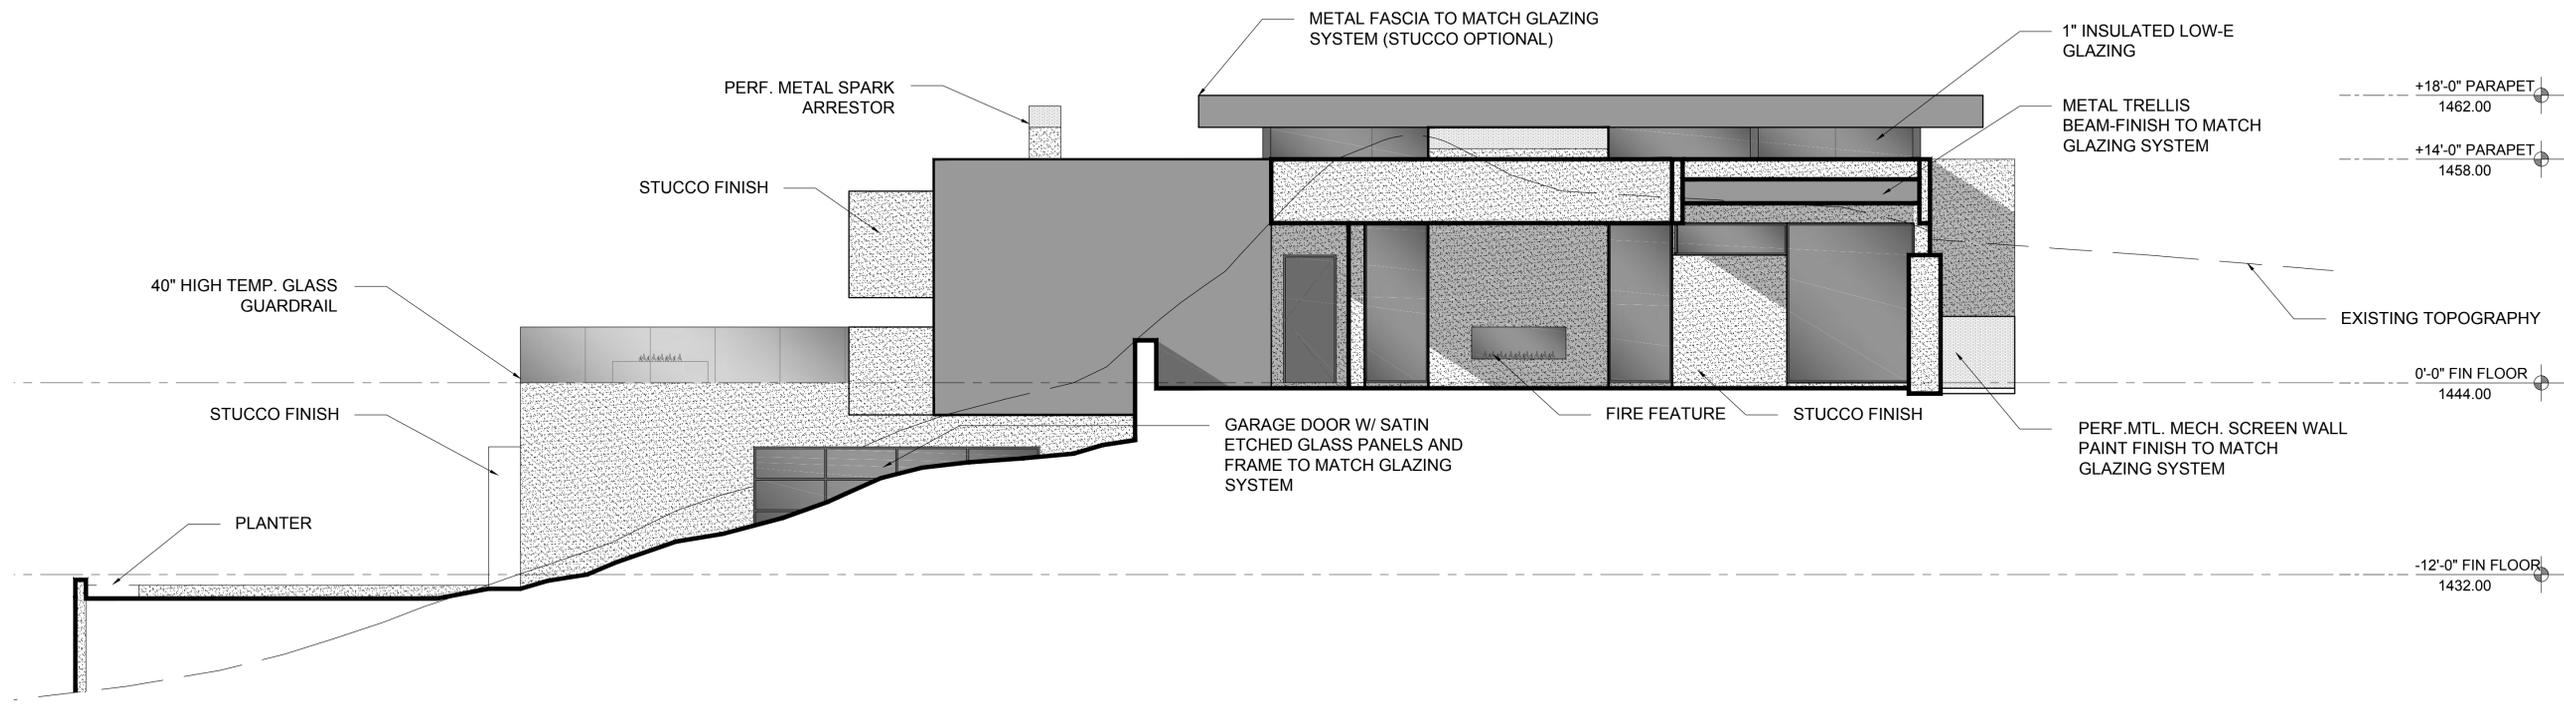

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SHEET TITLE:

**EXTERIOR
ELEVATIONS**

A-4.0



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MARK	DATE	DESCRIPTION

ISSUE: 9/19/17 - CONCEPT REVIEW

PROJECT NO:

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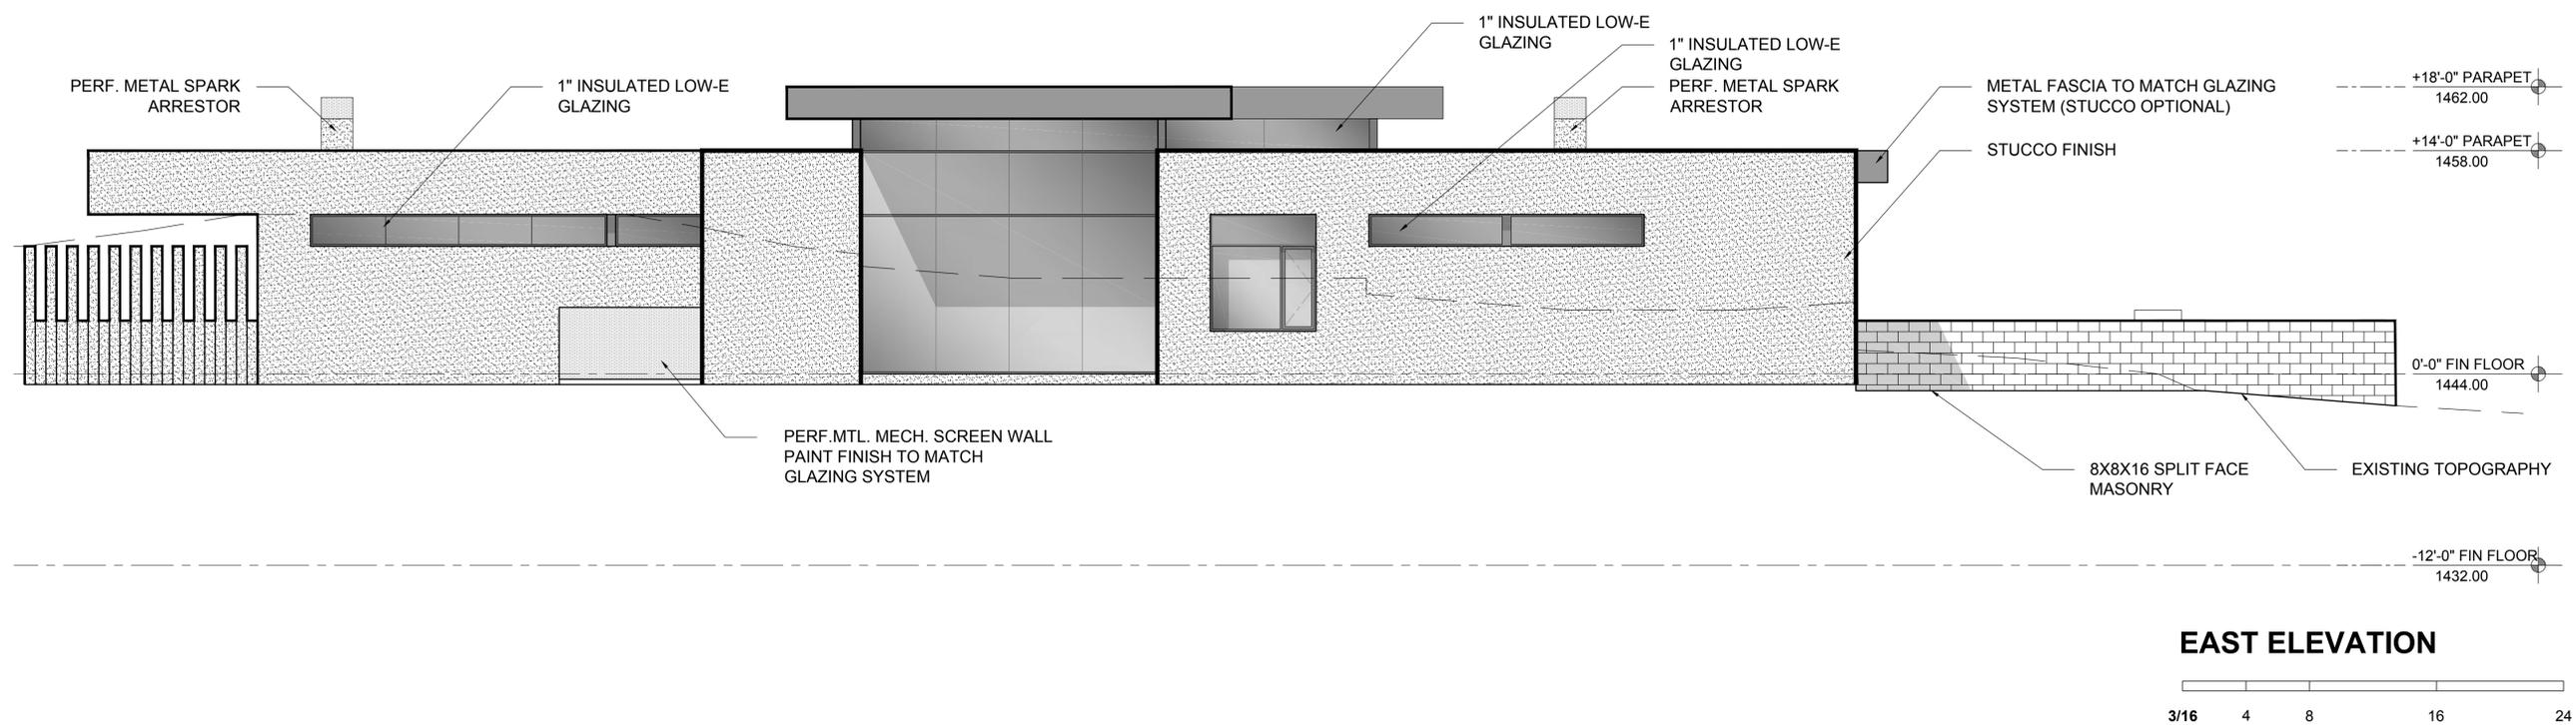
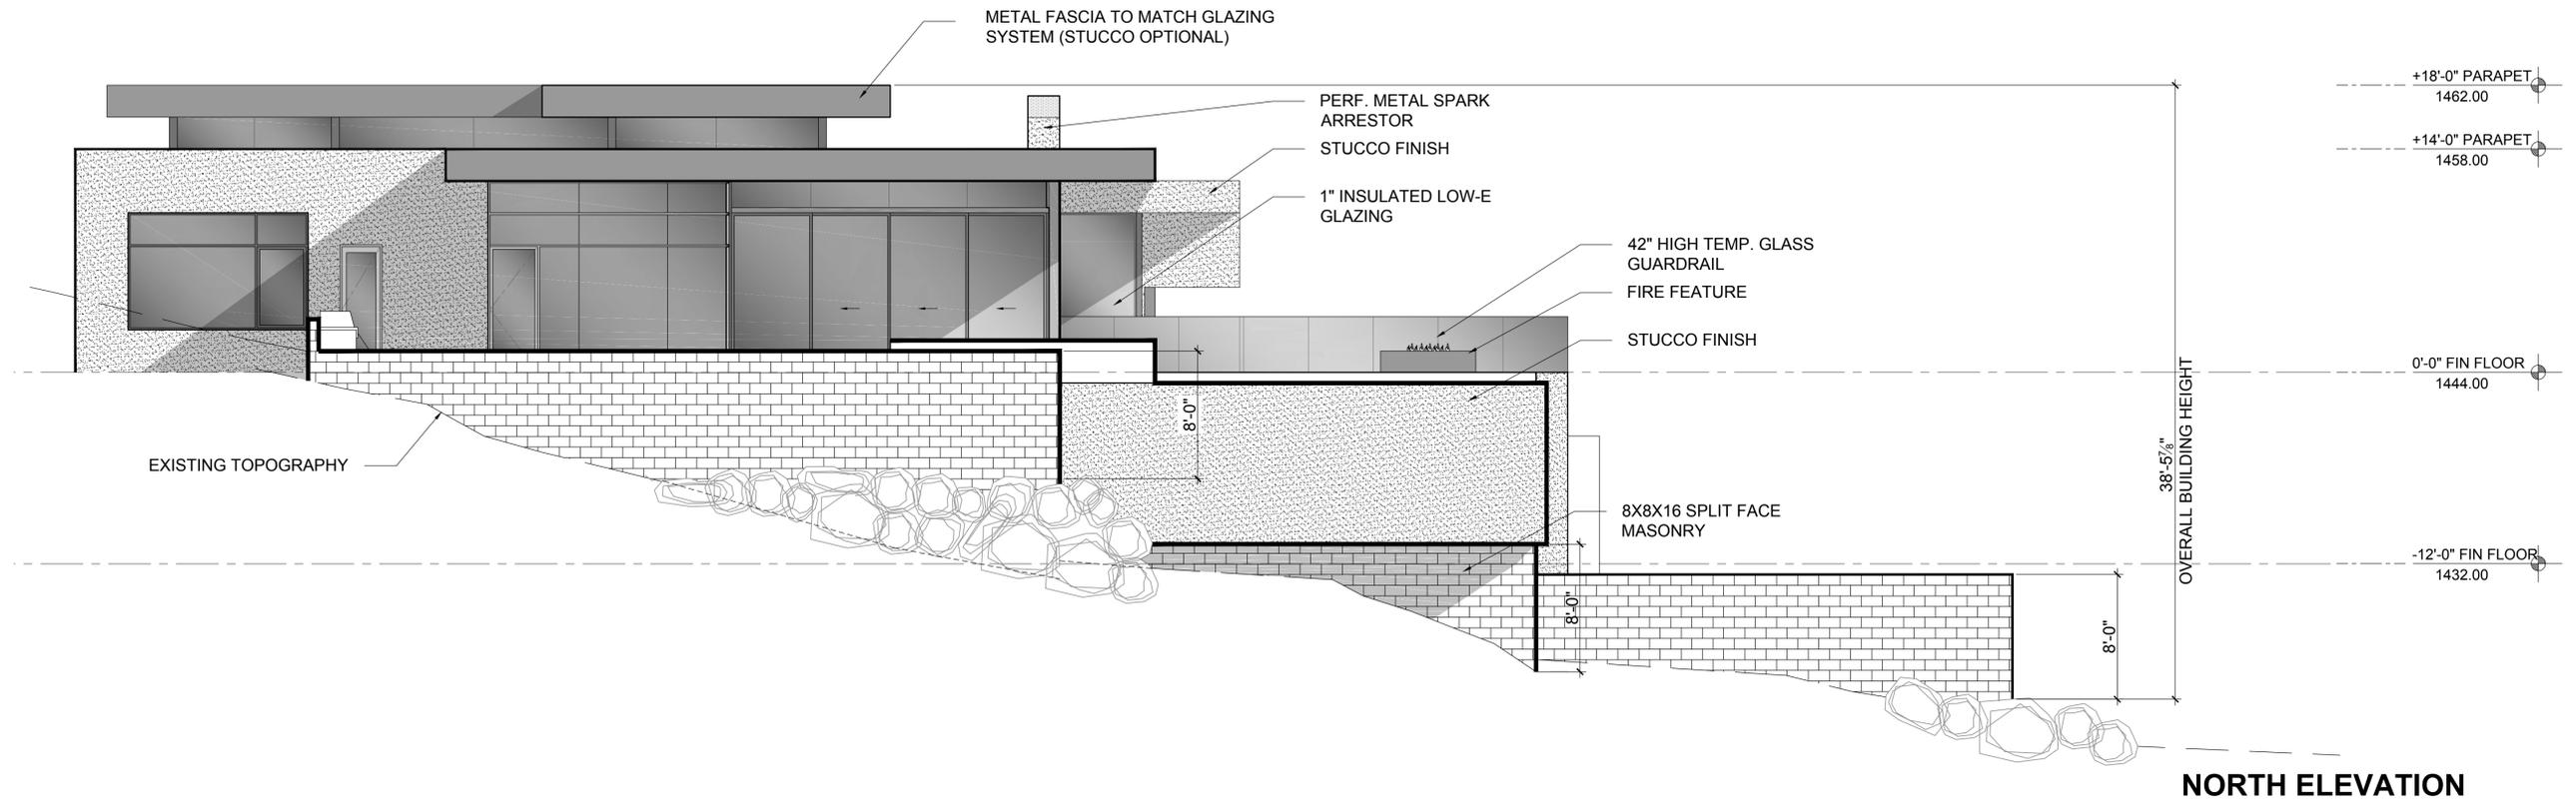
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CHECKED BY: BK

SHEET TITLE:

EXTERIOR ELEVATIONS

A-4.1






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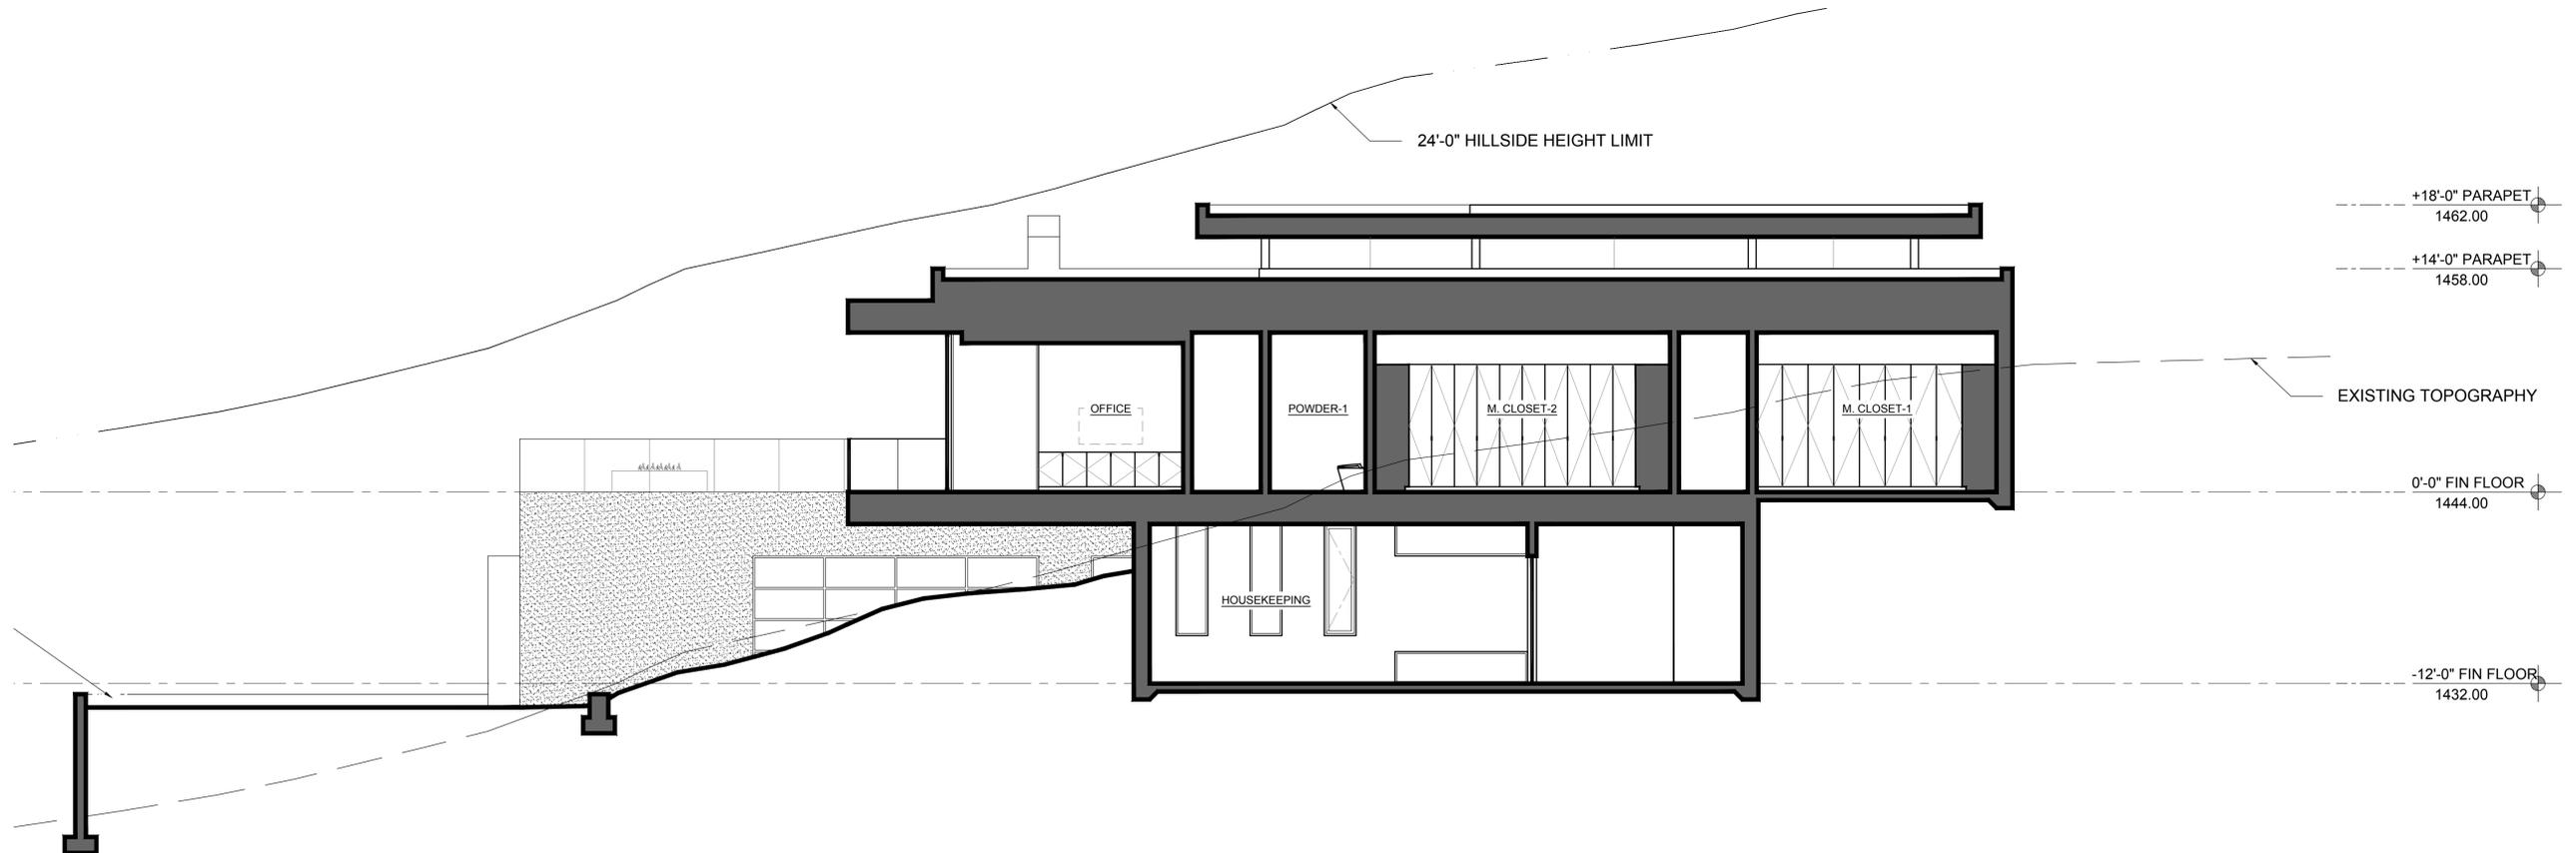
6115 NORTH CATTLETRACK
SCOTTSDALE, ARIZONA 85250
PH 480.951.8558
BRENT@KENDLEDESIGN.COM
KENDLEDESIGN.COM

Scherr Residence

5416 E. Desert Jewel Drive,
Paradise Valley, AZ
85253

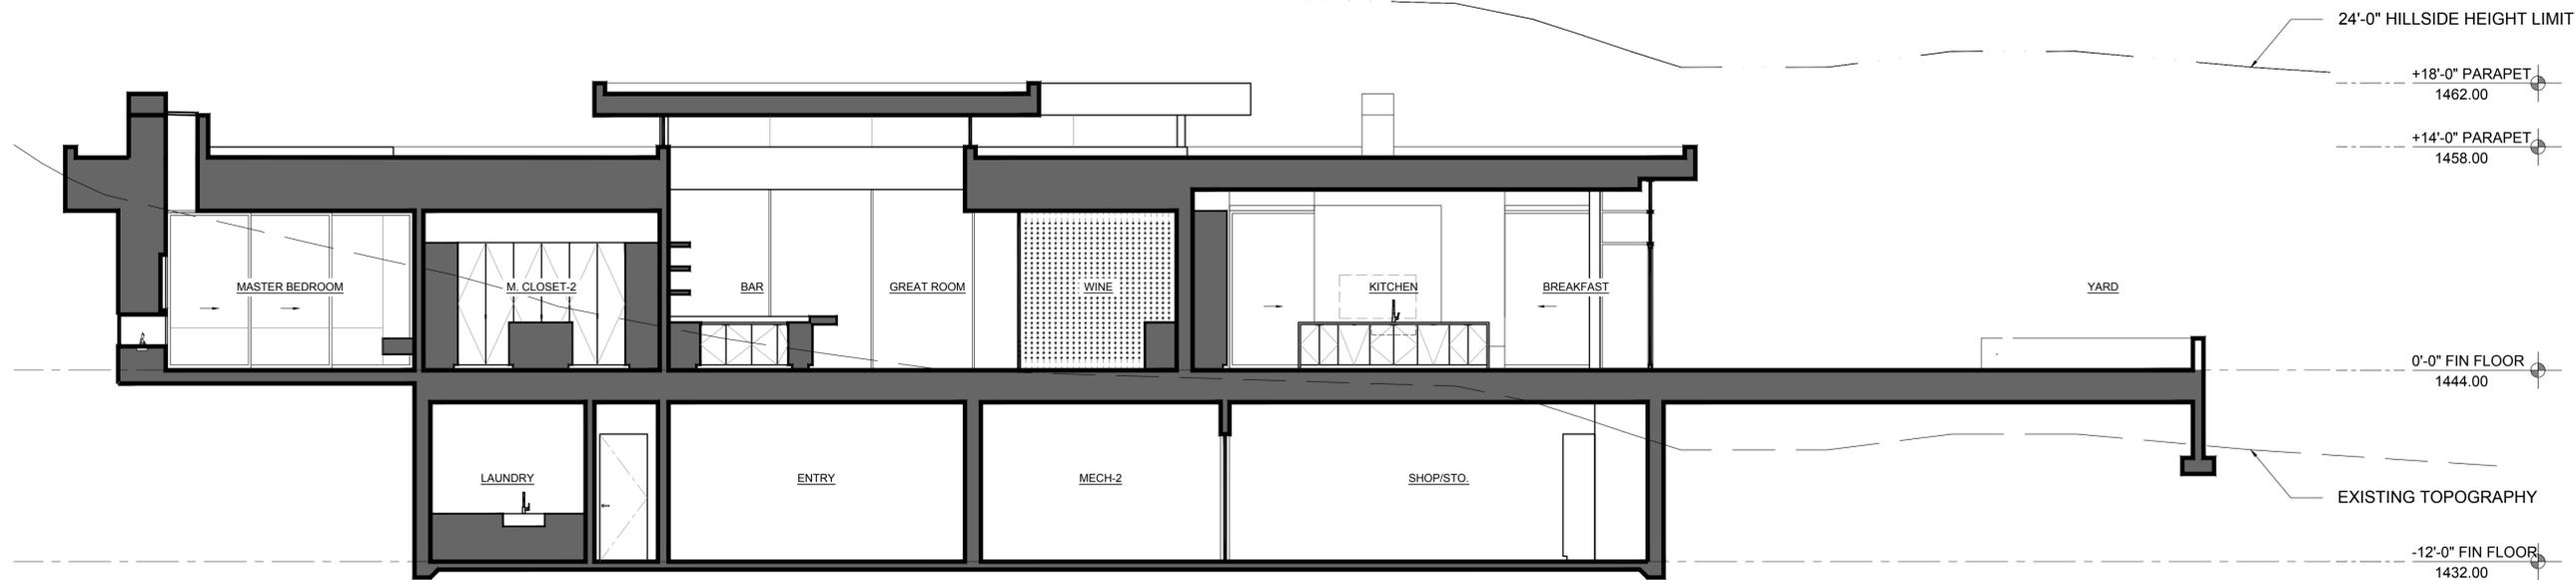

SECTION A



SECTION B



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PROJECT NO:

CAD DWG FILE:

DRAWN BY: CK

CHECKED BY: BK

SHEET TITLE:

BUILDING SECTIONS

A-5.0



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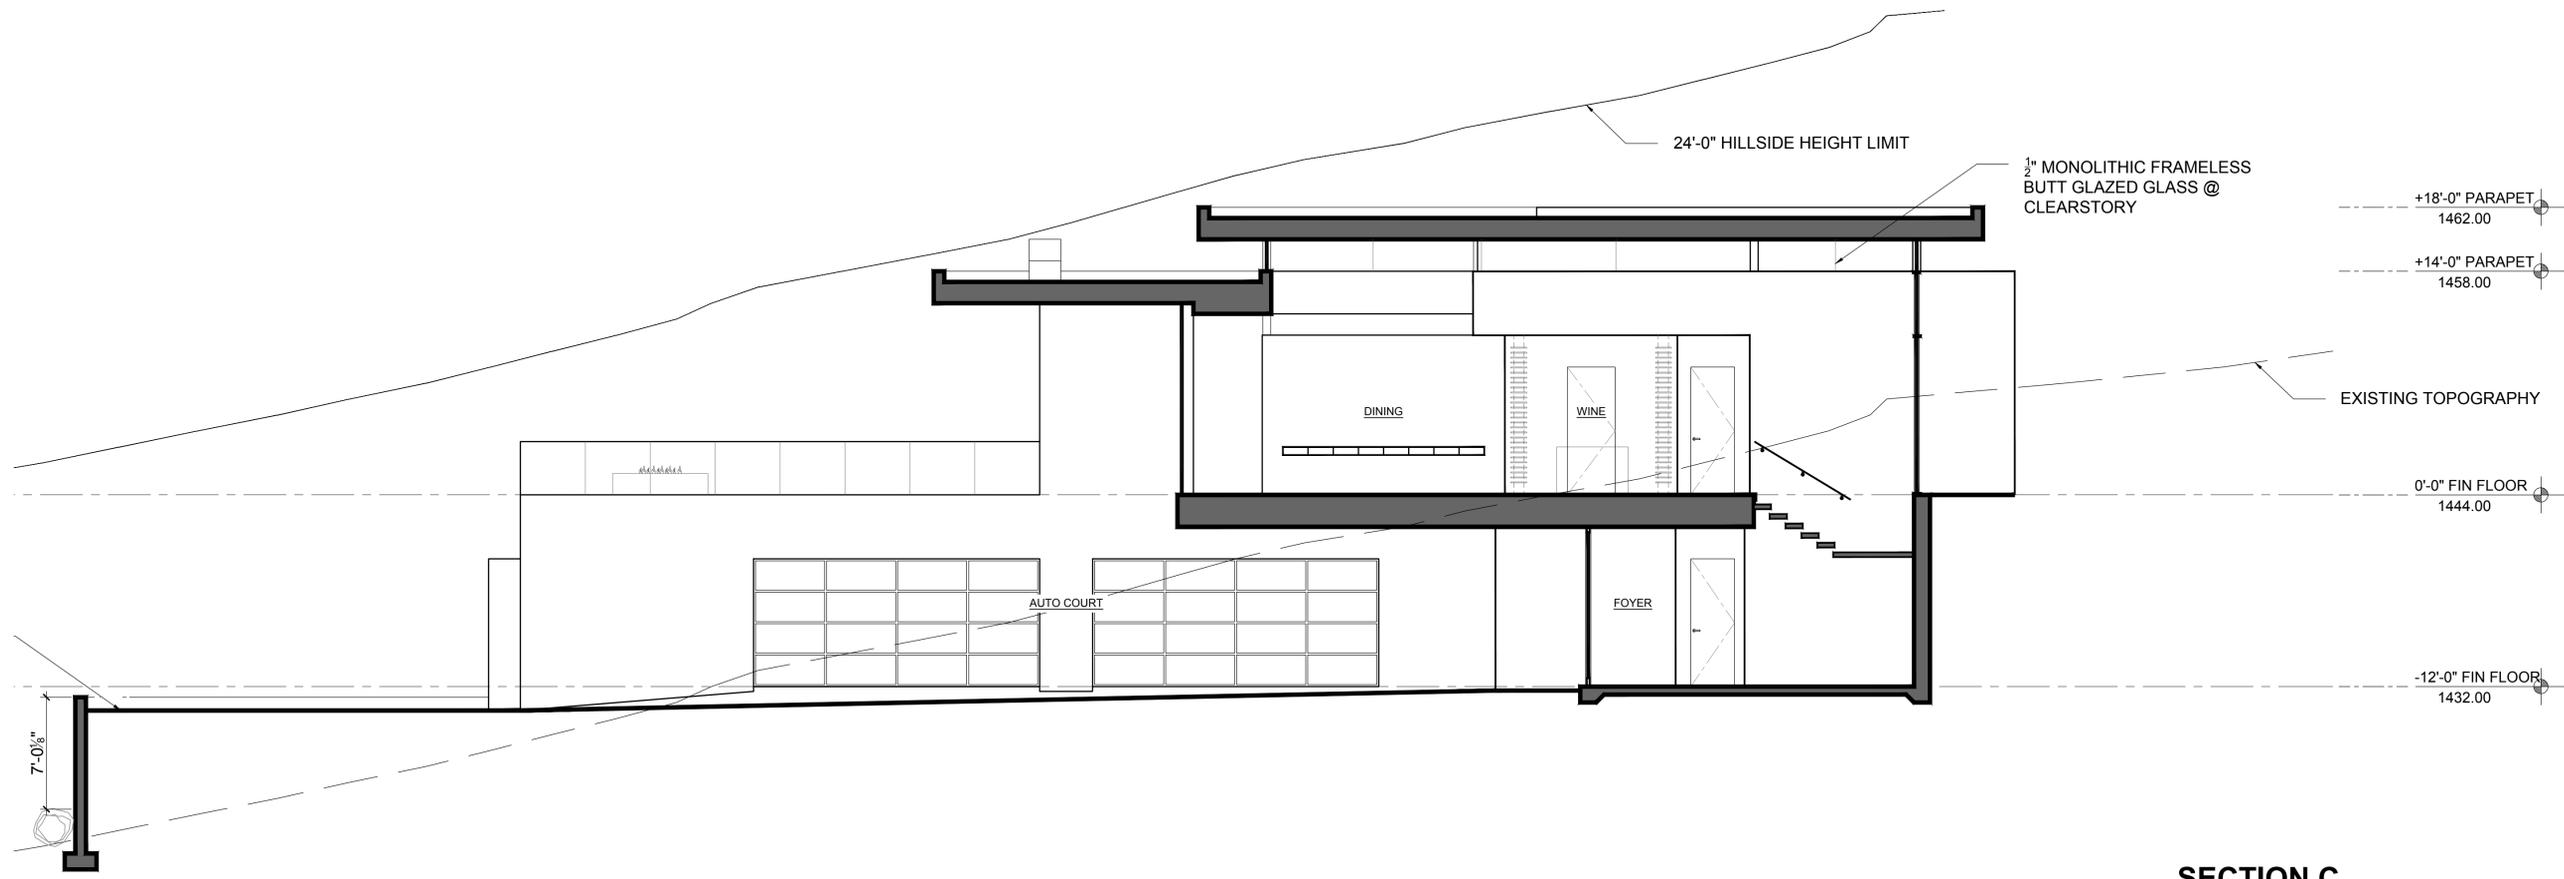
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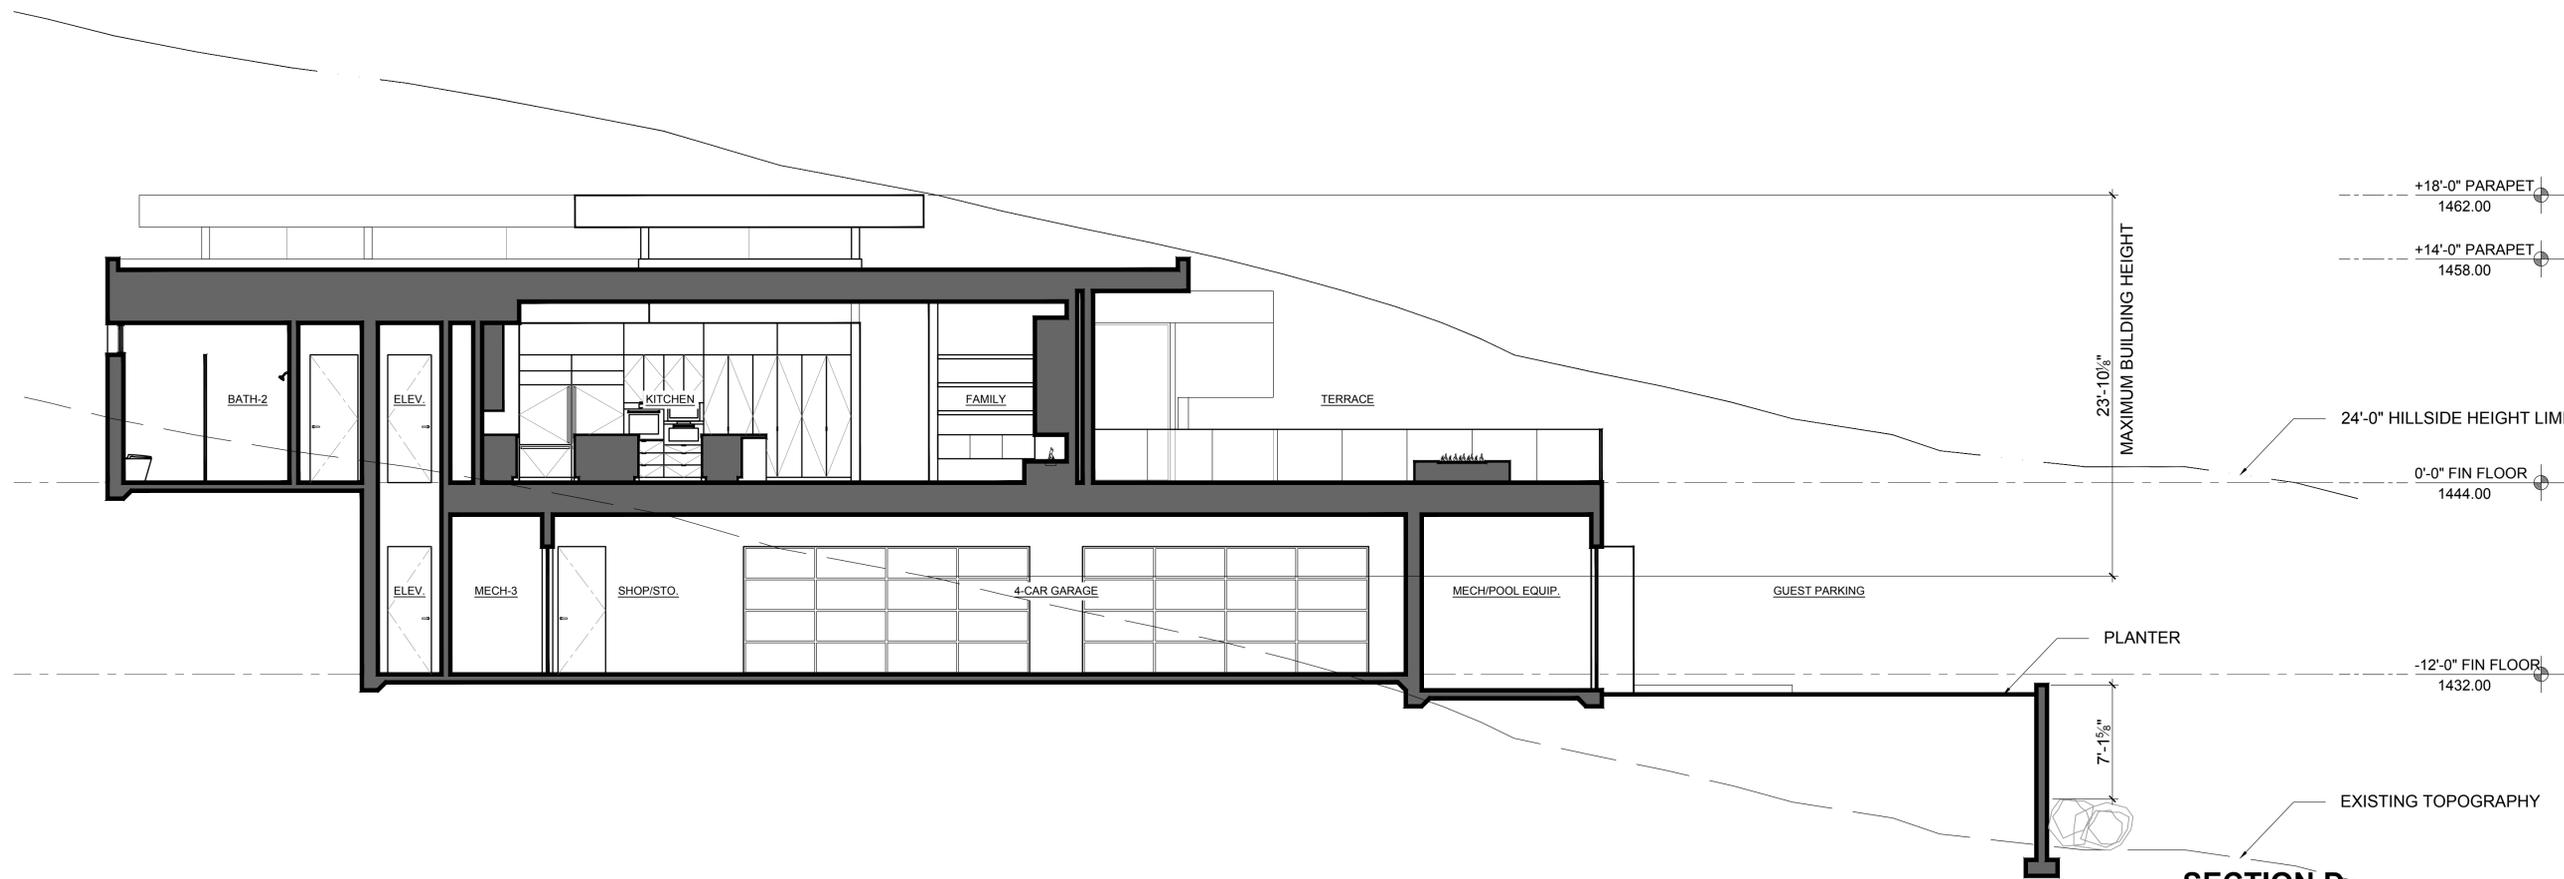
SHEET TITLE:

BUILDING SECTIONS

A-5.1



SECTION C



SECTION D





VIEW 1



VIEW 2



VIEW 3



VIEW 4



VIEW 5




VIEW 6



VIEW 7



VIEW 8

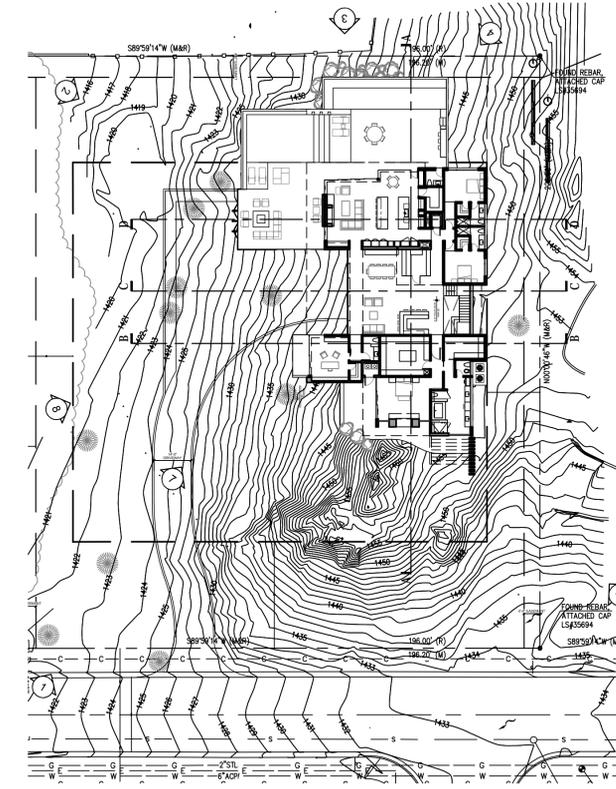

KEY PLAN



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ISSUE: 9/19/17 - CONCEPT REVIEW

PROJECT NO:

CAD DWG FILE:

DRAWN BY: CK

CHECKED BY: BK

SHEET TITLE:

MASSING
MODEL

A-6.0



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CAD DWG FILE:

DRAWN BY: CK

CHECKED BY: BK


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EXTERIOR MATERIALS

A-7.0

HARDSCAPE
TO MATCH INTERIOR: TBD
LRV: TBD

METAL 1
KYNAR 500 COLOR: MATTE BLACK
LRV: 2.5

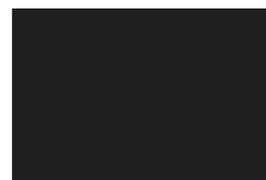

FLAT ROOF
DURO-LAST SINGLE PLY ROOF
MEMBRANE. COLOR: DARK GREY
LRV: 25



GUARDRAIL
42" HIGH TEMP. GLASS, CLEAR



PERMEABLE PAVERS
TBD



SPLIT FACE CMU
TBD



STUCCO
SMOOTH SAND FINISH. MATCH BENJAMIN
MOORE HC-166 KENDALL CHARCOAL
LRV: 12.6



STUCCO
SMOOTH SAND FINISH. MATCH BENJAMIN
MOORE AF-675 FUSION
LRV: 36.3



GARAGE DOORS
TRANSLUCENT PANELS W/ FRAME
TO MATCH METAL 2



HOT ROLLED STEEL
TBD



METAL 2
PAINTED TO MATCH WINDOW SYSTEM
FINISH
LRV: 2.5



GLAZING
CLEAR, LOW-E INSULATED GLAZING
IN DARK BRONZE ANODIZED FRAME

